

**SANITARY SEWER & WATER MAIN GENERAL NOTES:**

SANITARY LATERALS SHALL BE EXTENDED TO AT LEAST TEN (10) FEET BEYOND THE PROPERTY / RIGHT-OF-WAY LINE OR TO THE EDGE OF THE EASEMENT WHICHEVER IS GREATER.

IF METER PITS CANNOT BE INITIALLY INSTALLED AT THE LOCATION SHOWN ON THE TYPICAL SECTION, A CURB STOP CAN BE SETUP AT THIS LOCATION.

WATER MAIN MATERIALS, VALVES, FIRE HYDRANTS, FITTINGS AND APPURTENANCES AND INSTALLATION TO BE AS PER BUTLER COUNTY SPECIFICATIONS, USING CLASS 53 DUCTILE IRON AS PER AWWA C-151 WITH FOUR (4) MINIMUM COVER.

SANITARY SEWER MATERIALS AND INSTALLATION TO BE PER BUTLER COUNTY SPECIFICATIONS SECTION 3110 FOR PVC, SDR-35 & 26 PIPE; SECTION 3140 FOR ABS OR PVC COMPOSITE PIPE. SECTION 3410 FOR MANHOLES.

ROOF DRAINS, FOUNDATION DRAINS, AND OTHER CLEAN WATER CONNECTIONS TO THE SANITARY SEWER SYSTEM ARE PROHIBITED.

ALL BUILDINGS TO BE SERVED BY THE PUBLIC SEWER SYSTEM SHALL BE CONSTRUCTED SO TO PROVIDE A MINIMUM OF FOUR (4) FEET OF VERTICAL SEPARATION BETWEEN THE PUBLIC SANITARY SEWER SYSTEM, AT THE POINT OF CONNECTION, AND THE LOWEST BUILDING LEVEL SERVED BY A GRAVITY SEWER CONNECTION. IN ADDITION, SAID BUILDING LEVEL SHALL BE AT LEAST ONE (1) FOOT ABOVE THE LOWEST POINT OF FREE-OVERFLOW (NON-SEALED MANHOLE COVER) UPSTREAM OF ANY TREATMENT FACILITY OR WASTEWATER PUMPING FACILITY THAT RECEIVES THE DISCHARGE FROM SAID BUILDING. SAID MINIMUM SERVICE LEVELS SHALL BE RECORDED ON THE "AS-BUILT" PLANS FOR THE DEVELOPMENT WHICH WILL BE KEPT ON FILE IN THE OFFICE OF THE BUTLER COUNTY WATER AND SEWER DEPARTMENT.

BUTLER COUNTY WATER AND SEWER DEPARTMENT DOES NOT ACCEPT ANY RESPONSIBILITY FOR THE RELOCATION, REPAIR, OR REPLACEMENT OF ANY UTILITY INSTALLED WITHIN FIVE (5) FEET OF THE CENTER LINE OF ANY SANITARY SEWER MAIN OR WATER MAIN.

ALL WATER MAIN VALVES TO HAVE A MINIMUM DEPTH OF TWO AND ONE HALF (2.5) AND A MAXIMUM OF 4.0 FEET FROM PROPOSED GRADE TO THE TOP OF THE VALVE OPERATING NUT.

ALL SANITARY SEWERS LATERALS SHALL BE AT LEAST FOUR (4) FEET BELOW THE BASEMENT FLOOR ELEVATION AT THE POINT OF CONNECTION TO THE SEWER MAIN AND SHALL NOT EXCEED THE DEPTH OF TWELVE (12) FEET BELOW THE FINISHED GRADE AT THE END OF THE LATERAL AT THE RIGHT-OF-WAY UNLESS SPECIFICALLY AUTHORIZED BY THE COUNTY.

SANITARY SEWER LATERALS, WHICH SHALL INCLUDE ALL PIPE AND APPURTENANCES FROM THE BUILDING TO THE PUBLIC SEWER MAIN, AND THE CONNECTION TO THE PUBLIC SEWER MAIN SHALL BE CONSIDERED PRIVATE AND THE RESPONSIBILITY OF THE PROPERTY OWNER TO MAINTAIN, THE CONNECTION TO THE SEWER WOULD BE AND PIPING THAT EXTEND OUT FROM THE MAIN BARREL OF THE SEWER MAIN.

PRIVATE DRIVEWAYS, PARKING LOTS AND OTHER PAVED AREAS, EARTHEN BERMS, OR STRUCTURES SHOULD NOT BE CONSTRUCTED OVER PRIVATE WATER OR SEWER SERVICE LINES. WITHIN THE PUBLIC ROAD RIGHT-OF-WAY, OR WITHIN THE EASEMENT AREAS FOR PUBLIC UTILITIES, SHOULD THIS OCCUR, THE PROPERTY OWNER SHALL BE HELD RESPONSIBLE FOR THE PROTECTION AND REPAIR AND FOR PROVIDING ACCESS TO ANY CURB STOPS, METER PITS, MANHOLES, CLEAN-OUTS, ETC. INSTALLED IN CONJUNCTION WITH THESE PRIVATE SERVICE LINES AND FOR ANY DAMAGE OR RESTORATION OF THE PAVED SURFACES OR STRUCTURES THAT MAY RESULT FROM THE FUTURE OPERATION, MAINTENANCE, REPAIR OR REPLACEMENT OF SAID SERVICE LINES AND APPURTENANCES.

PROPERTY IS IN ZONE "X" AS SHOWN ON THE FEMA FLOOD INSURANCE RATE MAP #3901700217E & #3901700219E DATED DECEMBER 17, 2010.

BUTLER COUNTY BENCHMARK #99FC66A IS LOCATED ON THE NORTH SIDE OF KYLES STATION ROAD AT THE INTERSECTION OF LIBERTY WOODS ROAD ELEV.=722.303'

EX. ZONING - "R-SE"  
PROP. ZONING - "R-PUD"





FRONT YARD SETBACK = 30'  
FRONT YARD SETBACK CUL-DE-SACS = 35'  
SIDE YARD SETBACK = 5'  
REAR YARD SETBACK = 25'  
LOTS 1 & 44 - 50' SETBACK FROM YANKEE ROAD

GROSS AREA = 17,786.4 ACRES  
YANKEE ROAD R/W = 0.8521 ACRES  
PARCEL "C" = 0.1405 ACRES  
NET AREA = 16,793.8 ACRES  
PROPOSED OPEN SPACE = 3,482.2 ACRES  
DENSITY = 44 LOTS/16,794 ACRES=2.62 LOTS/ACRE  
LINEAR FEET OF NEW STREETS = 1,758.93 LF.

PIDN - D2010-019-000-070














# FINAL DEVELOPMENT PLAN FOR ARBOR PARK

## LIBERTY TOWNSHIP, BUTLER COUNTY, OHIO

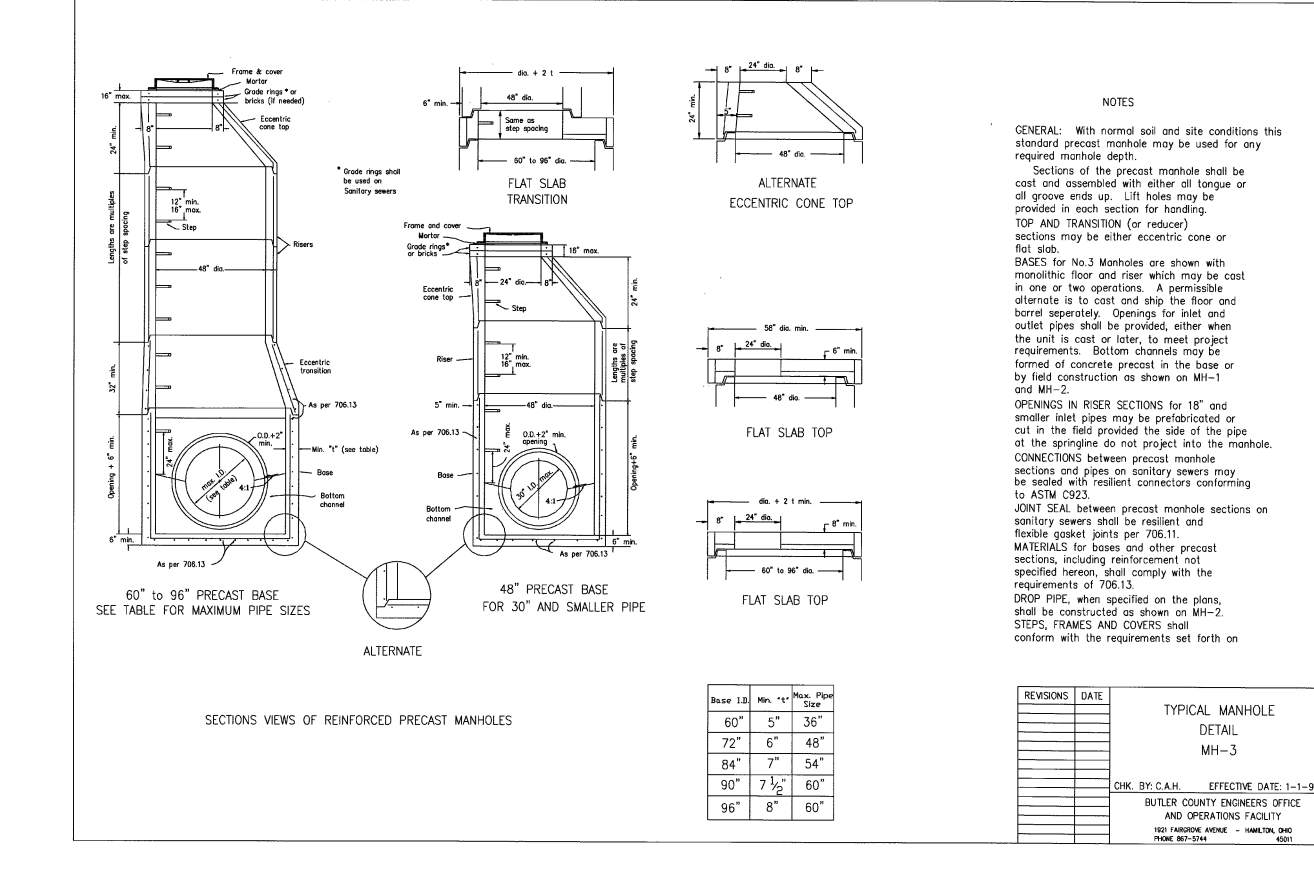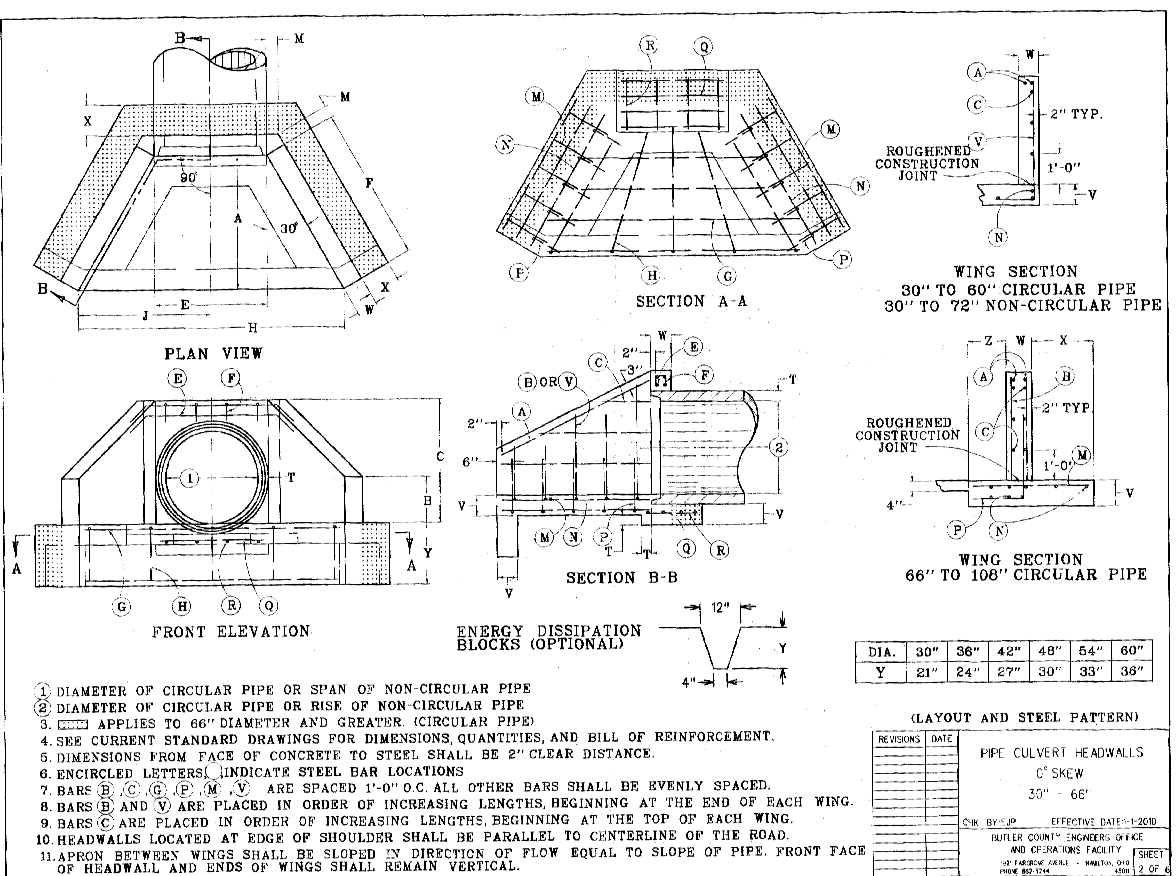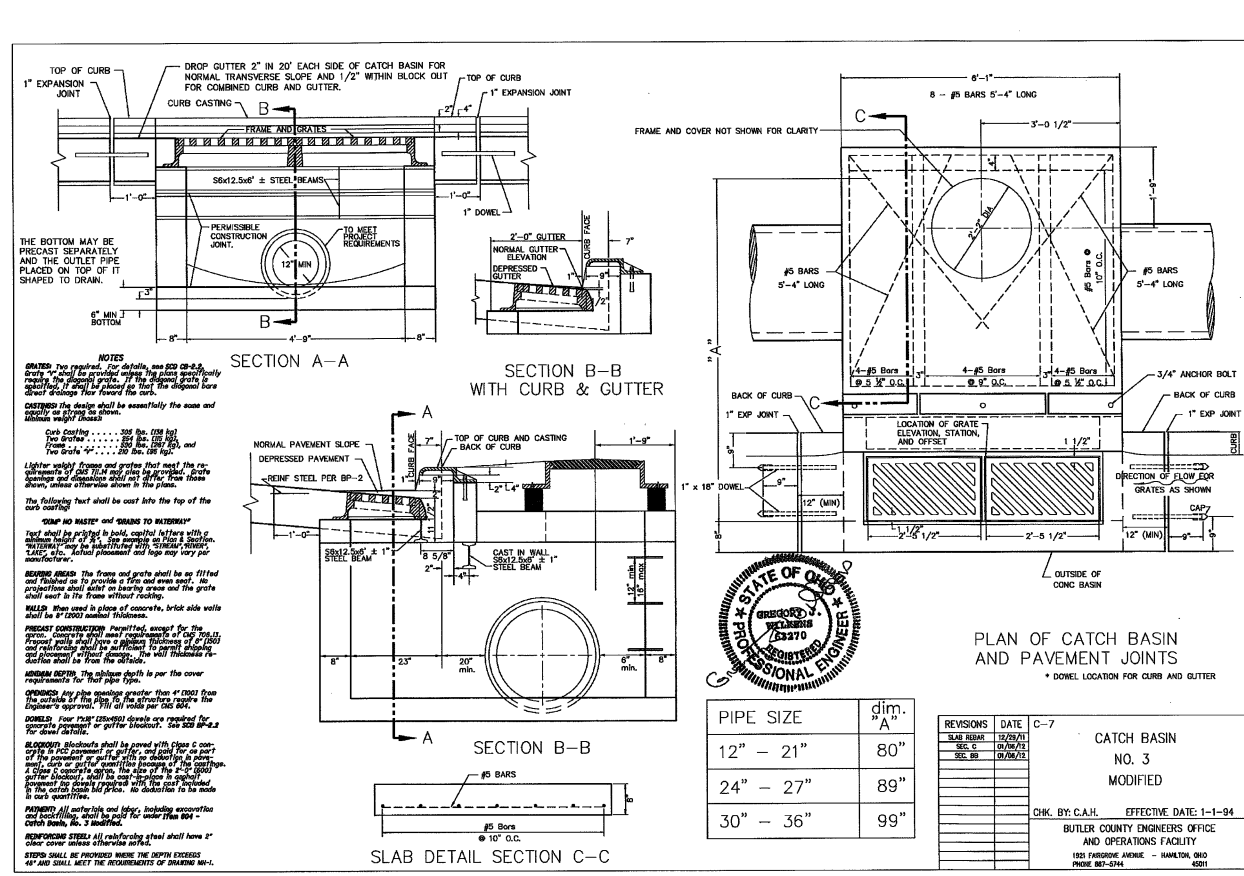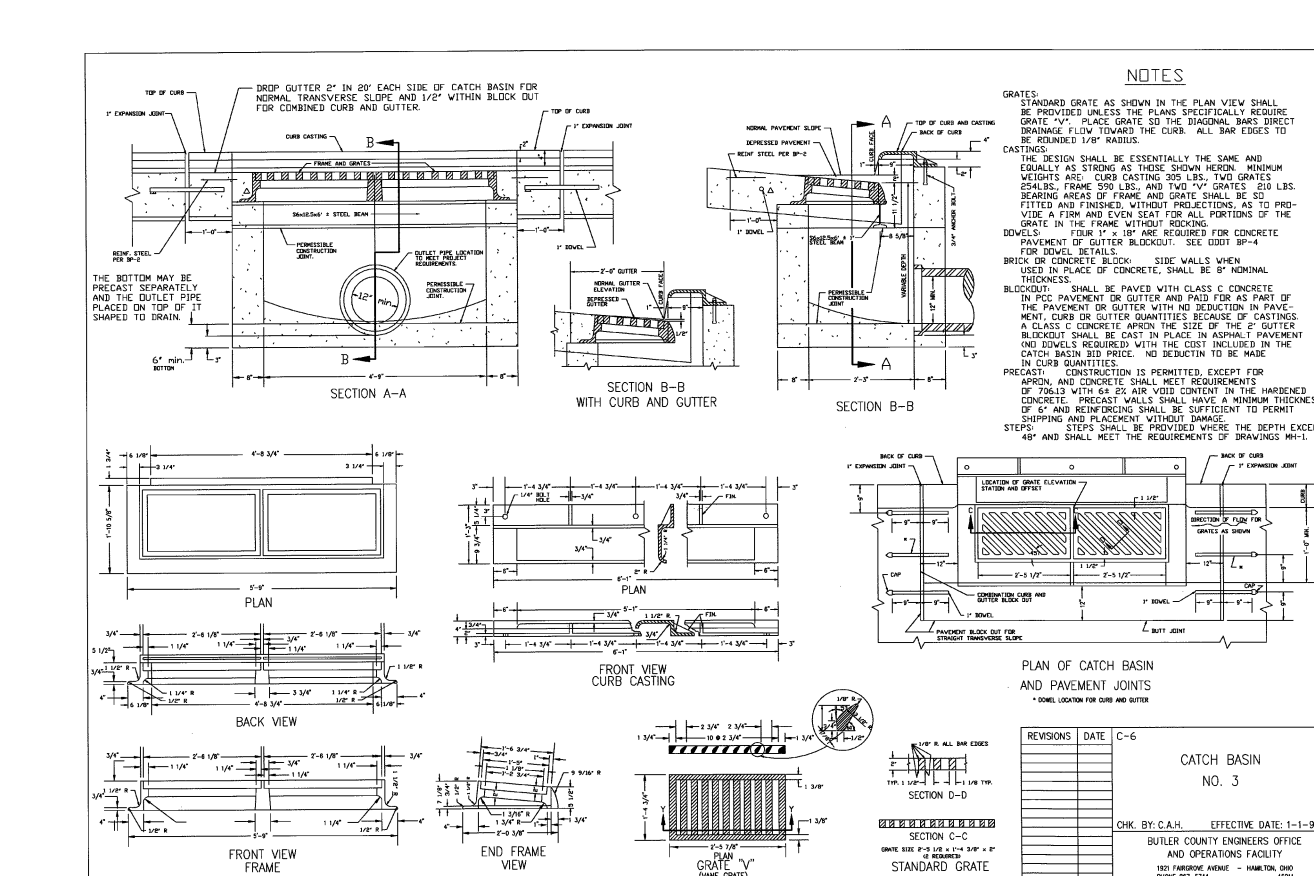


DIAMETER OF PIPE	30"	36"	42"	48"	54"	60"	66"
A	3'-9"	4'-4"	4'-11"	5'-8"	6'-11"	7'-5"	8'-0"
B	1'-3"	1'-6"	1'-9"	2'-0"	2'-3"	2'-6"	2'-9"
C	3'-6"	4'-0"	4'-7"	5'-1"	5'-8"	6'-2"	7'-0"
E	3'-1"	3'-8"	4'-3"	4'-10"	5'-5"	6'-0"	6'-7"
F	4'-4"	5'-0"	5'-8"	6'-4"	7'-0"	7'-8"	8'-7"
H	7'-6"	8'-8"	10'-0"	11'-2"	12'-6"	13'-8"	15'-2"
J	3'-9"	4'-4"	5'-0"	5'-7"	6'-3"	6'-10"	7'-7"
M	0'-3.5"	0'-4.0"	0'-4.5"	0'-5.0"	0'-5.5"	0'-6.0"	0'-6.5"
V	0'-8"	0'-8"	0'-8"	0'-8"	0'-8"	0'-8"	0'-8"
W	0'-8"	0'-8"	0'-8"	0'-8"	0'-8"	0'-8"	0'-8"
X	0'-8"	0'-8"	0'-8"	0'-8"	0'-8"	0'-8"	0'-8"
Y	0'-8"	0'-8"	0'-8"	0'-8"	0'-8"	0'-8"	0'-8"
Z	0'-8"	0'-8"	0'-8"	0'-8"	0'-8"	0'-8"	0'-8"

DIAMETER OF PIPE	30"	36"	42"	48"	54"	60"	66"
CONCRETE HEADWALLS	3.36	4.30	5.35	6.53	7.82	9.22	10.76
CONCRETE HEADWALLS	281	363	430	496	563	637	719

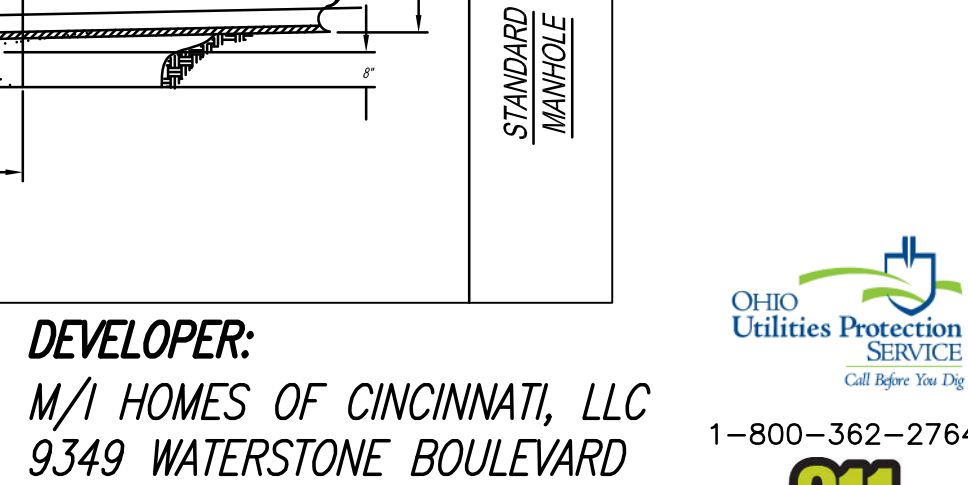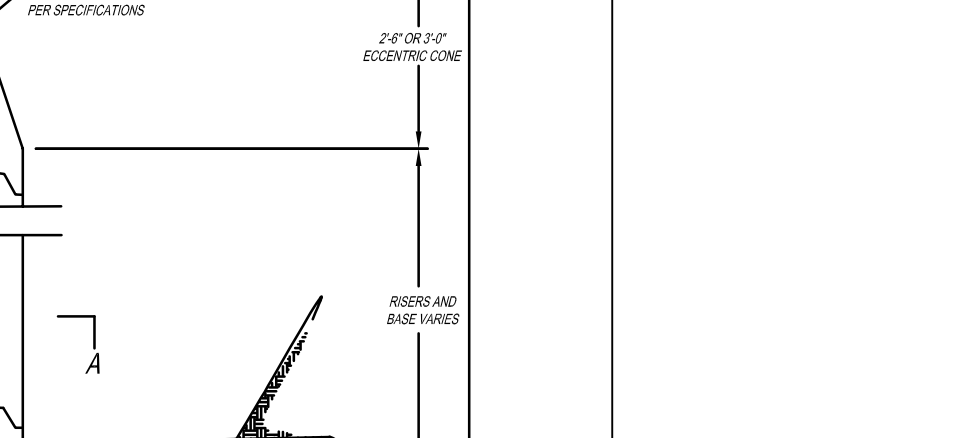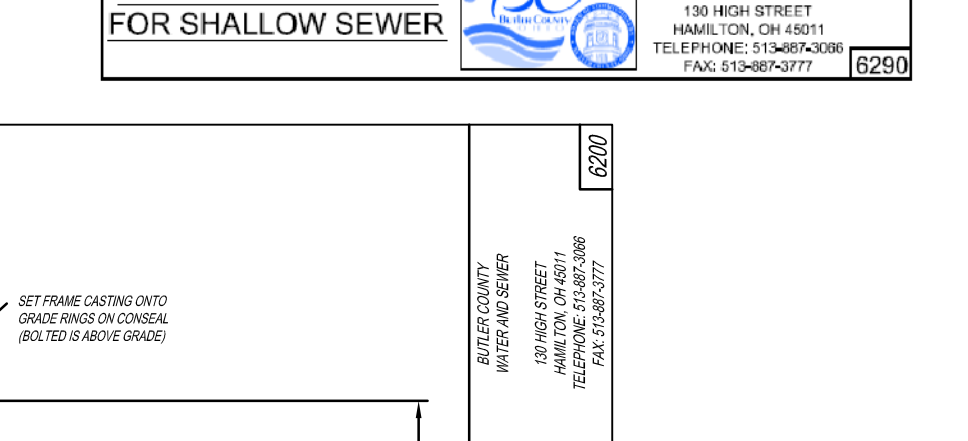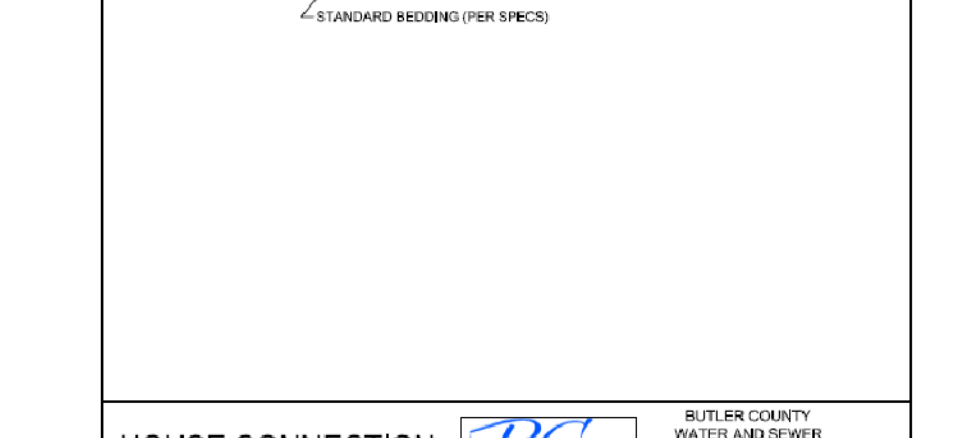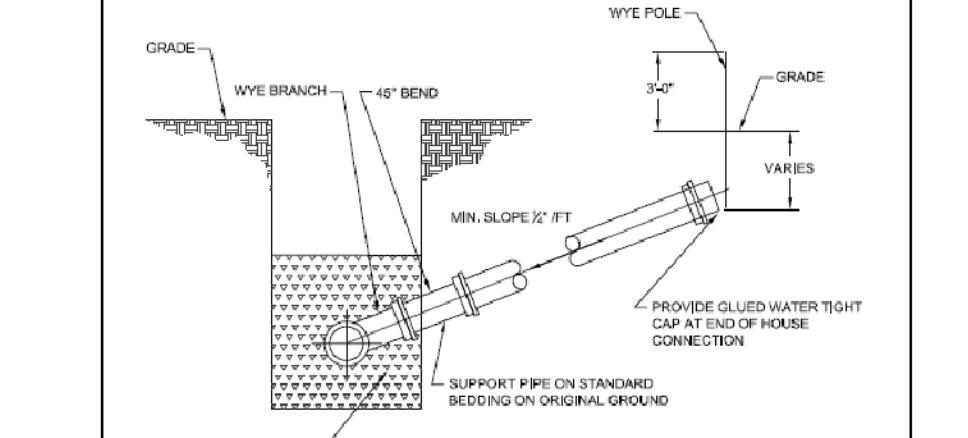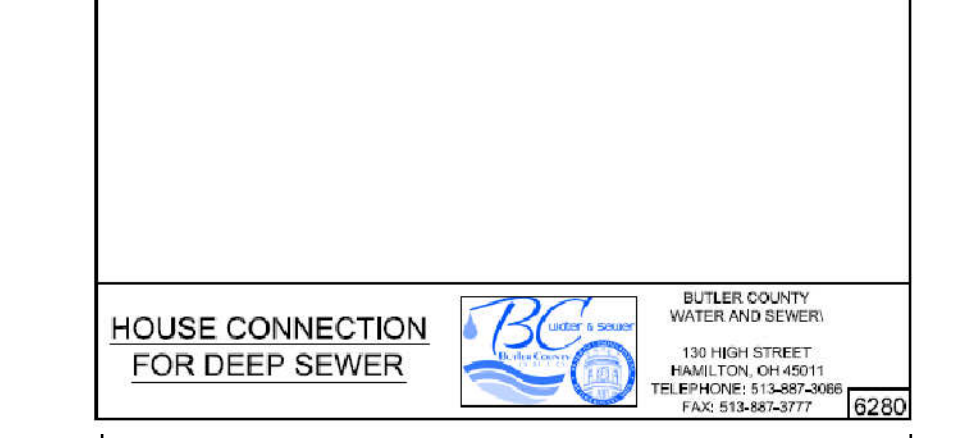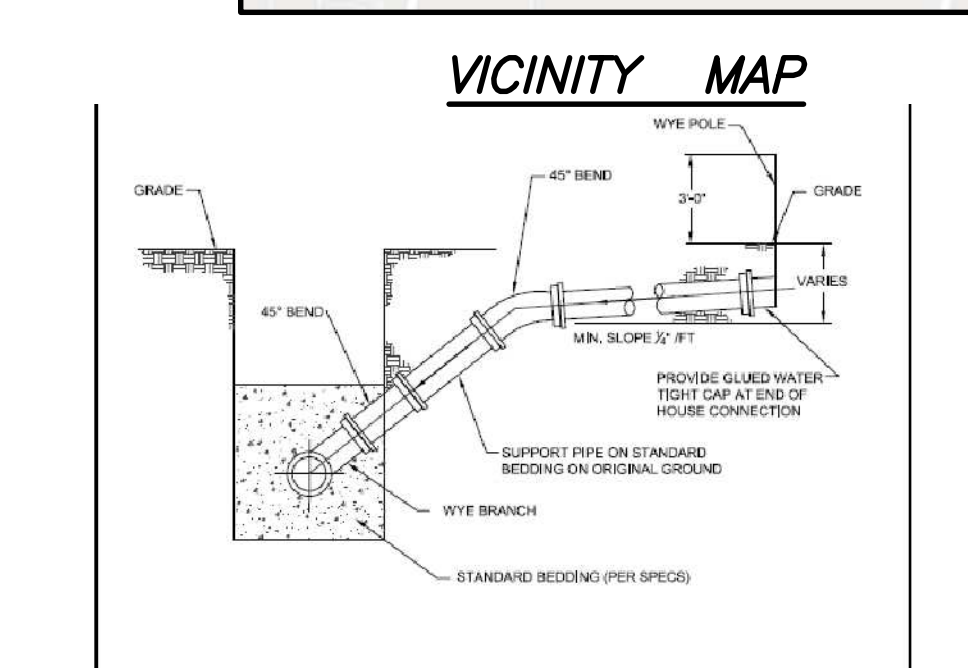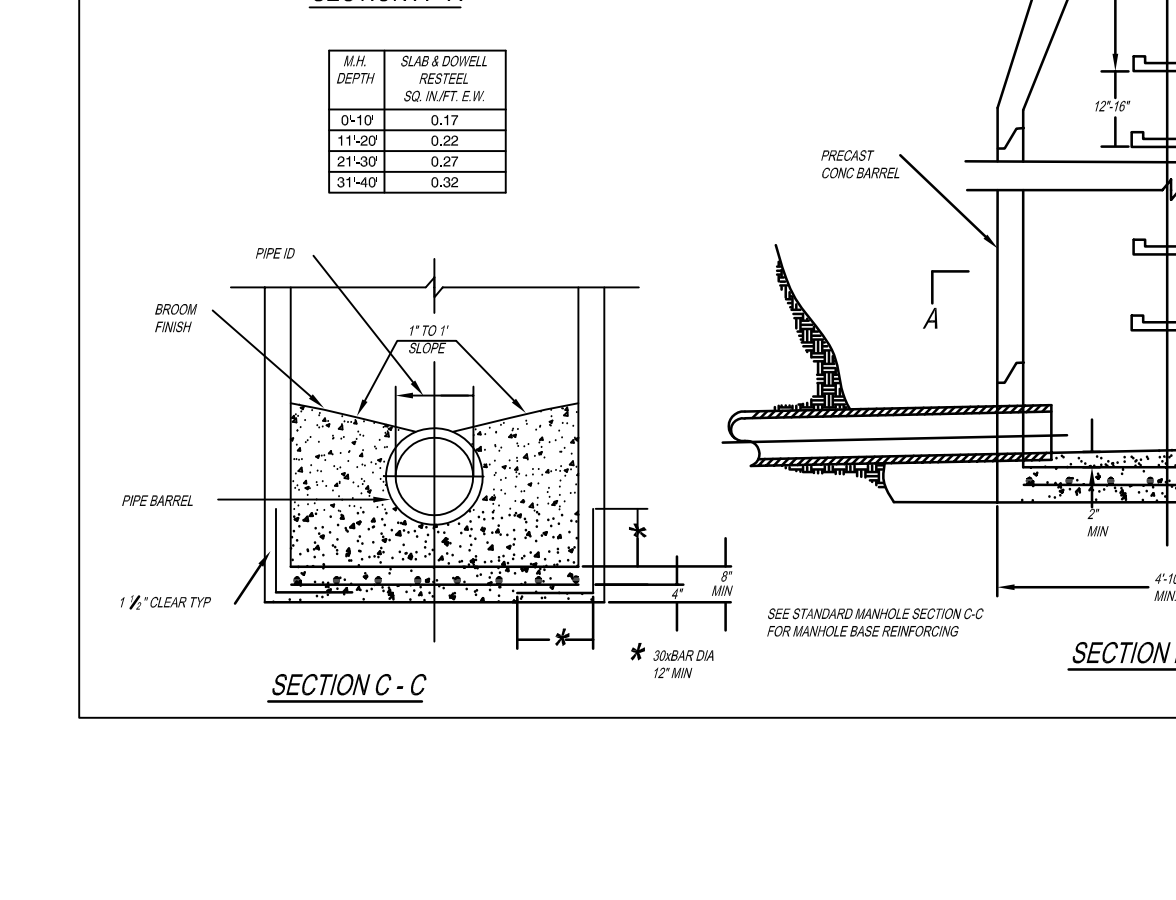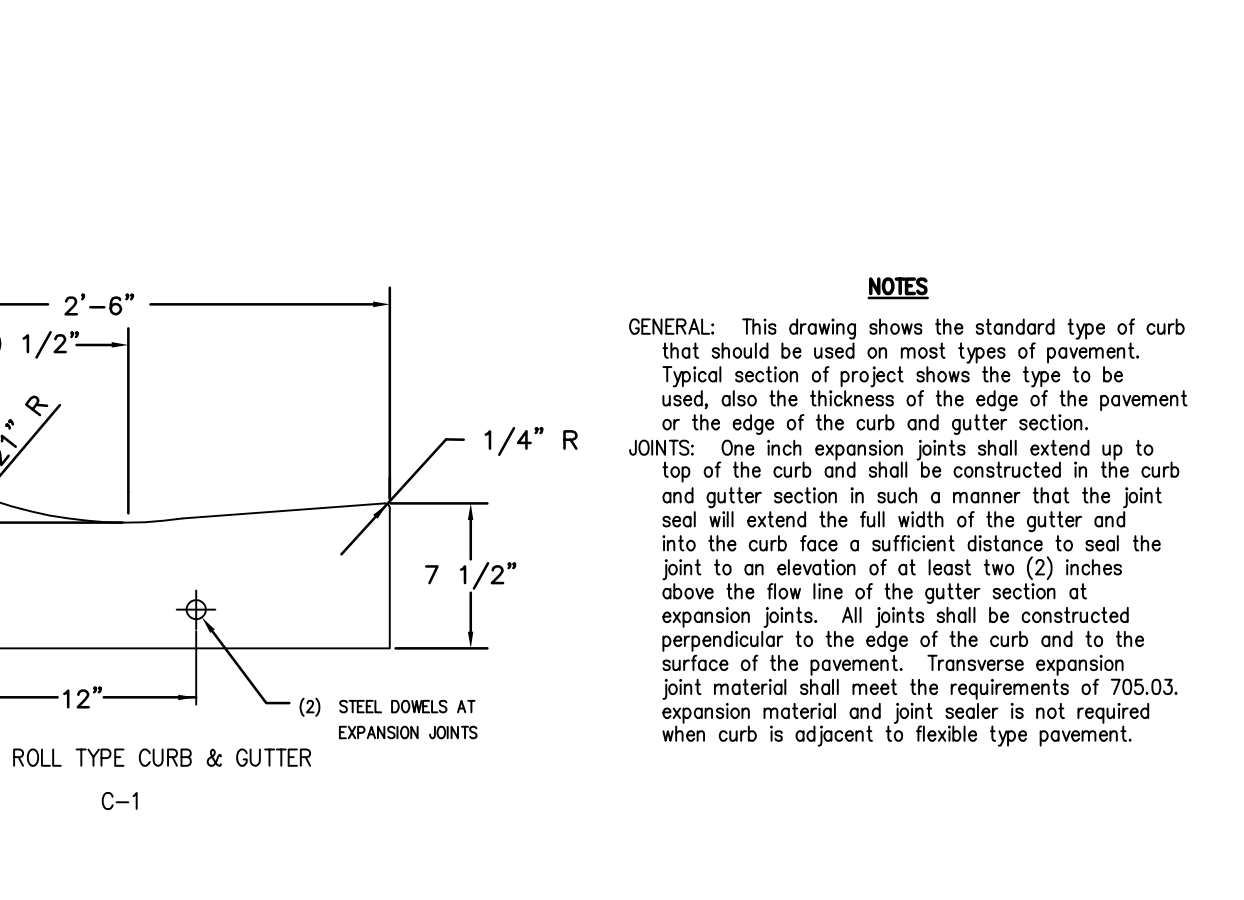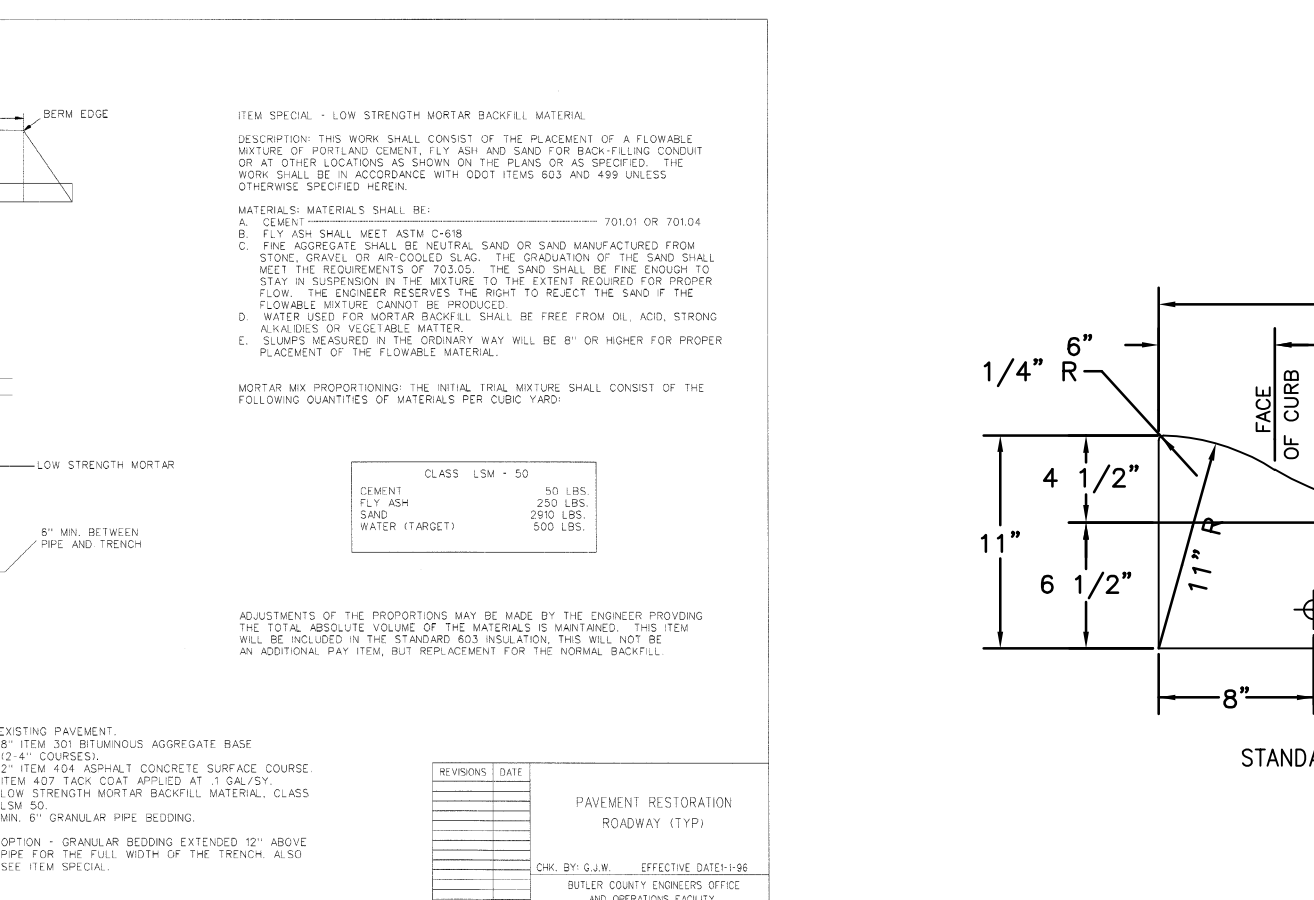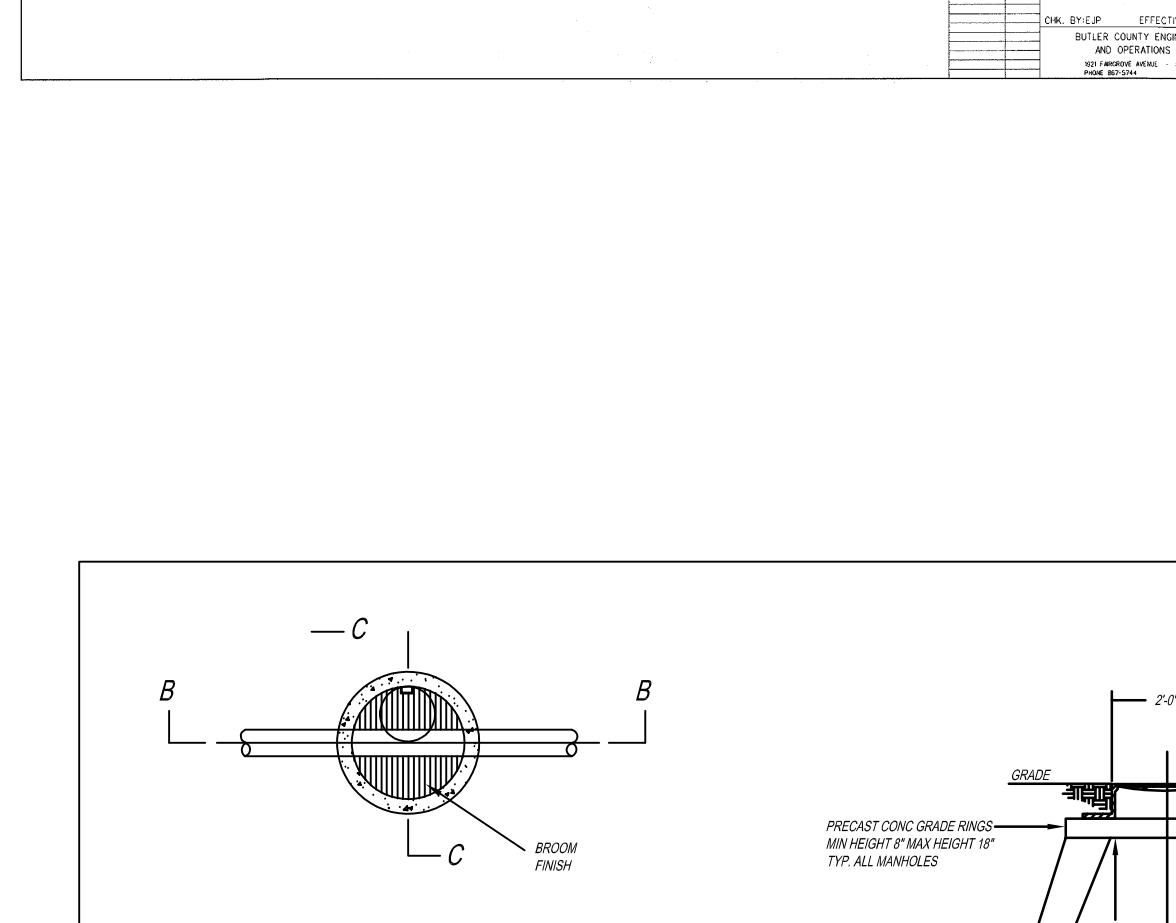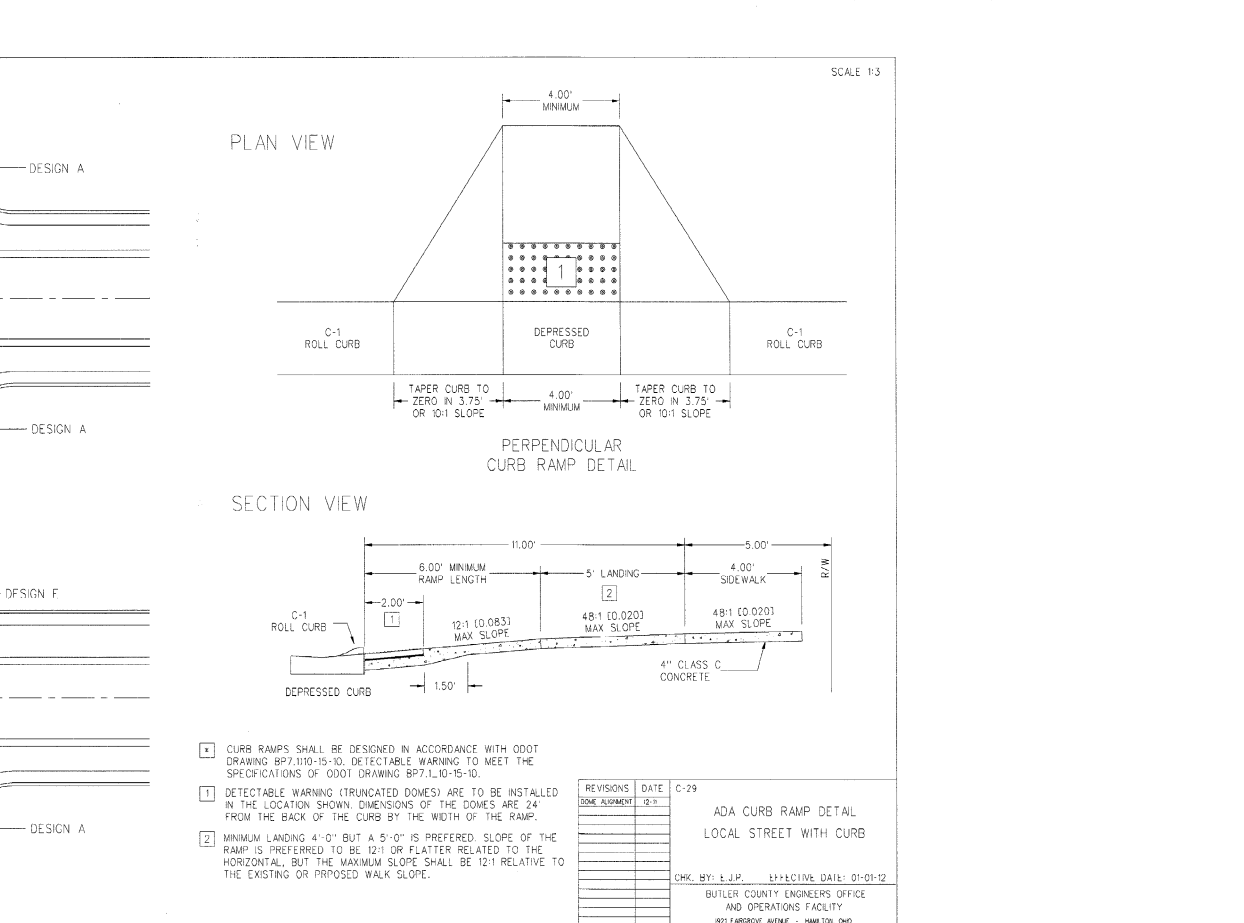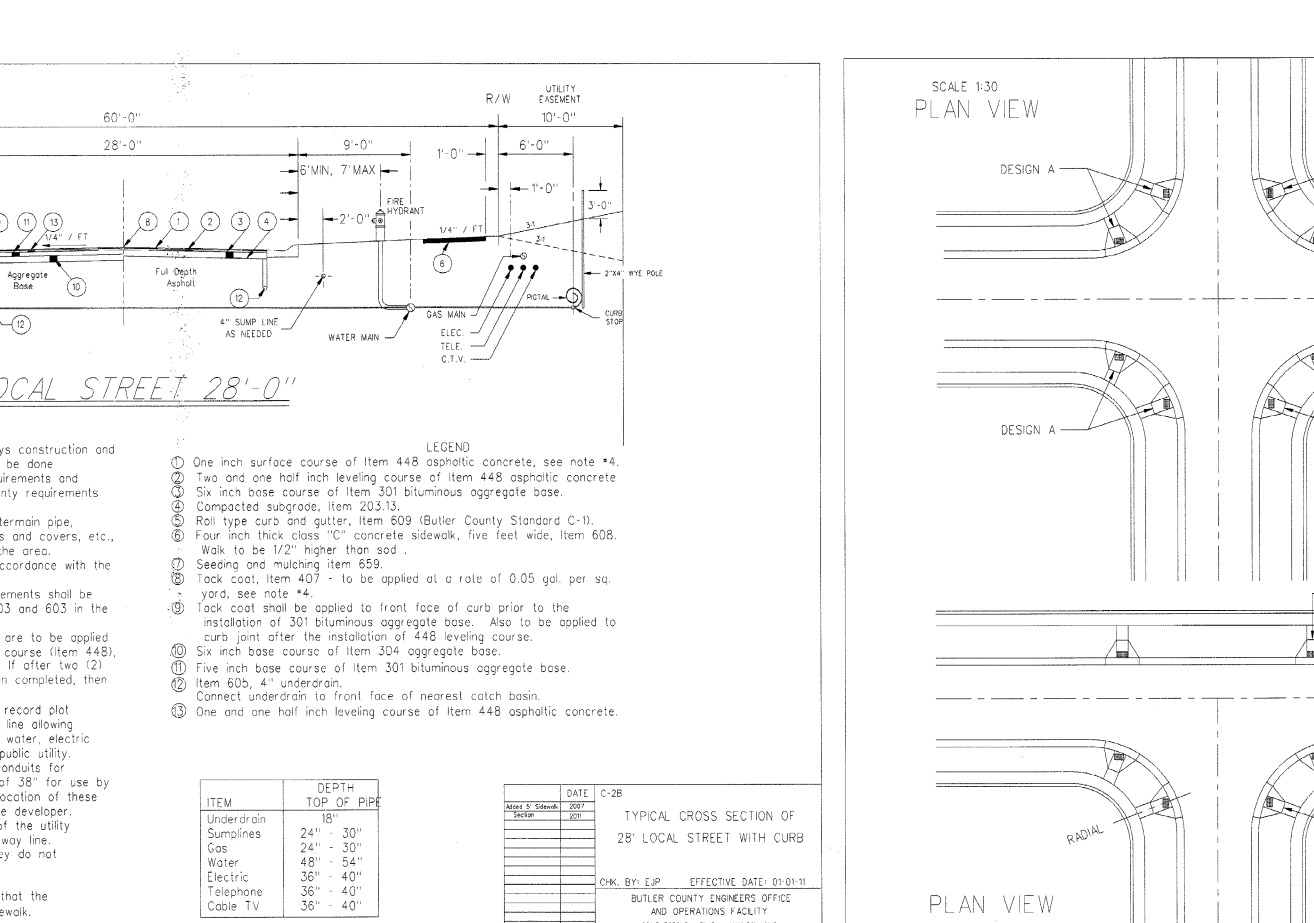

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**DEVELOPER:**  
M/I HOMES OF CINCINNATI, LLC  
9349 WATERSTONE BOULEVARD  
SUITE 100  
CINCINNATI, OHIO 45249

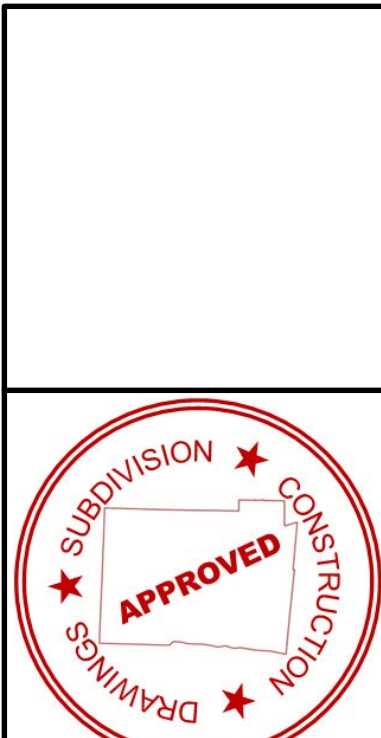

EJP 09/12/18  
BCEO SUB  
#1587

ARBOR PARK

7-20-18  
Drawn By D.L.  
Checked By B.R.  
Scale NONE

REVISIONS  
8-1-18, Water & Sewer (Dimensions & Ref. Set)  
8-15-18, BCEO (Dimensions & Ref. Set)

TITLE SHEET  
ARBOR PARK  
SECTION-21, TOWN-3, RANGE-3  
LIBERTY TOWNSHIP  
BUTLER COUNTY, OHIO

Sheet Title  
Project Title


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Know what's below. Call before you dig.


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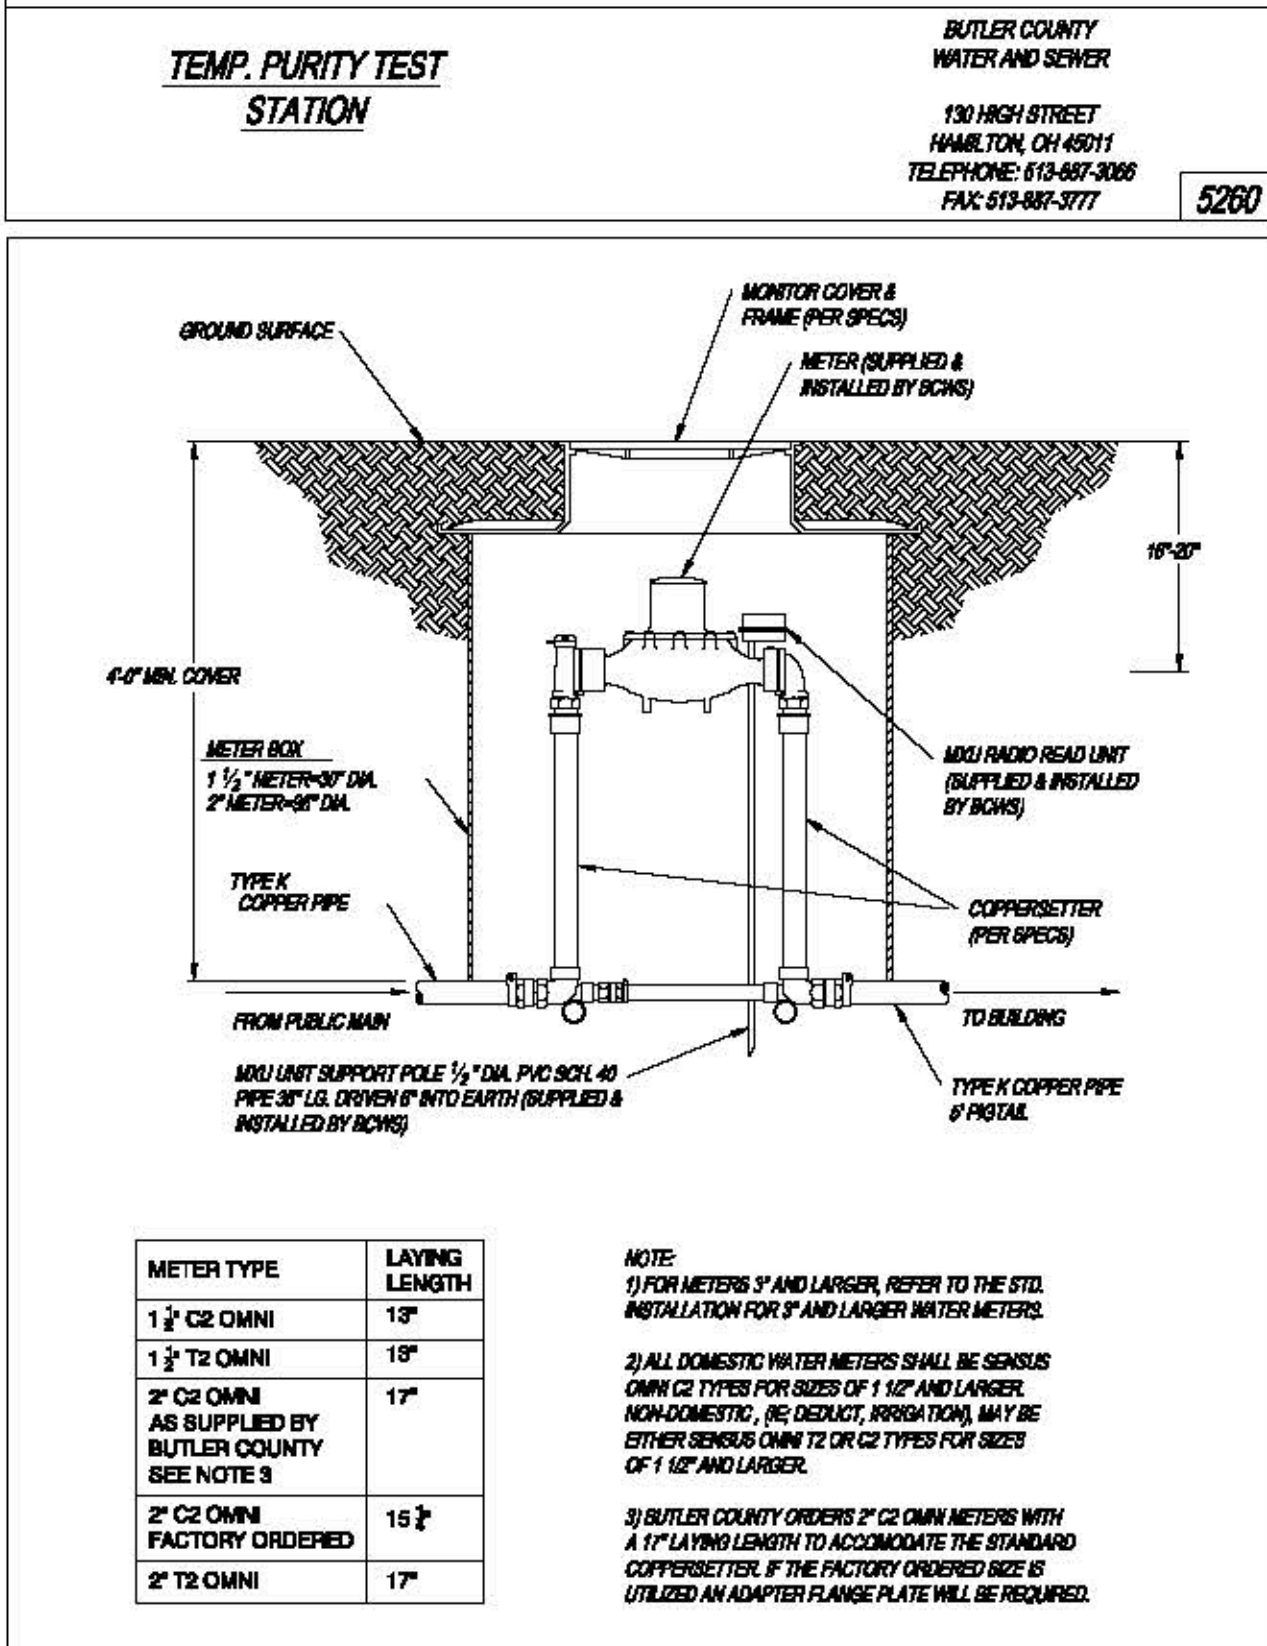
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5110




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5260

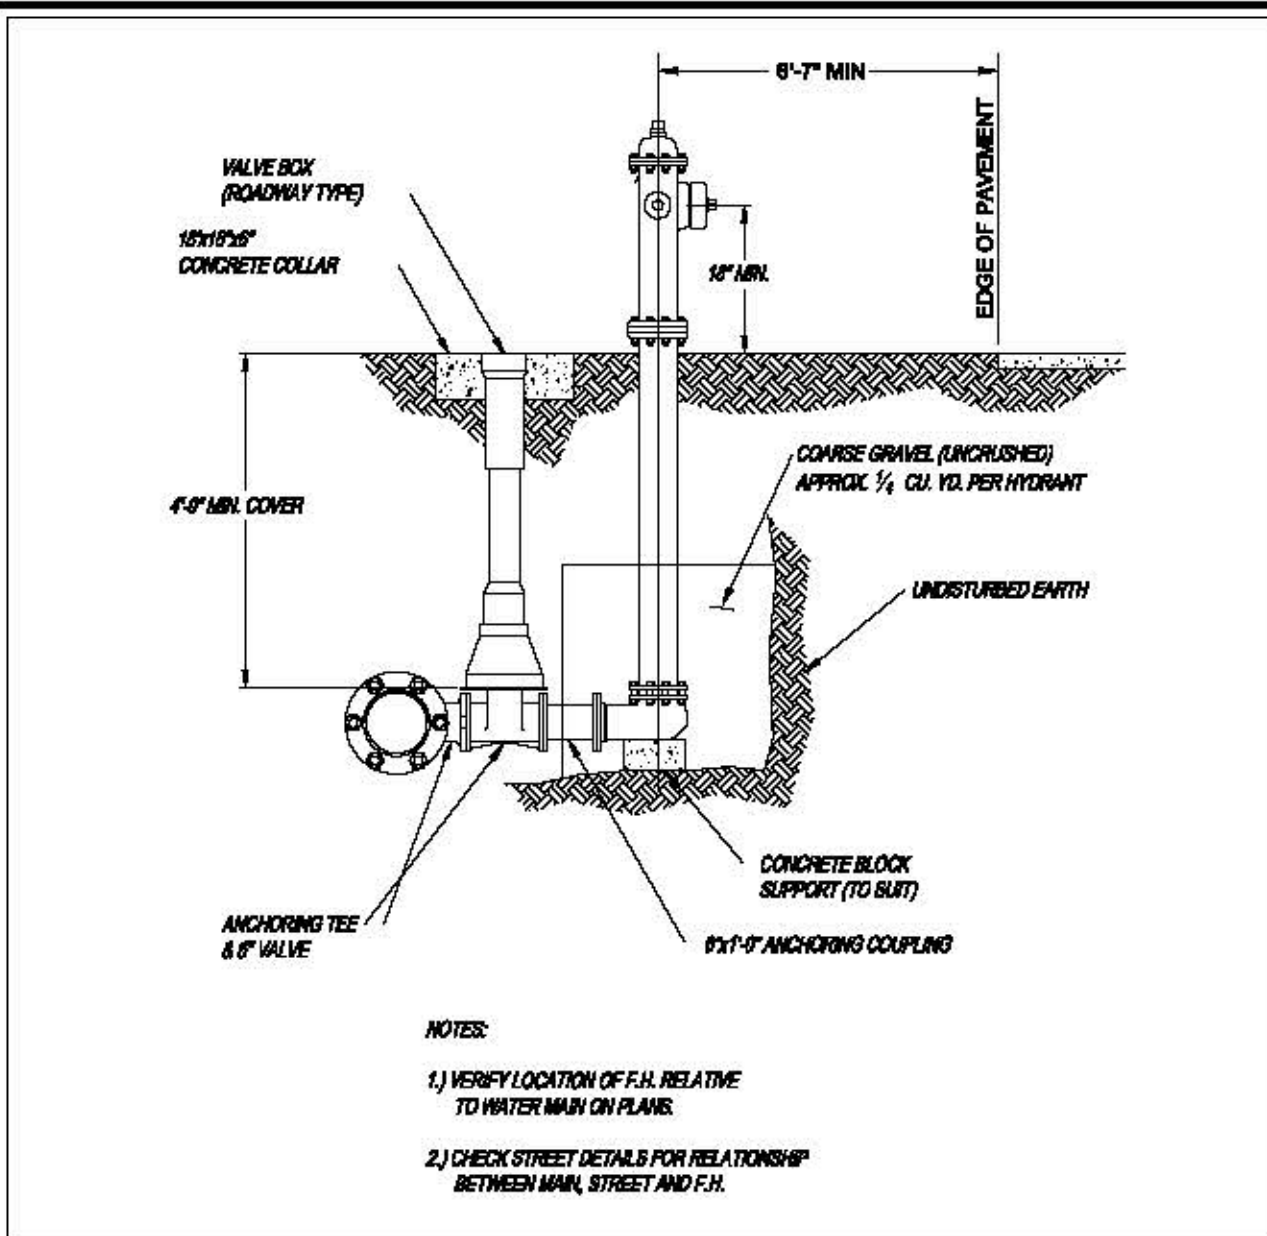


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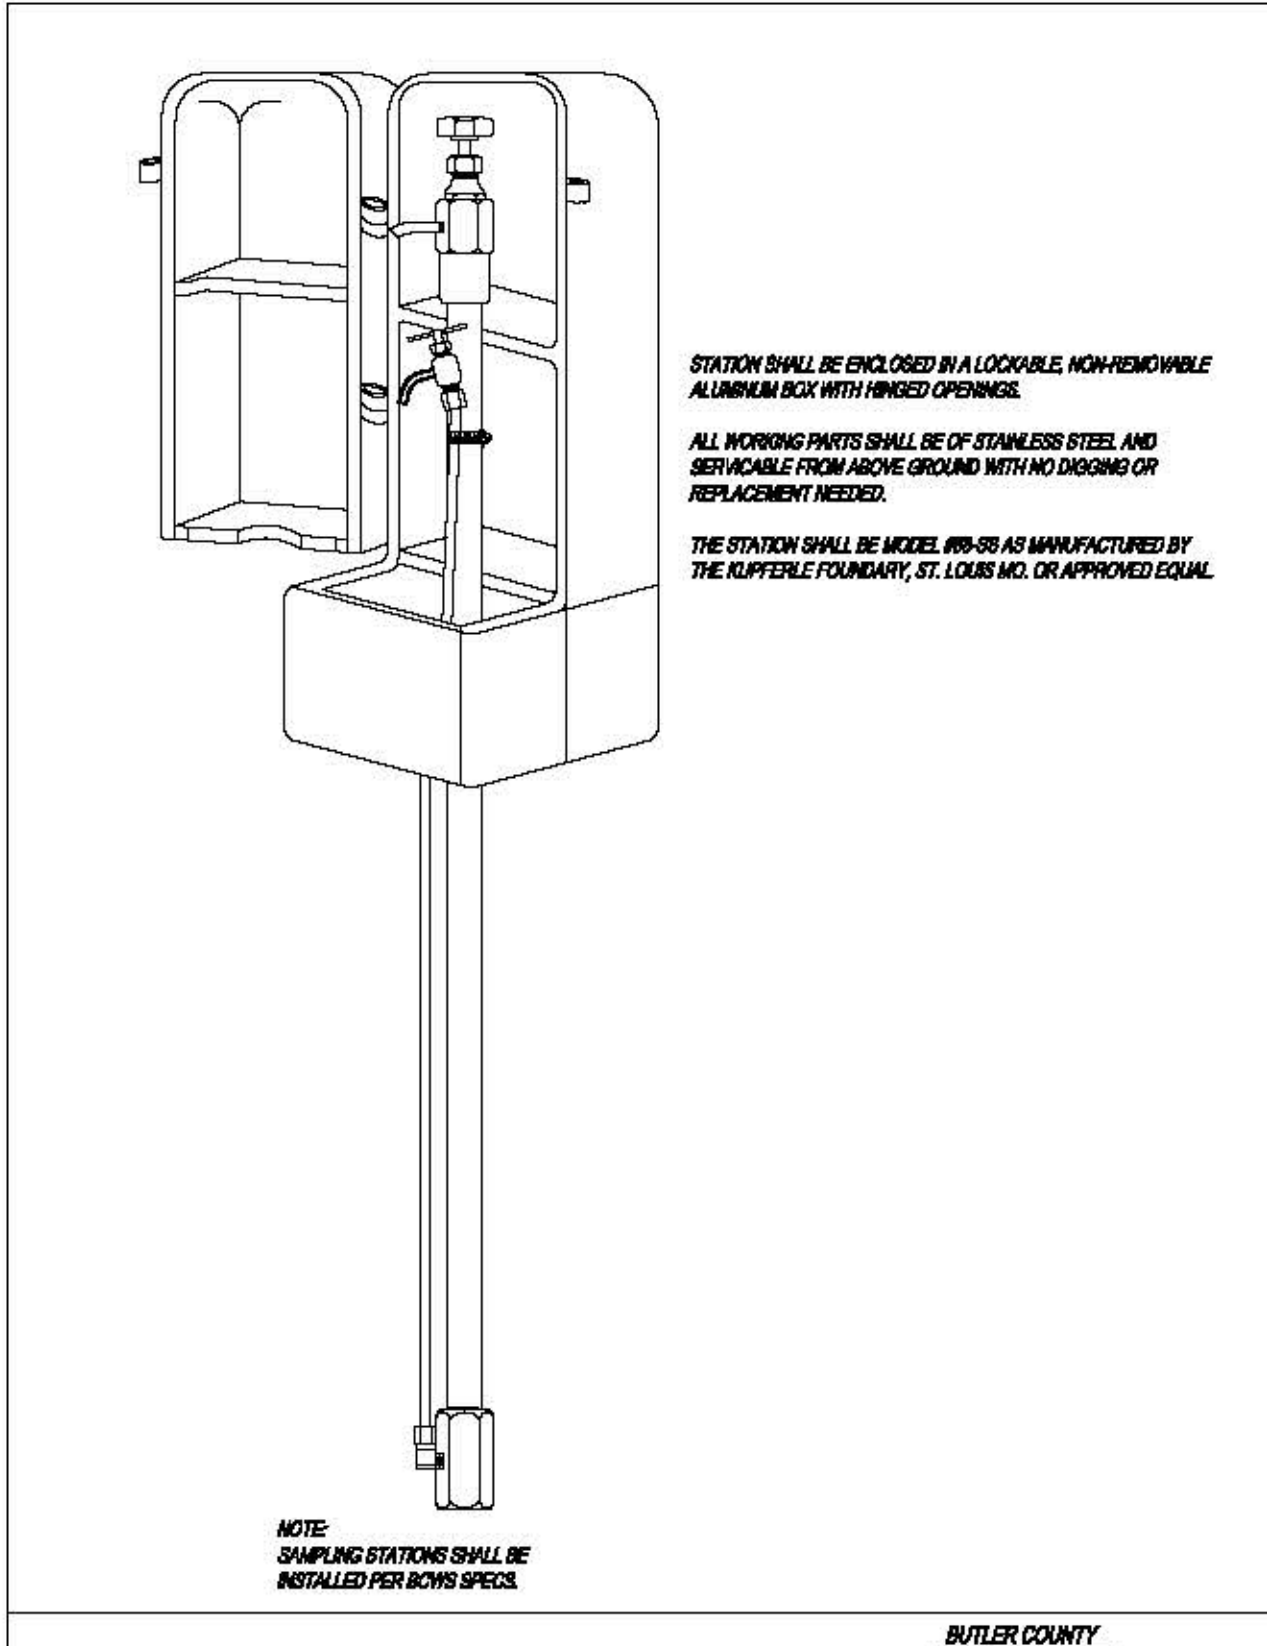
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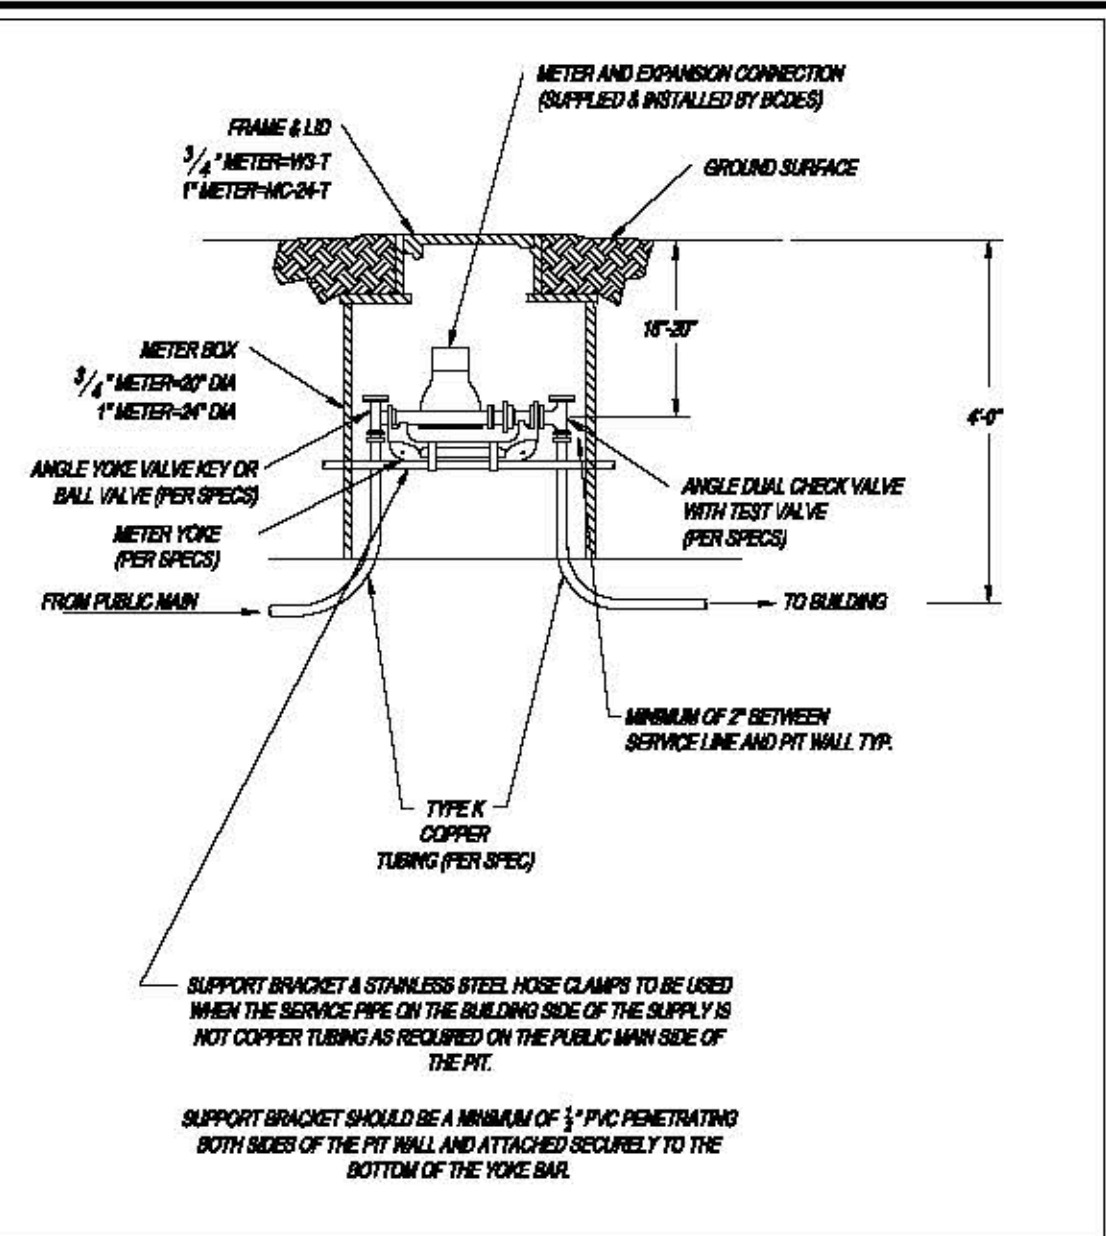
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5280

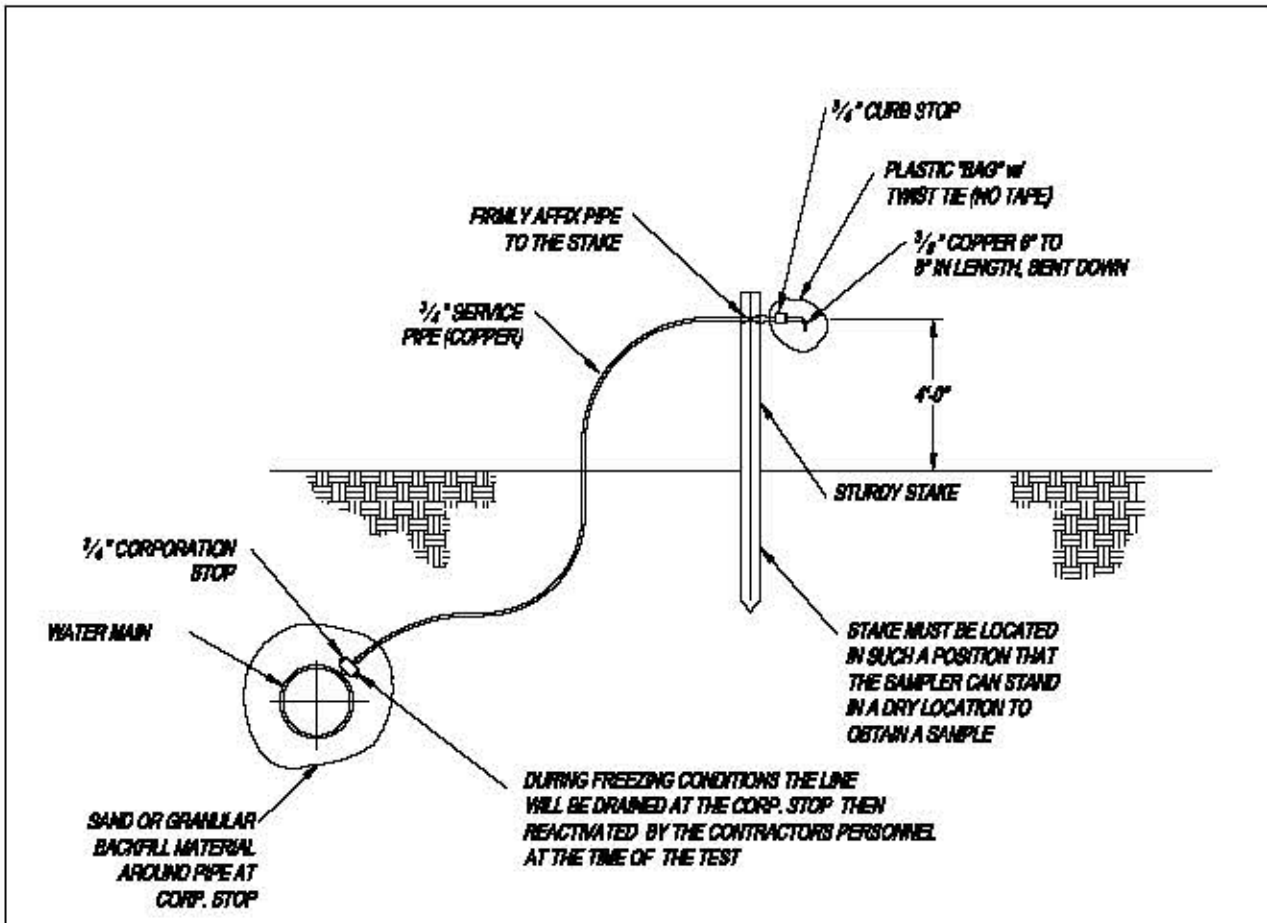


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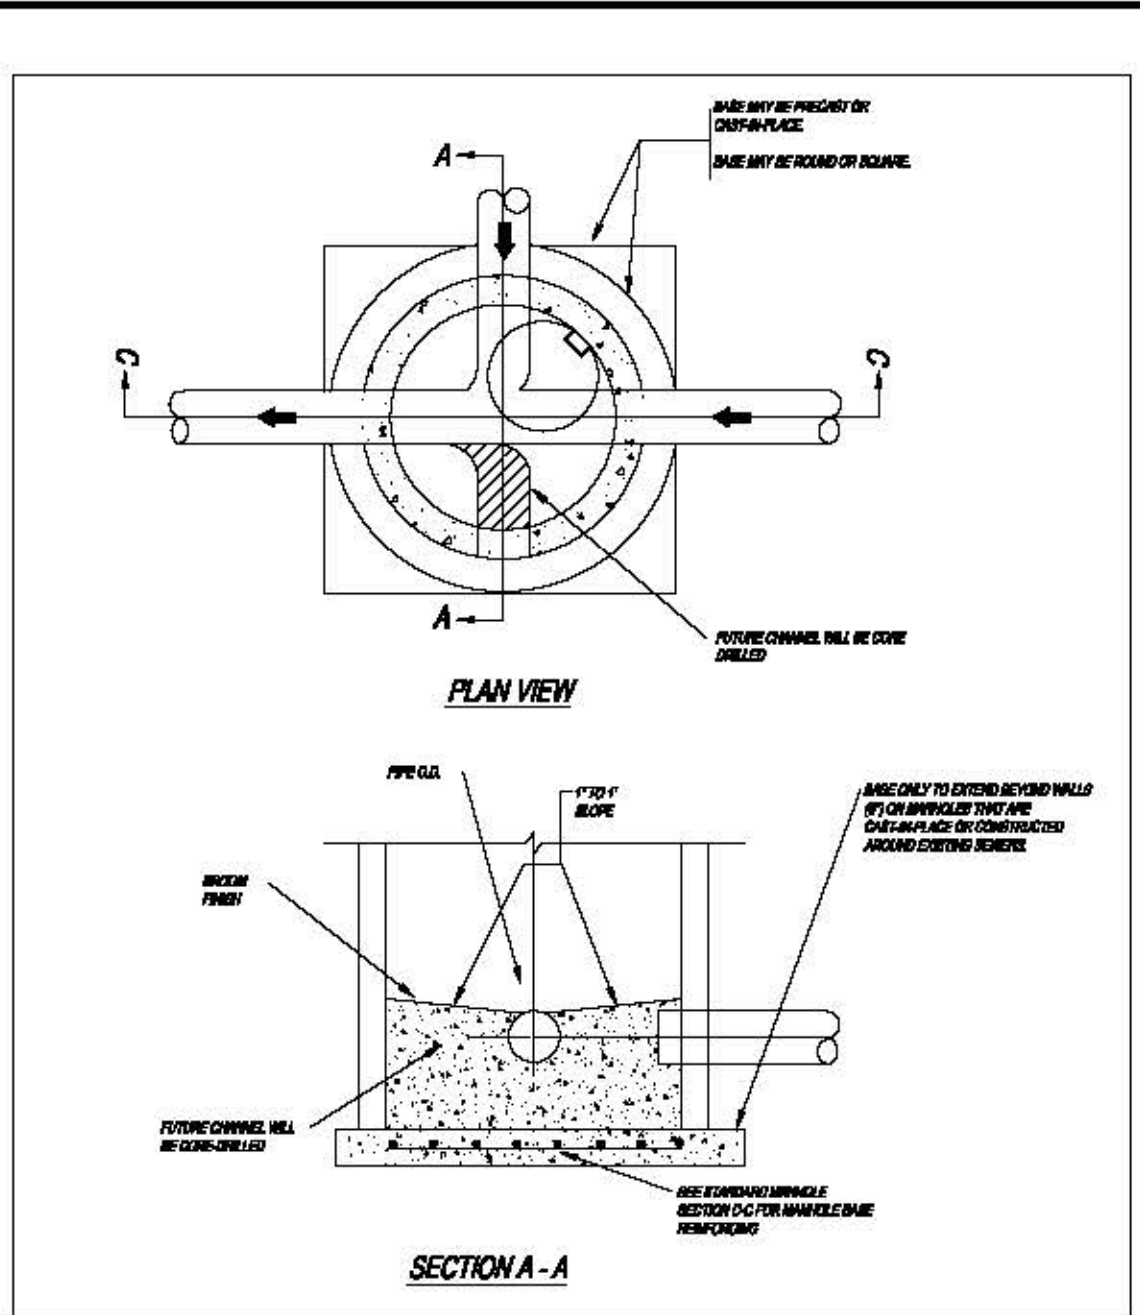
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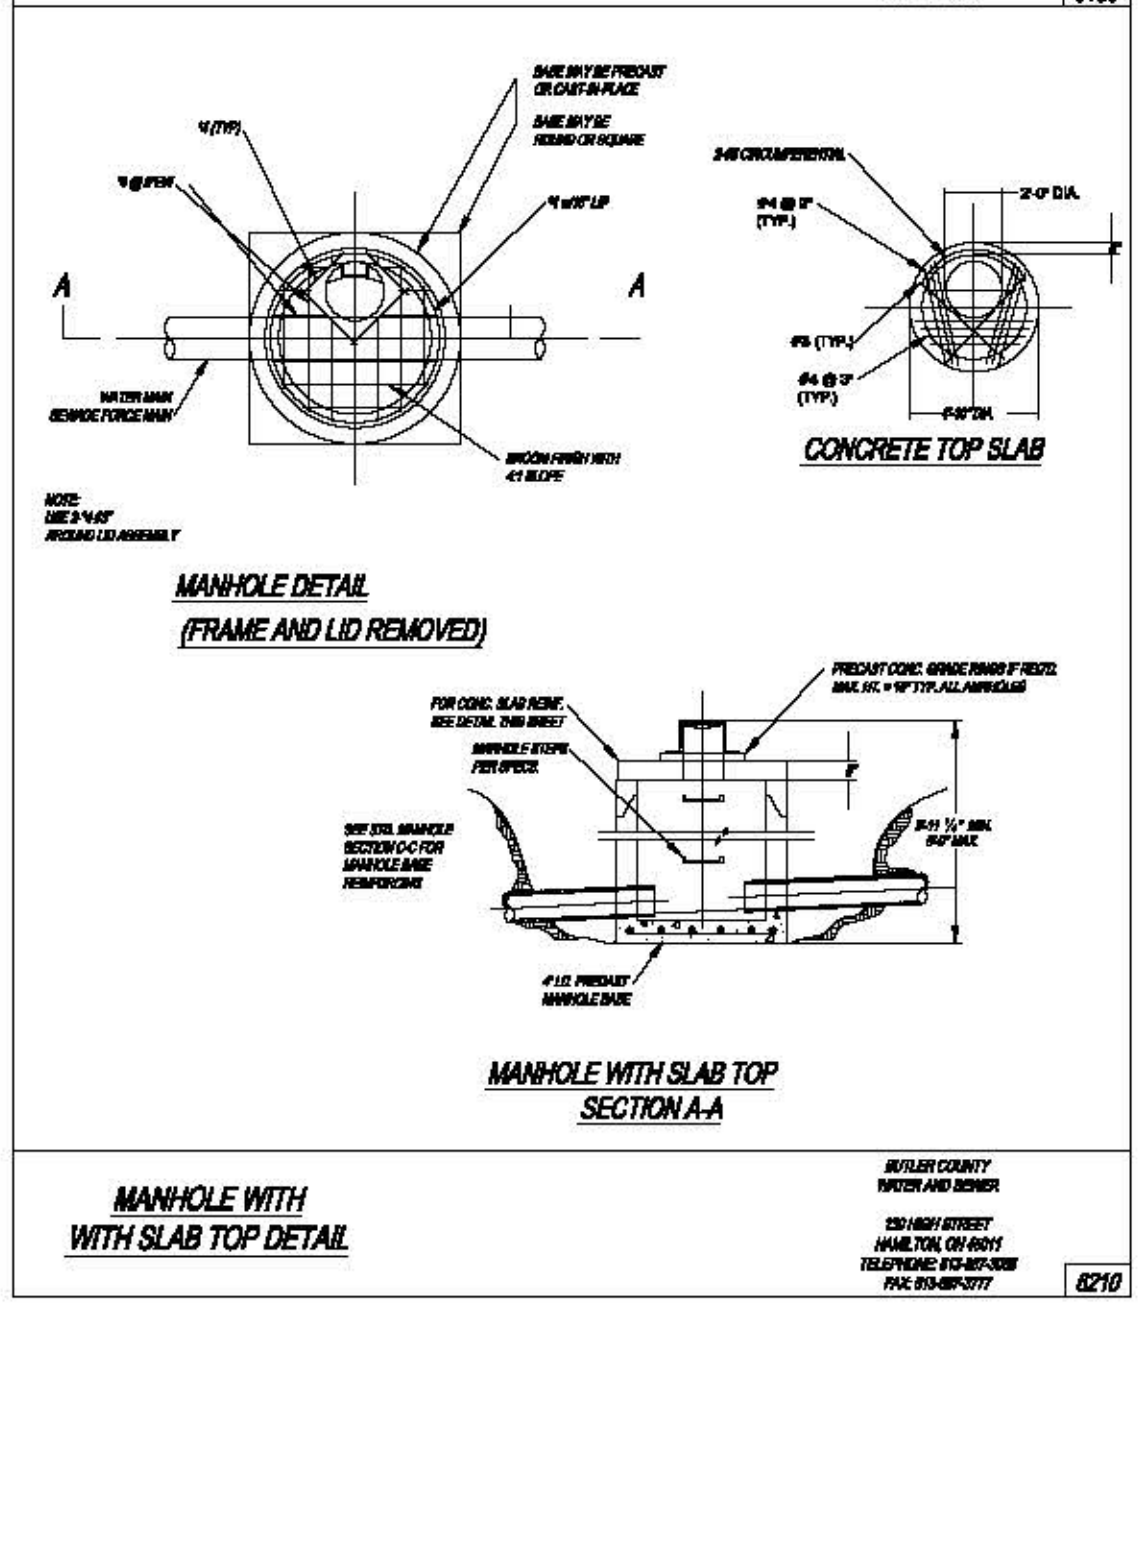
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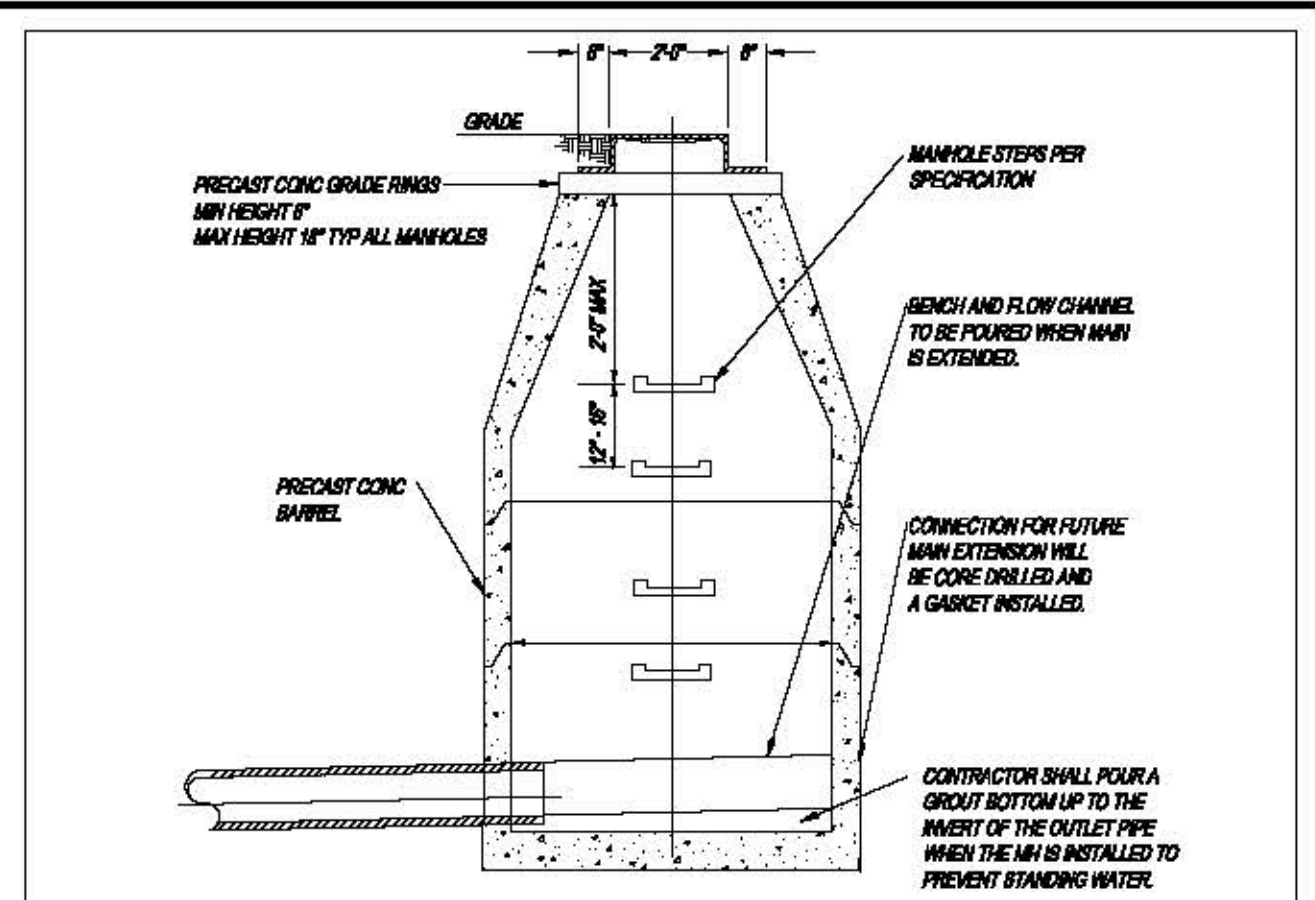
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6190

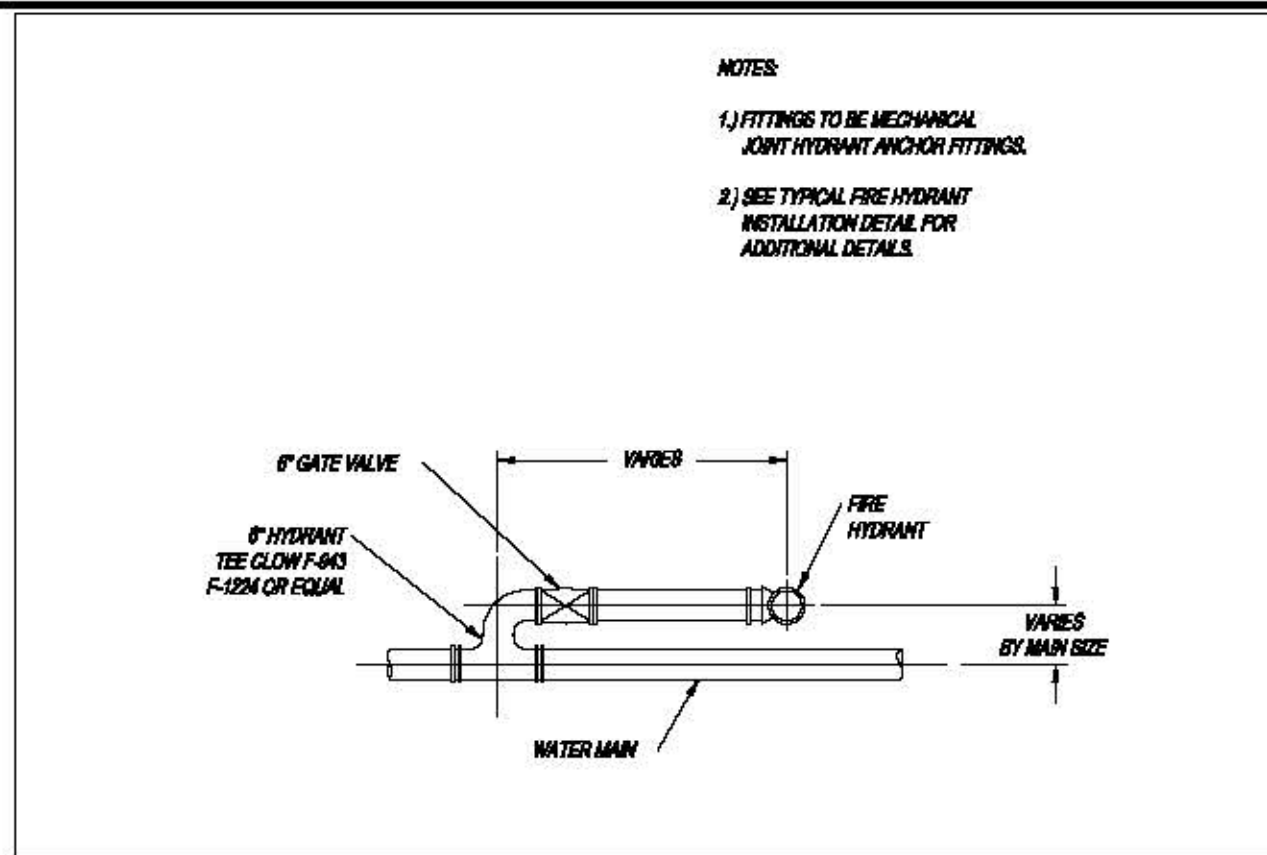


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6210

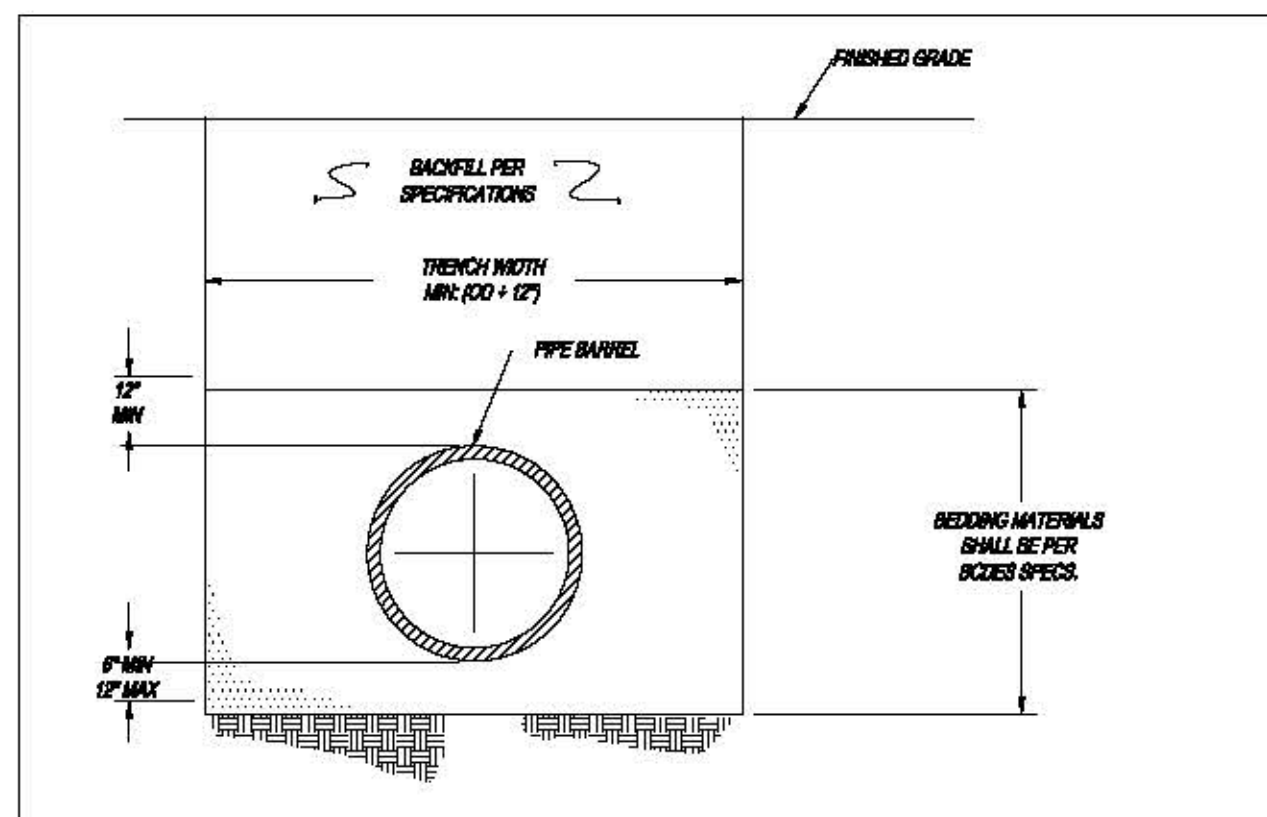


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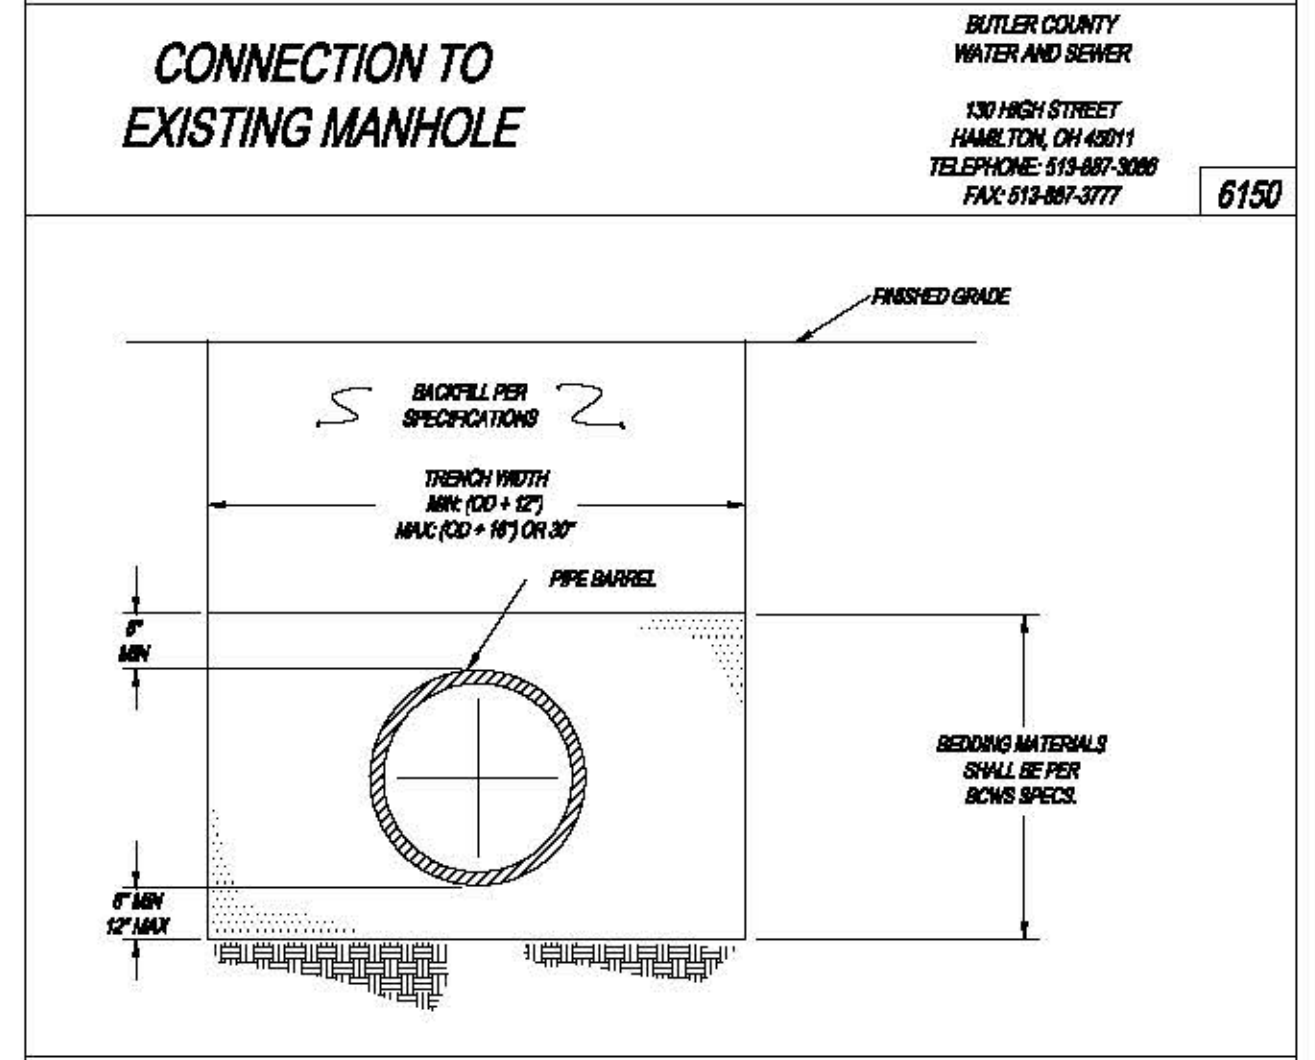
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6170

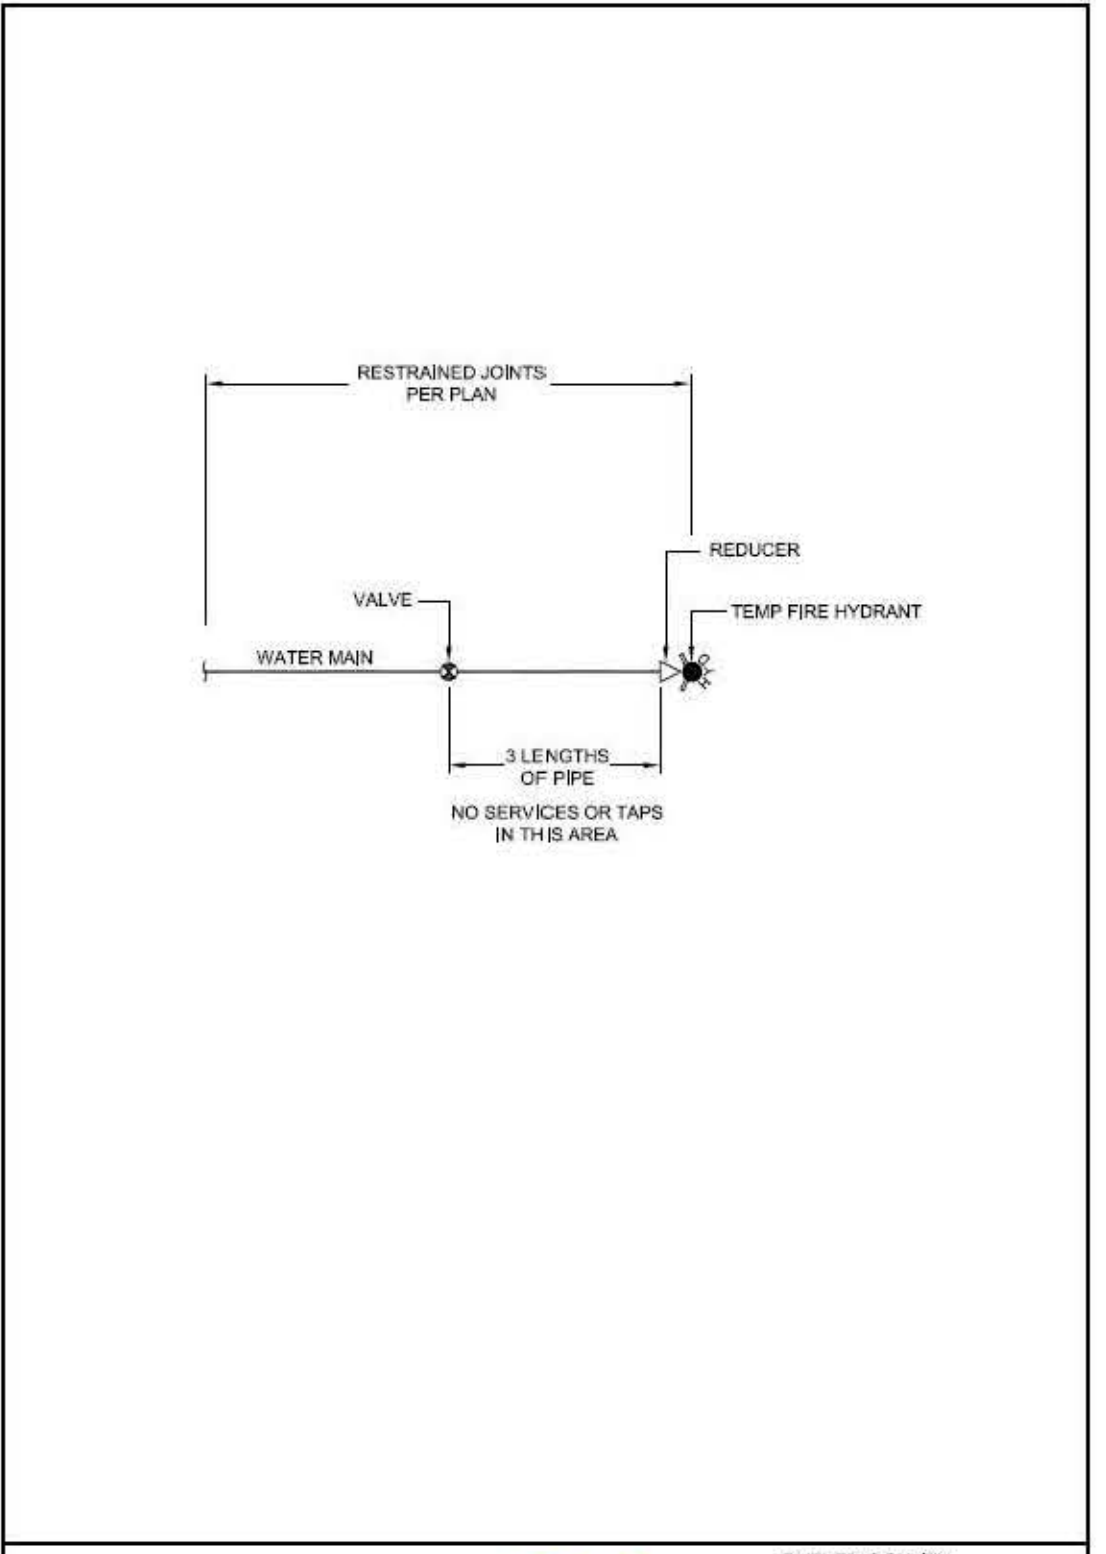

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6270

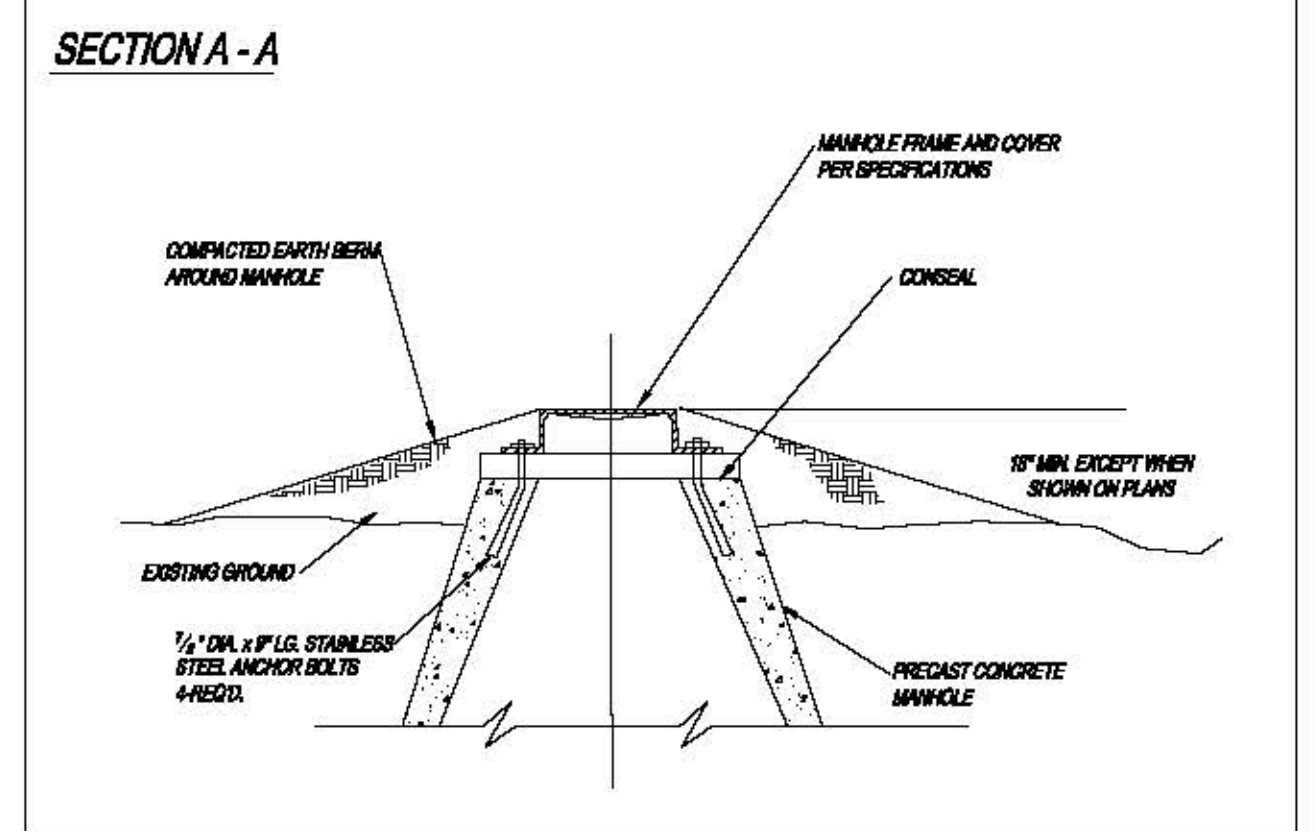

**ARBOR PARK**

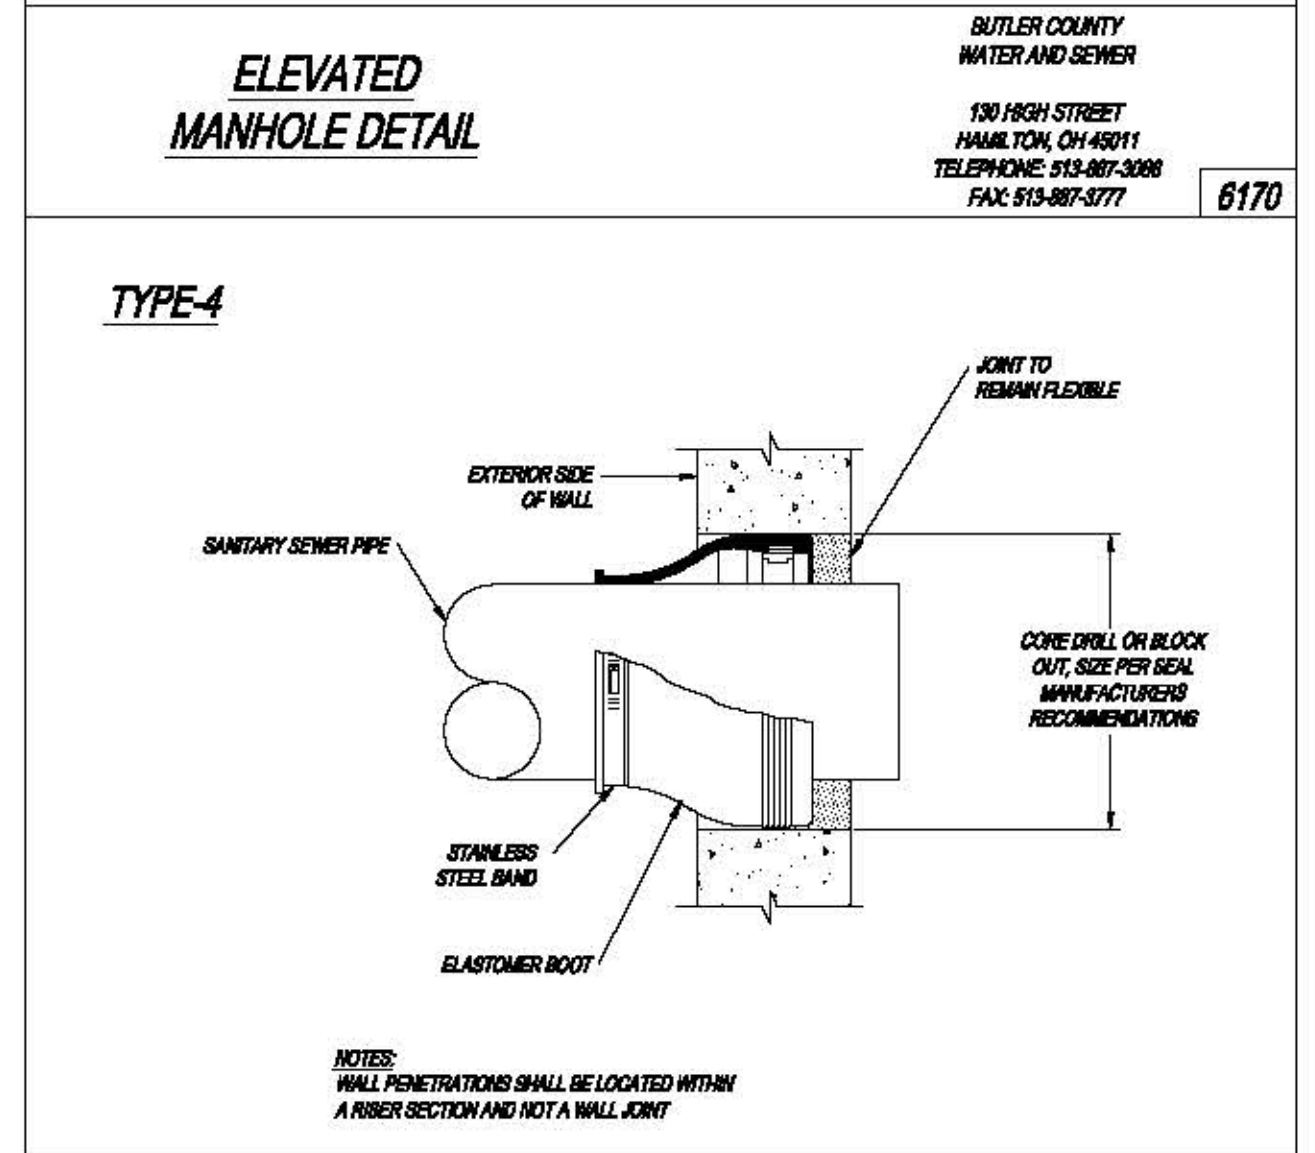DATE: 7-20-18  
 DRAWN BY: D.L.  
 CHECKED BY: B.R.  
 SCALE: NONE

REVISIONS:  
 8-1-18, IMPROV. & SHOR. EXISTING  
 8-15-18, 2012, HAMILTON, OH, 45011

PROJECT TITLE:  
 ARBOR PARK  
 SECTION-21, TOWN-3, RANGE-3  
 LIBERTY TOWNSHIP  
 BUTLER COUNTY, OHIO

DETAIL SHEET


Sheet Title:  
 Project Title:  
 Job No.: 18-0013

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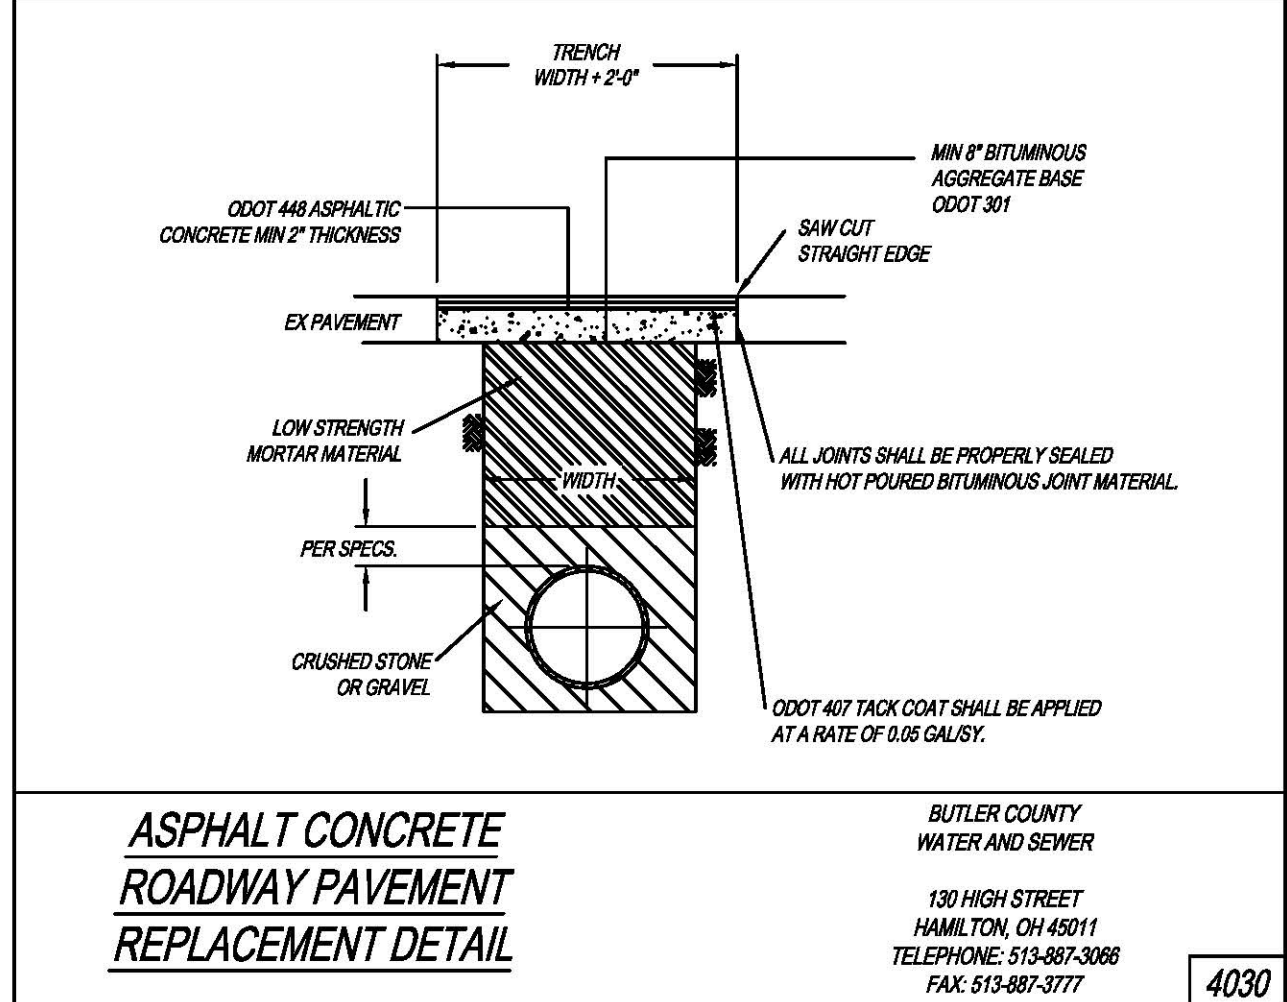




4370

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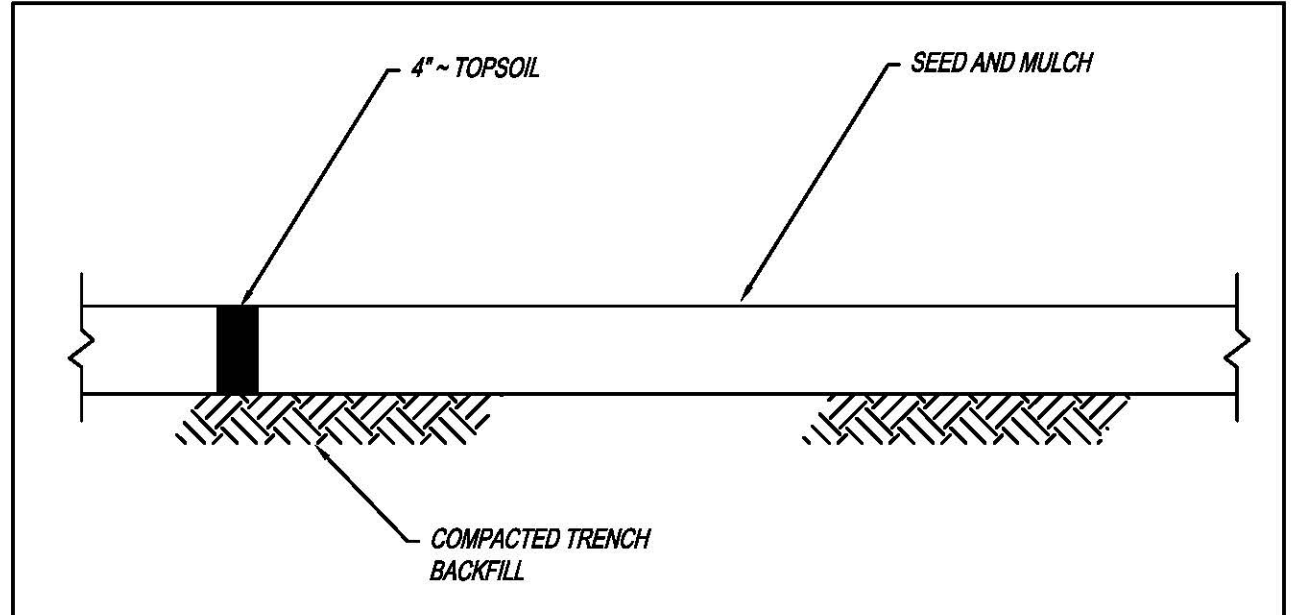
**SEWER FORCE MAIN & WATER  
MAIN ENCASUREMENT DETAIL**

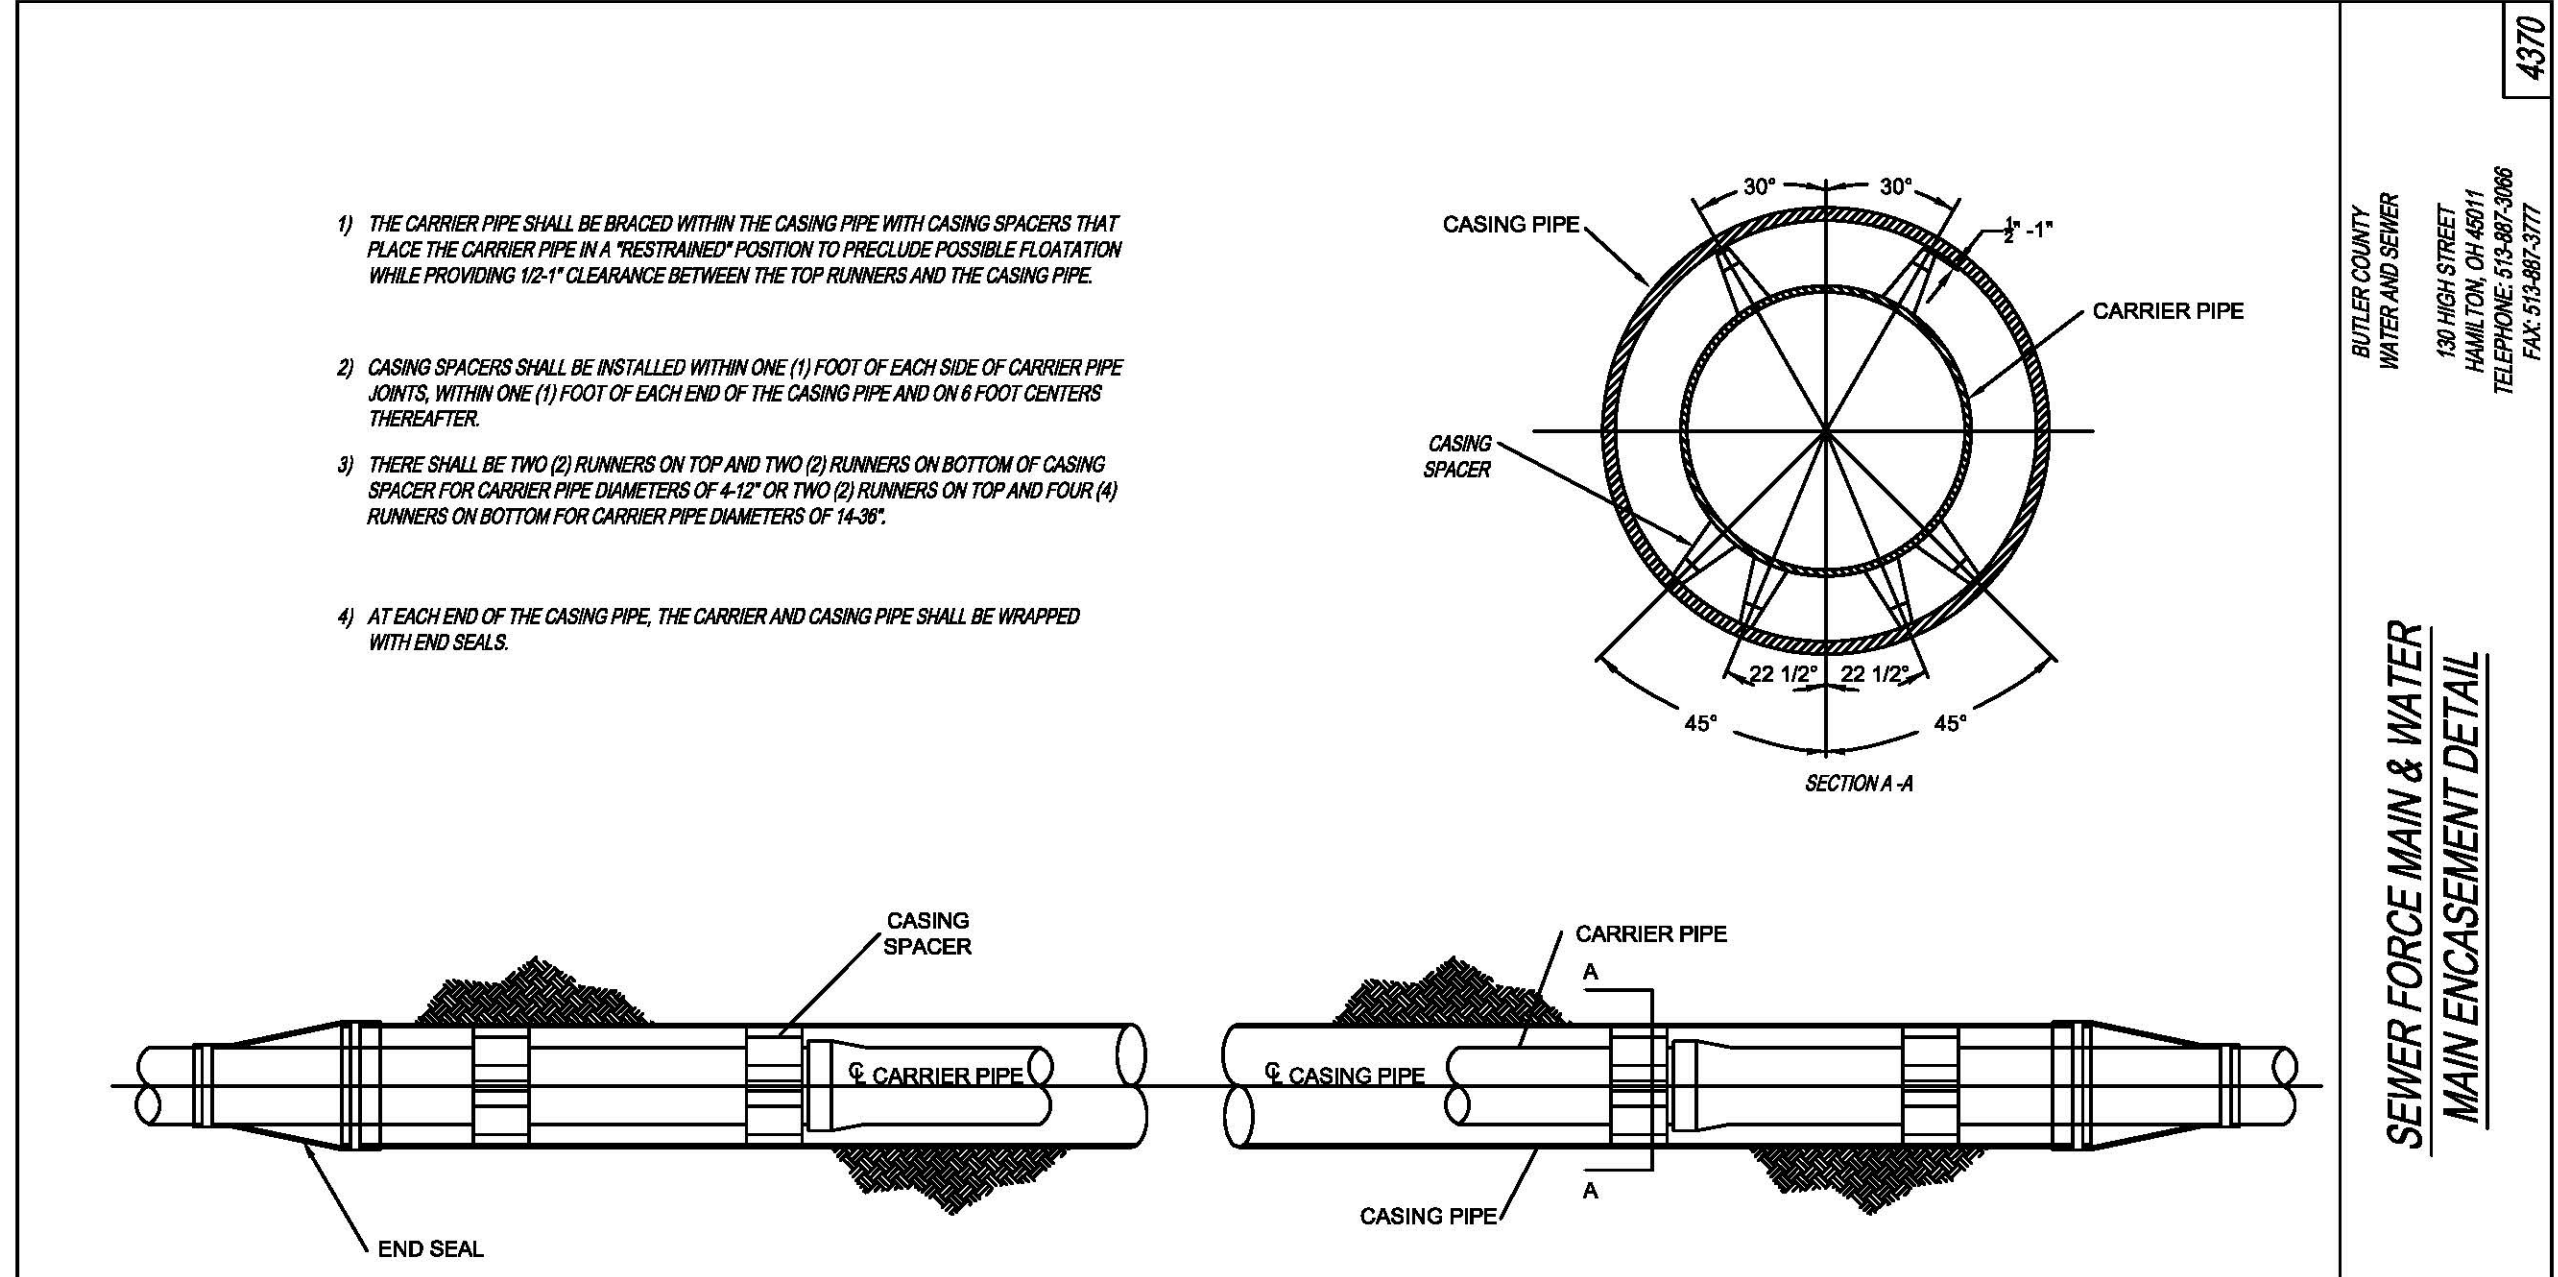

4030

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WATER AND SEWER  
130 HIGH STREET  
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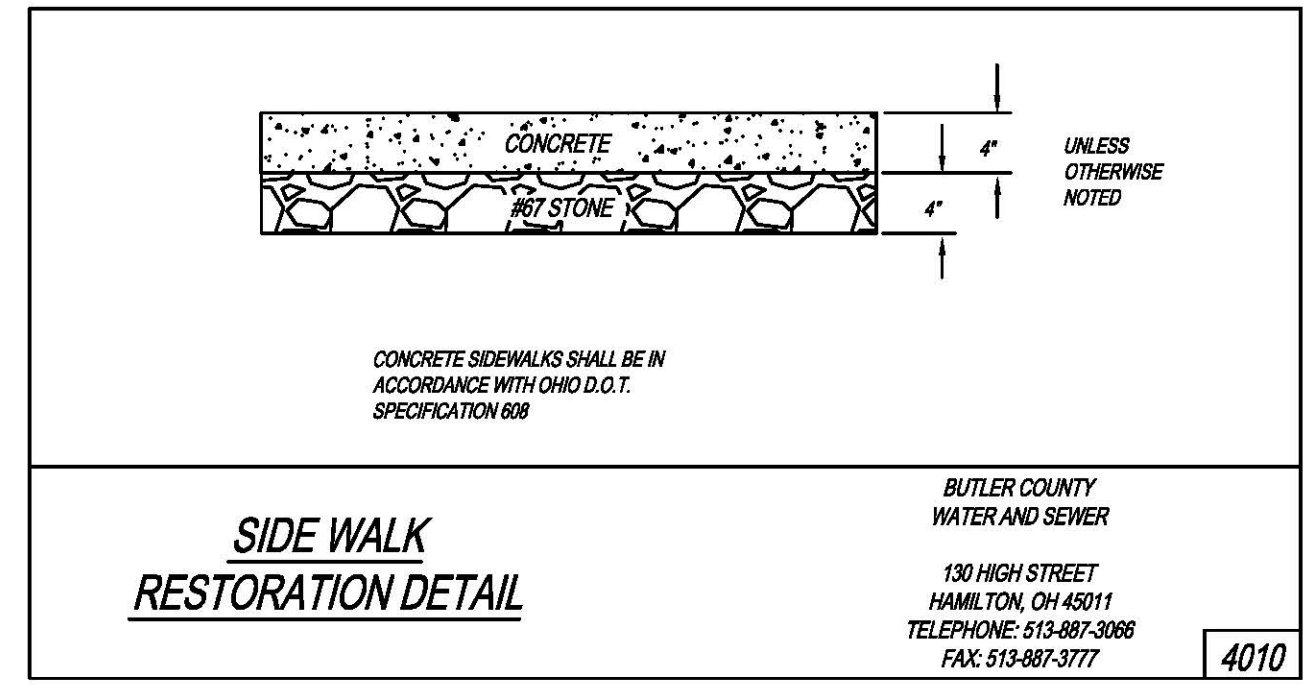
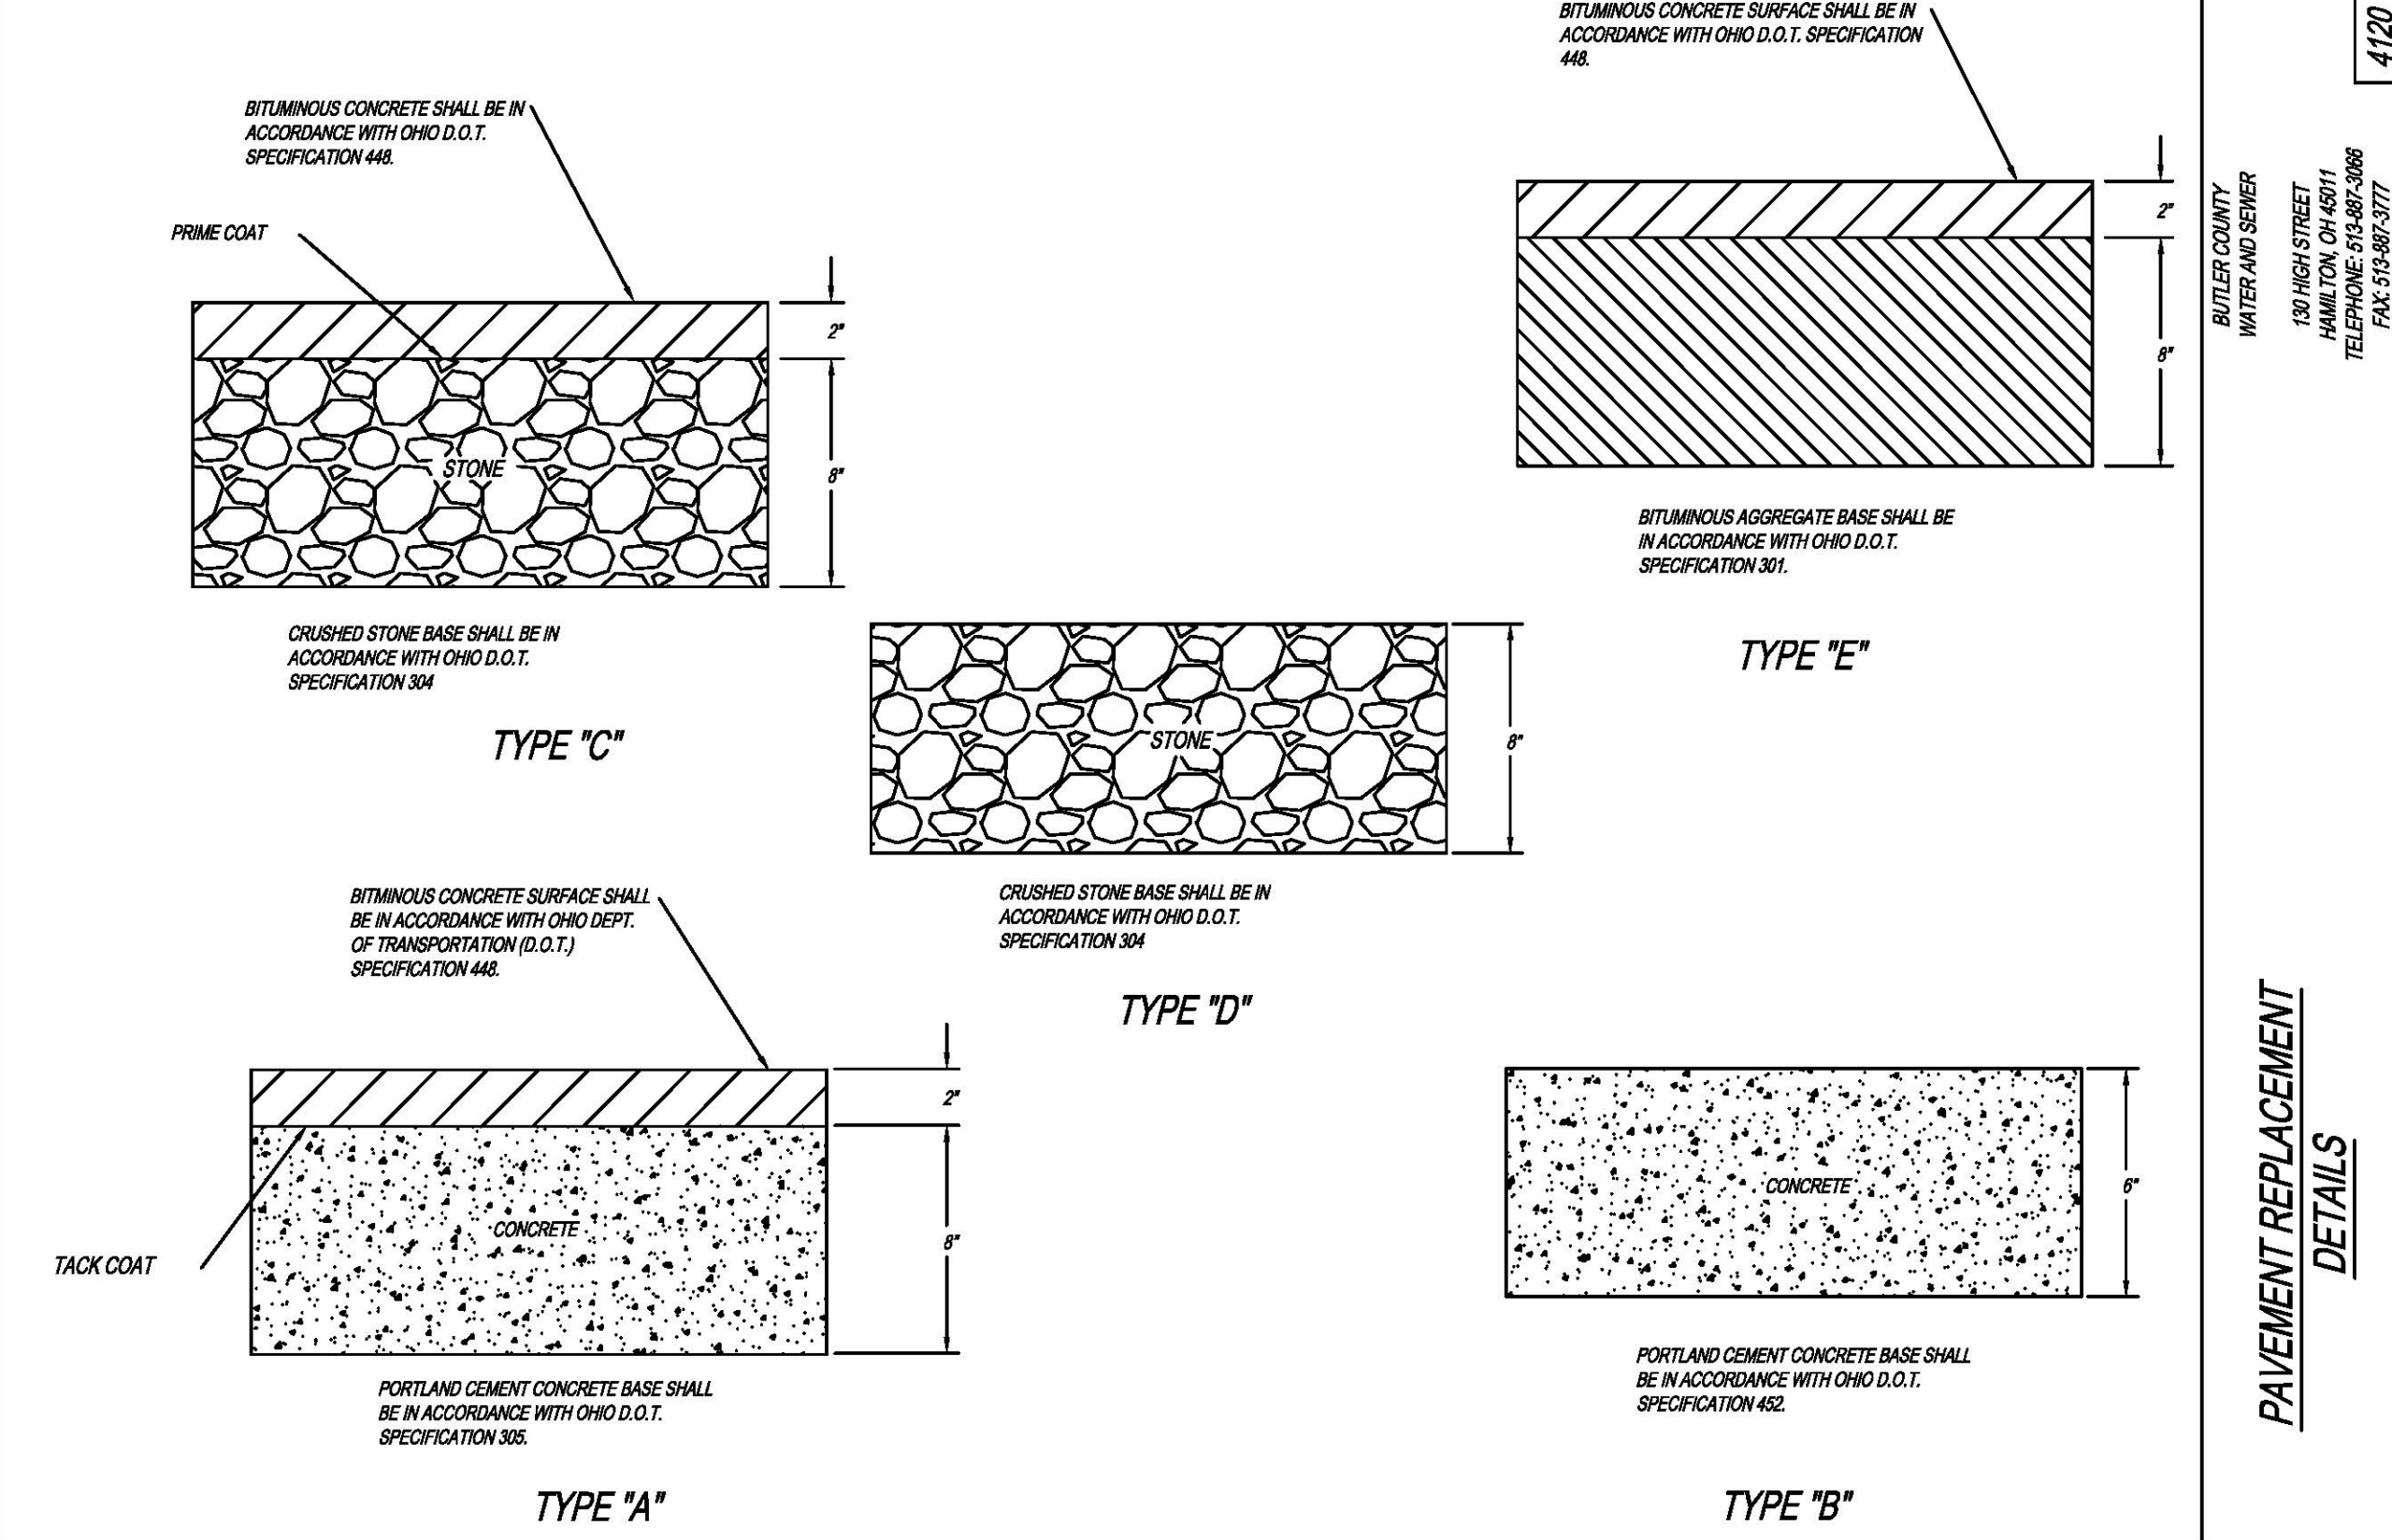
**ASPHALT CONCRETE  
ROADWAY PAVEMENT  
REPLACEMENT DETAIL**



4025

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**YARD RESTORATION  
DETAIL**



4010

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**SIDE WALK  
RESTORATION DETAIL**

4120

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HAMILTON, OH 45011  
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**PAVEMENT REPLACEMENT  
DETAILS**

Date	7-20-18
Drawn By	D.L.
Checked By	B.R.
Scale	NONE

REVISIONS	
8-1-18, Water & Sewer Divisions	
8-15-18, E&S Divisions & Bid Set	
18-0013DSM (DL-DSM)	

DETAIL SHEET

ARBOR PARK  
SECTION-21, TOWN-3, RANGE-3  
LIBERTY TOWNSHIP  
BUTLER COUNTY, OHIO

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**EROSION AND SEDIMENT CONTROL**

A) STABILIZATION/RESTORATION PRACTICES: THE OPERATOR SHALL INSTALL ALL PERIMETER & EROSION CONTROL MEASURES POSSIBLE BEFORE PROJECT BEGINS AND AS NEEEDED DURING THE CONSTRUCTION PROCESS AND MAINTAIN APPROPRIATE VEGETATION PRACTICES ON ALL DISTURBED AREAS WITHIN SEVEN (7) DAYS IF THEY ARE TO REMAIN DORMANT (UNDISTURBED) FOR MORE THAN FORTY-FIVE (45) DAYS. FOR AREAS WITHIN FIFTY (50) FEET OF ANY STREAM, FIRST ORDER OR LARGER, SOIL STABILIZATION PRACTICES SHALL BE INITIATED WITHIN TWO (2) DAYS ON ALL INACTIVE, DISTURBED AREAS. PERMANENT OR TEMPORARY SOIL STABILIZATION SHALL BE APPLIED TO DISTURBED AREAS WITHIN SEVEN (7) DAYS AFTER FINAL GRADE IS REACHED ON ANY PORTION OF THE SITE. WHEN SEASONAL CONDITIONS PROHIBIT THE APPLICATION OF TEMPORARY OR PERMANENT SEEDING, NON-VEGETATIVE SOIL STABILIZATION PRACTICES SUCH AS MULCHING AND MATTING SHALL BE USED.

B) STRUCTURAL PRACTICES: STRUCTURAL PRACTICES SHALL BE USED TO CONTROL EROSION AND TRAP SEDIMENT FROM ALL SITES REMAINING DISTURBED FOR MORE THAN FOURTEEN (14) DAYS. SUCH PRACTICES MAY INCLUDE AMONG OTHERS SEDIMENT TRAPS, SEDIMENT BASINS, SILT FENCES, EARTH DIVERSION DICES, CHECK DAMS AND STORM DRAIN INLET PROTECTION.

C) THIS PLAN SHALL NOT BE CONSIDERED AS THE CONTRACTOR SHALL TAKE ALL NECESSARY PRECAUTIONS TO PREVENT SOIL SEDIMENT FROM LEAVING THE SITE. ADDITIONAL EROSION AND SEDIMENTATION CONTROL MEASURES WILL BE INSTALLED IF DEEMED NECESSARY BY AN ON-SITE INSPECTION.

1. TIMING: SEDIMENT CONTROL STRUCTURES SHALL BE FUNCTIONAL THROUGHOUT EARTH DISTURBING ACTIVITY. SEDIMENT PONDS AND PERIMETER SEDIMENT BARRIERS SHALL BE IMPLEMENTED AS THE FIRST STEP OF GRADING AND WITHIN SEVEN (7) DAYS FROM THE START OF GRUBBING. THEY SHALL CONTINUE TO FUNCTION UNTIL THE UP SLOPE DEVELOPMENT AREA IS DESTABILIZED.

2. SETTLING PONDS: CONCENTRATED STORM WATER RUNOFF FROM DISTURBED AREAS FLOWING AT RATES WHICH EXCEED THE DESIGN CAPACITY OF SEDIMENT FENCES OR DIVERSIONS DIRECTING RUNOFF TO SETTLING FACILITIES SHALL PROTECT ADJACENT PROPERTIES AND WATER RESOURCES FROM SEDIMENT TRANSPORTED BY SHEET FLOW.

3. SEDIMENT BARRIERS: SHEET FLOW RUNOFF FROM DENAILED AREAS SHALL BE INTERCEPTED BY SEDIMENT BARRIERS. SEDIMENT BARRIERS SUCH AS SEDIMENT FENCES OR DIVERSIONS DIRECTING RUNOFF TO SETTLING FACILITIES, SHALL PROTECT ADJACENT PROPERTIES AND WATER RESOURCES FROM SEDIMENT TRANSPORTED BY SHEET FLOW.

4. STREAM PROTECTION: STRUCTURAL PRACTICES SHALL BE DESIGNED AND IMPLEMENTED ON SITE TO PROTECT ALL ADJACENT STREAMS, FIRST ORDER AND LARGER, FROM THE IMPACTS OF SEDIMENT RUNOFF.

5. OTHER EROSION AND SEDIMENT CONTROL PRACTICES SHALL PREVENT SEDIMENT LAIDEN WATER FROM ENTERING STORM DRAIN SYSTEMS, UNLESS THE STORM DRAIN SYSTEM DRAINS TO A SETTLING POND. THESE PRACTICES SHALL DIVERT RUNOFF FROM DISTURBED AREAS AND STEEP SLOPES WHERE PRACTICABLE AND STABILIZE CHANNELS AND OUTFALLS FROM EROSION FLOWS.

**MAINTENANCE** ALL TEMPORARY AND PERMANENT CONTROL PRACTICES SHALL BE MAINTAINED AND REPAIRED AS NEEDED TO ASSURE CONTINUED PERFORMANCE OF THEIR INTENDED FUNCTION. THE POLLUTION PREVENTION PLAN SHALL BE DESIGNED TO MINIMIZE MAINTENANCE REQUIREMENTS. THE APPLICANT SHALL PROVIDE A DESCRIPTION OF MAINTENANCE PROCEDURES NEEDED TO ASSURE THE CONTINUED PERFORMANCE OF CONTROL PRACTICES.

**INSPECTIONS** AT A MINIMUM, PROCEDURES IN A PLAN SHALL PROVIDE THAT ALL EROSIONS AND SEDIMENT CONTROLS ON THE SITE ARE INSPECTED AT LEAST ONCE EVERY SEVEN (7) CALENDAR DAYS AND WITHIN 24 HOURS AFTER ANY STORM EVENT GREATER THAN 0.5 INCH OF RAIN PER 24 HOUR PERIOD. IN ADDITION, QUALIFIED INSPECTION PERSONNEL (PROVIDED BY THE PERMITTEE) SHALL CONDUCT A WEEKLY INSPECTION OF THE CONSTRUCTION SITE TO IDENTIFY AREAS CONTRIBUTING TO STORM WATER DISCHARGES ASSOCIATED WITH CONSTRUCTION ACTIVITY AND EVALUATE WHETHER MEASURES TO PREVENT EROSION AND CONTROL POLLUTANT LOADINGS IDENTIFIED IN A STORM WATER POLLUTION PREVENTION PLAN ARE ADEQUATE AND PROPERLY IMPLEMENTED OR WHETHER ADDITIONAL CONTROL MEASURES ARE REQUIRED. DISTURBED AREAS AND AREAS USED FOR STORAGE OF MATERIALS THAT ARE EXPOSED TO PRECIPITATION SHALL BE INSPECTED FOR EVIDENCE OF, OR THE POTENTIAL FOR, POLLUTANTS ENTERING THE DRAINAGE SYSTEM. EROSION AND SEDIMENT CONTROL MEASURES IDENTIFIED IN THE PLAN SHALL BE OBSERVED TO ENSURE THAT THEY ARE OPERATING CORRECTLY. DISCHARGE LOCATIONS SHALL BE INSPECTED TO ASCERTAIN WHETHER EROSION AND SEDIMENT MEASURES ARE EFFECTIVE IN MITIGATING SIGNIFICANT IMPACTS TO THE RECEIVING WATERS. LOCATIONS WHERE VEHICLES ENTER OR EXIT THE SITE SHALL BE INSPECTED FOR EVIDENCE OF OFF-SITE VEHICLE TRACKING.

THE PERMITTEE SHALL MAINTAIN FOR TWO (2) YEARS FOLLOWING THE SUBMITTAL OF THE N.O.T. A RECORD SUMMARIZING THE RESULTS OF THE INSPECTION, NAME(S) AND QUALIFICATIONS OF PERSONNEL MAKING THE INSPECTION, THE DATE(S) OF THE INSPECTION, MAJOR OBSERVATIONS RELATING TO THE IMPLEMENTATION OF THE STORM WATER POLLUTION PREVENTION PLAN AND A CERTIFICATION THAT THE FACILITY IS IN COMPLIANCE WITH THE PLAN AND THE PERMIT AND IDENTIFY ANY INCIDENTS OF NON-COMPLIANCE.

**TECHNICAL STANDARD AND SPECIFICATIONS**

**CRITICAL AREA PLANTING - PERMANENT SEEDING (PS)**

**STANDARD DEFINITION**

THE ESTABLISHMENT OF PERENNIAL VEGETATION ON DISTURBED AREAS BY PLANTING SEED.

**PURPOSES**

- TO REDUCE THE EROSION AND DECREASE SEDIMENT YIELD FROM DISTURBED AREAS.
- TO PERMANENTLY STABILIZE DISTURBED AREAS IN A MANNER THAT IS ECONOMICAL, ADAPTABLE TO SITE CONDITIONS, AND ALLOWS SELECTION OF THE MOST APPROPRIATE PLANT MATERIALS.

**CONDITIONS WHERE PRACTICE APPLIES**

- DISTURBED AREAS WHERE PERENNIAL, LONG LIVED VEGETATIVE COVER IS NEEDED TO STABILIZE THE SOIL.
- ROUGH GRADED AREAS WHICH WILL NOT BE BROUGHT TO FINAL GRADE FOR SEVERAL MONTHS OR MORE.

**PLANNING CONSIDERATIONS**

- PROTECT THE AREA FROM EXCESS RUNOFF AS NECESSARY WITH DIVERSIONS, GRASSES, WATERWAYS, TERRACES, OR SEDIMENT BASINS.
- EVALUATE THE CAPABILITIES AND LIMITATIONS OF THE SOIL TO BE SEED. SPECIAL ATTENTION NEEDS TO BE GIVEN TO SOIL PH, TEXTURE, INTERNAL WATER MOVEMENT, STEEPNESS, AND STABILITY IN ORDER TO PLAN THE APPROPRIATE TREATMENT.
- PLANT SPECIES SHOULD BE SELECTED ON THE BASIS OF SOIL TYPE, PLANNED USE OF THE AREA, AND THE AMOUNT OR DEGREE OF MAINTENANCE THAT CAN BE DEVOTED TO THE AREA IN THE FUTURE.
- FERTILIZER, LIME, SEEDBED PREPARATION, SEED COVERAGE, MULCH, AND IRRIGATION SHOULD BE USED AS NECESSARY TO PROMOTE QUICK PLANT GROWTH.
- VEGETATION CANNOT NOT BE EXPECTED TO PROVIDE EROSION CONTROL COVER AND PREVENT SOIL SLIPPAGE ON A SOIL THAT IS NOT STABLE DUE TO ITS STRUCTURE, WATER MOVEMENT, OR EXCESSIVE SLOPE.

**TECHNICAL STANDARD AND SPECIFICATIONS**

**CRITICAL AREA PLANTING - TEMPORARY SEEDING (TS)**

**STANDARD DEFINITION**

THE ESTABLISHMENT OF TEMPORARY VEGETATIVE COVER ON DISTURBED AREAS BY SEEDING WITH THE APPROPRIATE RAPID GROWING PLANTS.

**PURPOSES**

- TO REDUCE THE EROSION AND SEDIMENTATION BY STABILIZING DISTURBED AREAS WILL NOT BE BROUGHT TO FINAL GRADE FOR A YEAR OR LESS.
- TO REDUCE PROBLEMS ASSOCIATED WITH MUD OR DUST FROM BARE SOIL SURFACES DURING CONSTRUCTION.
- TO REDUCE SEDIMENT RUNOFF TO DOWNSTREAM AREAS AND IMPROVE THE VISUAL RESOURCES OF THE CONSTRUCTION AREA.

**CONDITIONS WHERE PRACTICE APPLIES**

ON EXPOSED SOIL SURFACES WHERE ADDITIONAL WORK (GRADING, ETC.) IS NOT SCHEDULED FOR A PERIOD OF THREE WEEKS TO LESS THAN ONE YEAR.

**PLANNING CONSIDERATIONS**

- PROTECT THE AREA FROM EXCESS RUNOFF AS NECESSARY WITH DIVERSIONS, GRASSES, WATERWAYS, TERRACES, OR SEDIMENT BASINS.
- EVALUATE THE CAPABILITIES AND LIMITATIONS OF THE SOIL TO BE SEED. SPECIAL ATTENTION NEEDS TO BE GIVEN TO SOIL PH, TEXTURE, INTERNAL WATER MOVEMENT, STEEPNESS, AND STABILITY IN ORDER TO PLAN THE APPROPRIATE TREATMENT.
- PLANT SPECIES SHOULD BE SELECTED ON THE BASIS OF SOIL TYPE, PLANNED USE OF THE AREA, AND THE AMOUNT OR DEGREE OF MAINTENANCE THAT CAN BE DEVOTED TO THE AREA IN THE FUTURE.
- FERTILIZER, LIME, SEEDBED PREPARATION, SEED COVERAGE, MULCH, AND IRRIGATION SHOULD BE USED AS NECESSARY TO PROMOTE QUICK PLANT GROWTH.
- VEGETATION CANNOT NOT BE EXPECTED TO PROVIDE EROSION CONTROL COVER AND PREVENT SOIL SLIPPAGE ON A SOIL THAT IS NOT STABLE DUE TO ITS STRUCTURE, WATER MOVEMENT, OR EXCESSIVE SLOPE.

**MAINTENANCE TIMELINES**

IF AN INSPECTION REVEALS THAT A CONTROL PRACTICE IS IN NEED OF REPAIR OR MAINTENANCE WITH THE EXCEPTION OF A SETTLING POND IT MUST BE REPAIRED OR MAINTAINED WITHIN THREE DAYS OF INSPECTION. SEDIMENT SETTLING PONDS MUST BE REPAIRED OR MAINTAINED WITHIN TEN DAYS OF THE INSPECTION.

IF THE INSPECTION REVEALS THAT A CONTROL PRACTICE FAILS TO PERFORM ITS INTENDED FUNCTION AND THAT ANOTHER, MORE APPROPRIATE CONTROL PRACTICE IS REQUIRED, THE SWP3 MUST BE AMENDED AND THE NEW CONTROL PRACTICE MUST BE INSTALLED WITHIN TEN DAYS OF THE INSPECTION.

IF THE INSPECTION REVEALS THAT A CONTROL PRACTICE HAS NOT BEEN IMPLEMENTED IN ACCORDANCE WITH THE SCHEDULE CONTAINED IN PART B.C.1.g OF THE OHIO EPA GENERAL PERMIT, THE CONTROL PRACTICE MUST BE IMPLEMENTED WITHIN TEN DAYS FROM THE DATE OF THE INSPECTION. IF THE INSPECTION REVEALS THAT THE PLANNED CONTROL PRACTICE IS NOT NEEDED, THE RECORD MUST CONTAIN A STATEMENT OF EXPLANATION AS TO WHY THE CONTROL PRACTICE IS NOT NEEDED.

**1. MECHANICAL - USE A DISK, CRUMPER, OR SIMILAR TYPE TOOL SET STRAIGHT TO PUNCH OR ANCHOR THE MULCH MATERIAL INTO THE SOIL.**

**2. ASPHALT EMULSION - APPLY AT THE RATE OF 160 GALLONS PER ACRE INTO THE MULCH AS IT IS BEING APPLIED.**

**3. MULCH NETTINGS - USE ACCORDING TO THE MANUFACTURER'S RECOMMENDATIONS. USE IN AREAS OF WATER CONCENTRATION TO HOLD MULCH IN PLACE.**

**4. MAINTENANCE**

1) MAINTENANCE IS A VITAL FACTOR IN MAINTAINING AN ADEQUATE VEGETATIVE EROSION CONTROL COVER.

2) IF STAND IS OVER 60 PERCENT DAMAGED, REESTABLISH FOLLOWING ORIGINAL LIME, FERTILIZER, SEEDBED PREPARATION, SEEDING RECOMMENDATIONS, AND MULCHING RECOMMENDATIONS.

**5. SITE PREPARATION**

A. SOIL WATERPHOULD CONSIST OF AT LEAST 25 PERCENT SILT AND CLAY TO PROVIDE AN ADEQUATE AMOUNT OF MOISTURE HOLDING CAPACITY. AN EXCESSIVE AMOUNT OF POROUS SAND WILL CONSISTENTLY PROVIDE SUFFICIENT MOISTURE FOR GOOD GROWTH REGARDLESS OF OTHER SOIL FACTORS.

B. WHERE COMPACTED SOILS OCCUR, THEY SHOULD BE BROKEN UP SUFFICIENTLY TO CREATE A FAVORABLE ROOTING DEPTH OF 6-8 INCHES.

C. STOCKPILE TOPSOIL TO APPLY TO SITES THAT ARE OTHERWISE UNSUITED FOR ESTABLISHING VEGETATION.

D. GRADE AS NEEDED AND FEASIBLE TO PERMIT THE USE OF CONVENTIONAL EQUIPMENT FOR SEEDBED PREPARATION, SEEDING, MULCHING APPLICATION AND ANCHORING, AND MAINTENANCE. AFTER THE GRADING OPERATION SPREAD TOPSOIL WHERE NEEDED.

E. INSTALL THE NEEDED EROSION CONTROL PRACTICES SUCH AS DIVERSIONS, GRASSES, WATERWAYS, AND SEDIMENT BASINS.

**6. SEEDBED PREPARATION**

A. LIME (IN LIEU OF A SOIL TEST RECOMMENDATION) ON ACID SOIL (PH 5.5 OR LOWER) AND SUBSOIL AT A RATE OF 100 POUNDS PER 1000 SQUARE FEET OR TWO TONS PER ACRE OF AGRICULTURAL GROUND LIMESTONE. FOR BEST RESULTS MAKE A SOIL TEST.

B. FERTILIZER (IN LIEU OF A SOIL TEST RECOMMENDATION) SHALL BE APPLIED AT A RATE OF 12-15 POUNDS PER 1000 SQUARE FEET OR 500-600 POUNDS PER ACRE OF 10-10-10 OR 12-12-12 ANALYSIS OR EQUIVALENT.

C. WORK THE LIME AND FERTILIZER INTO THE SOIL WITH A DISK HARROW, SPRINGTOOTH HARROW, OR SIMILAR TOOLS TO A DEPTH OF TWO INCHES. ON SLOPING AREAS THE FINAL OPERATION SHALL BE ON THE CONTOUR.

**7. SEEDING**

A. SPECIES SELECTION 1 PER 1000 SQUARE FEET PER ACRE

1. MARCH 1 TO AUGUST 15TH	3 LBS.	4 BU.
2. PERENNIAL RYEGRASS	1 LB.	40 LBS.
3. TALL FESCUE	1 LB.	40 LBS.

AUGUST 16 TO NOVEMBER 12

1. RYE OR	3 LBS.	2 BU.
2. WHEAT OR	3 LBS.	2 BU.
3. PERENNIAL RYEGRASS	1 LB.	40 LBS.
4. TALL FESCUE	1 LB.	40 LBS.

B. FERTILIZER (IN LIEU OF A SOIL TEST RECOMMENDATION) SHALL BE APPLIED AT A RATE OF 12-15 POUNDS PER 1000 SQUARE FEET OR 500-600 POUNDS PER ACRE OF 10-10-10 OR 12-12-12 ANALYSIS OR EQUIVALENT.

C. WORK THE LIME AND FERTILIZER INTO THE SOIL WITH A DISK HARROW, SPRINGTOOTH HARROW, OR OTHER SUITABLE FIELD EQUIPMENT TO A DEPTH OF THREE INCHES. ON SLOPING LAND THE FINAL OPERATION SHALL BE ON THE CONTOUR.

**8. SEEDING**

A. SELECT A SPECIES OR MIXTURE APPROPRIATE FOR THE SITE.

1. PERMANENT SEEDING			
KIND OF SEED 1/	SEEDING DATES 2/	PER 1000 SQUARE FT. PER ACRE	
A. CREEPING RED FESCUE, PLUS DOMESTIC RYEGRASS PLUS KENTUCKY BLUEGRASS	MARCH-MAY AUG.-SEPT.	1/2 LB. 3/	20 LBS.
B. TALL FESCUE	MARCH-MAY AUG.-SEPT.	1/4 LB.	10 LBS.
C. DWARF (TURF-TYPE) FESCUE 4/	MARCH-MAY AUG.-SEPT.	1 LB. 3/	40 LBS.

2. SPECIAL SEEDINGS-STEEP BANKS OR CUTS

KIND OF SEED 1/	SEEDING DATES 2/	PER 1000 SQUARE FT. PER ACRE	
A. TALL FESCUE	MARCH-MAY AUG.-SEPT.	1 LB.	40 LBS.
B. CROWNWITCH PLUS	MARCH-MAY AUG.-SEPT.	1/4 LB.	10 LBS.
C. FLAT PEA PLUS 4/	MARCH-MAY AUGUST	1/2 LB.	20 LBS.
D. TALL FESCUE	MARCH-MAY	1 LB.	40 LBS.

3. OTHER SEED SPECIES MAY BE SUBSTITUTED CHECK WITH THE LOCAL SCS OFFICE FOR RECOMMENDATIONS.

4. THESE SEEDING DATES ARE IDEAL WITH THE USE OF MULCH AND IRRIGATION. SEEDINGS COULD BE MADE ANY TIME THROUGHOUT THE GROWING SEASON.

5. THE SEEDING RATES NEED TO BE INCREASED TWO TO THREE TIMES IF THE MIXTURE IS TO BE USED AS A LAWN.

6. THE DWARF OR TURF-TYPE FESCUES ARE MUCH SHORTER AND HAVE FEWER LEAVES THAN THE TALL FESCUES. IT IS MUCH BETTER SUITED FOR LAWN-TYPE AREAS THAN TALL FESCUES.

7. DORMANT SEEDING

SEEDINGS SHOULD NOT BE PLANTED FROM OCTOBER 1 THROUGH NOVEMBER 20, DURING THIS PERIOD THE SEEDS ARE LIKELY TO GERMINATE BUT PROBABLY WILL NOT BE ABLE TO SURVIVE THE WINTER.

THE FOLLOWING METHODS MAY BE USED TO MAKE A "DORMANT SEEDING":

- FROM OCTOBER 1 THROUGH NOVEMBER 20, PREPARE THE SEEDBED, ADD THE REQUIRED AMOUNTS OF LIME AND FERTILIZER THEN MULCH AND ANCHOR. AFTER NOVEMBER 20, AND BEFORE MARCH 15, THE SELECTED SEED MIXTURE, INCREASE THE SEEDING RATES BY SEED MIXTURE, INCREASE THE SEEDING RATES BY 50 PERCENT FOR THIS TYPE SEEDING.
- FROM NOVEMBER 20 THROUGH MARCH 15, WHEN SOIL CONDITIONS PERMIT, PREPARE THE SEEDBED, LIME AND FERTILIZE, APPLY THE SELECTED SEED MIXTURE, AND MULCH AND ANCHOR. INCREASE THE SEEDING RATES BY 50 PERCENT FOR THIS TYPE OF SEEDING.
- APPLY SEED UNIFORMLY WITH A CYCLONE SEEDER, DRILL, CULPACKER SEEDER, OR HYDROSEEDER (SLURRY MAY INCLUDE SEED AND FERTILIZER) ON A FIRM, MOST SEEDBED. COVER TO A DEPTH OF 1/4 TO 1/2 INCH.
- WHERE FEASIBLE, EXCEPT WHEN A CULPACKER TYPE SEEDER IS USED, THE SEEDBED SHOULD BE FIRMLY FOLLOWING SEEDING OPERATIONS WITH A CULPACKER, ROLLER, OR LIGHT DRAG. ON SLOPING LAND SEEDING OPERATIONS SHOULD BE ON THE CONTOUR WHERE FEASIBLE.

**9. MULCHING**

A. MULCH SHALL BE APPLIED TO PROTECT THE SOIL AND PROVIDE A BETTER ENVIRONMENT FOR PLANT GROWTH.

B. MULCH SHALL CONSIST OF SMALL GRASS STRAW (PREFERABLY WHEAT OR RYE) AND SHALL BE APPLIED AT THE RATE OF TWO TONS PER ACRE OR 100 POUNDS (TWO TO THREE BALES) PER 1000 SQUARE FEET.

C. SPREAD THE MULCH UNIFORMLY BY HAND OR MECHANICALLY SO THE SOIL SURFACE IS COVERED.

D. MULCH ANCHORING METHODS

- OTHER SEED SPECIES MAY BE SUBSTITUTED FOR THESE MIXTURES. CHECK WITH LOCAL SCS OFFICE FOR RECOMMENDATIONS.
- SEEDING DATES ARE IDEAL WITH THE USE OF MULCH AND IRRIGATION. SEEDINGS COULD BE MADE ANY TIME THROUGHOUT THE GROWING SEASON.
- THE SEEDING RATES NEED TO BE INCREASED TWO TO THREE TIMES IF THE MIXTURE IS TO BE USED AS A LAWN.
- THE DWARF OR TURF-TYPE FESCUES ARE MUCH SHORTER AND HAVE FEWER LEAVES THAN THE TALL FESCUES. IT IS MUCH BETTER SUITED FOR LAWN-TYPE AREAS THAN TALL FESCUES.

**MAINTENANCE FERTILIZATION AND MOWING FOR PERMANENT SEEDING FERTILIZER RATE**

MIXTURE	FORMULA	LBS./AC.	LBS./1000	TIME	MOWING
CREEPING RED FESCUE, RYEGRASS, KENTUCKY BLUEGRASS	10-10-10	500	12	FALL YEARLY OR AS NEEDED	NOT CLOSER THAN 3"
TALL FESCUE	10-10-10	500	12	FALL YEARLY OR AS NEEDED	NOT CLOSER THAN 4"
DWARF TURF	10-10-10	500	12	FALL YEARLY OR AS NEEDED	NOT CLOSER THAN 2"
FLAT PEA AND CROWNWITCH WITH FESCUE	0-20-20	400	10	SPRING YEARLY FOLLOWING ESTABLISHMENT AND EVERY 4-7 YEARS THEREAFTER	DO NOT MOW

**GRADING AND EROSION CONTROL SCHEDULE**




AUGUST - INSTALL PERIMETER EROSION CONTROLS. COMMENCE CLEANING AND GRUBBING. ALL MEASURES TO TRAP SEDIMENT SHALL BE CONSTRUCTED AND COMPLETED BEFORE UPSLOPE CLEANING AND GRADING ACTIVITIES ARE PERMITTED TO TAKE PLACE.

AUGUST 2018 - BEGIN GRADING ON SITE.

AUGUST TO SEPTEMBER 2018 - CONTINUE GRADING & MAINTAIN EROSION CONTROL & SEDIMENT CONTROLS.

SEPTEMBER 2018 TO NOVEMBER 2018 - UTILITY INSTALLATION & FINAL GRADING.

NOVEMBER 2018 - FINAL GRADING & PAVING, FINAL STABILIZATION OF EROSION & SEDIMENT CONTROLS PRIOR TO HOME CONSTRUCTION.

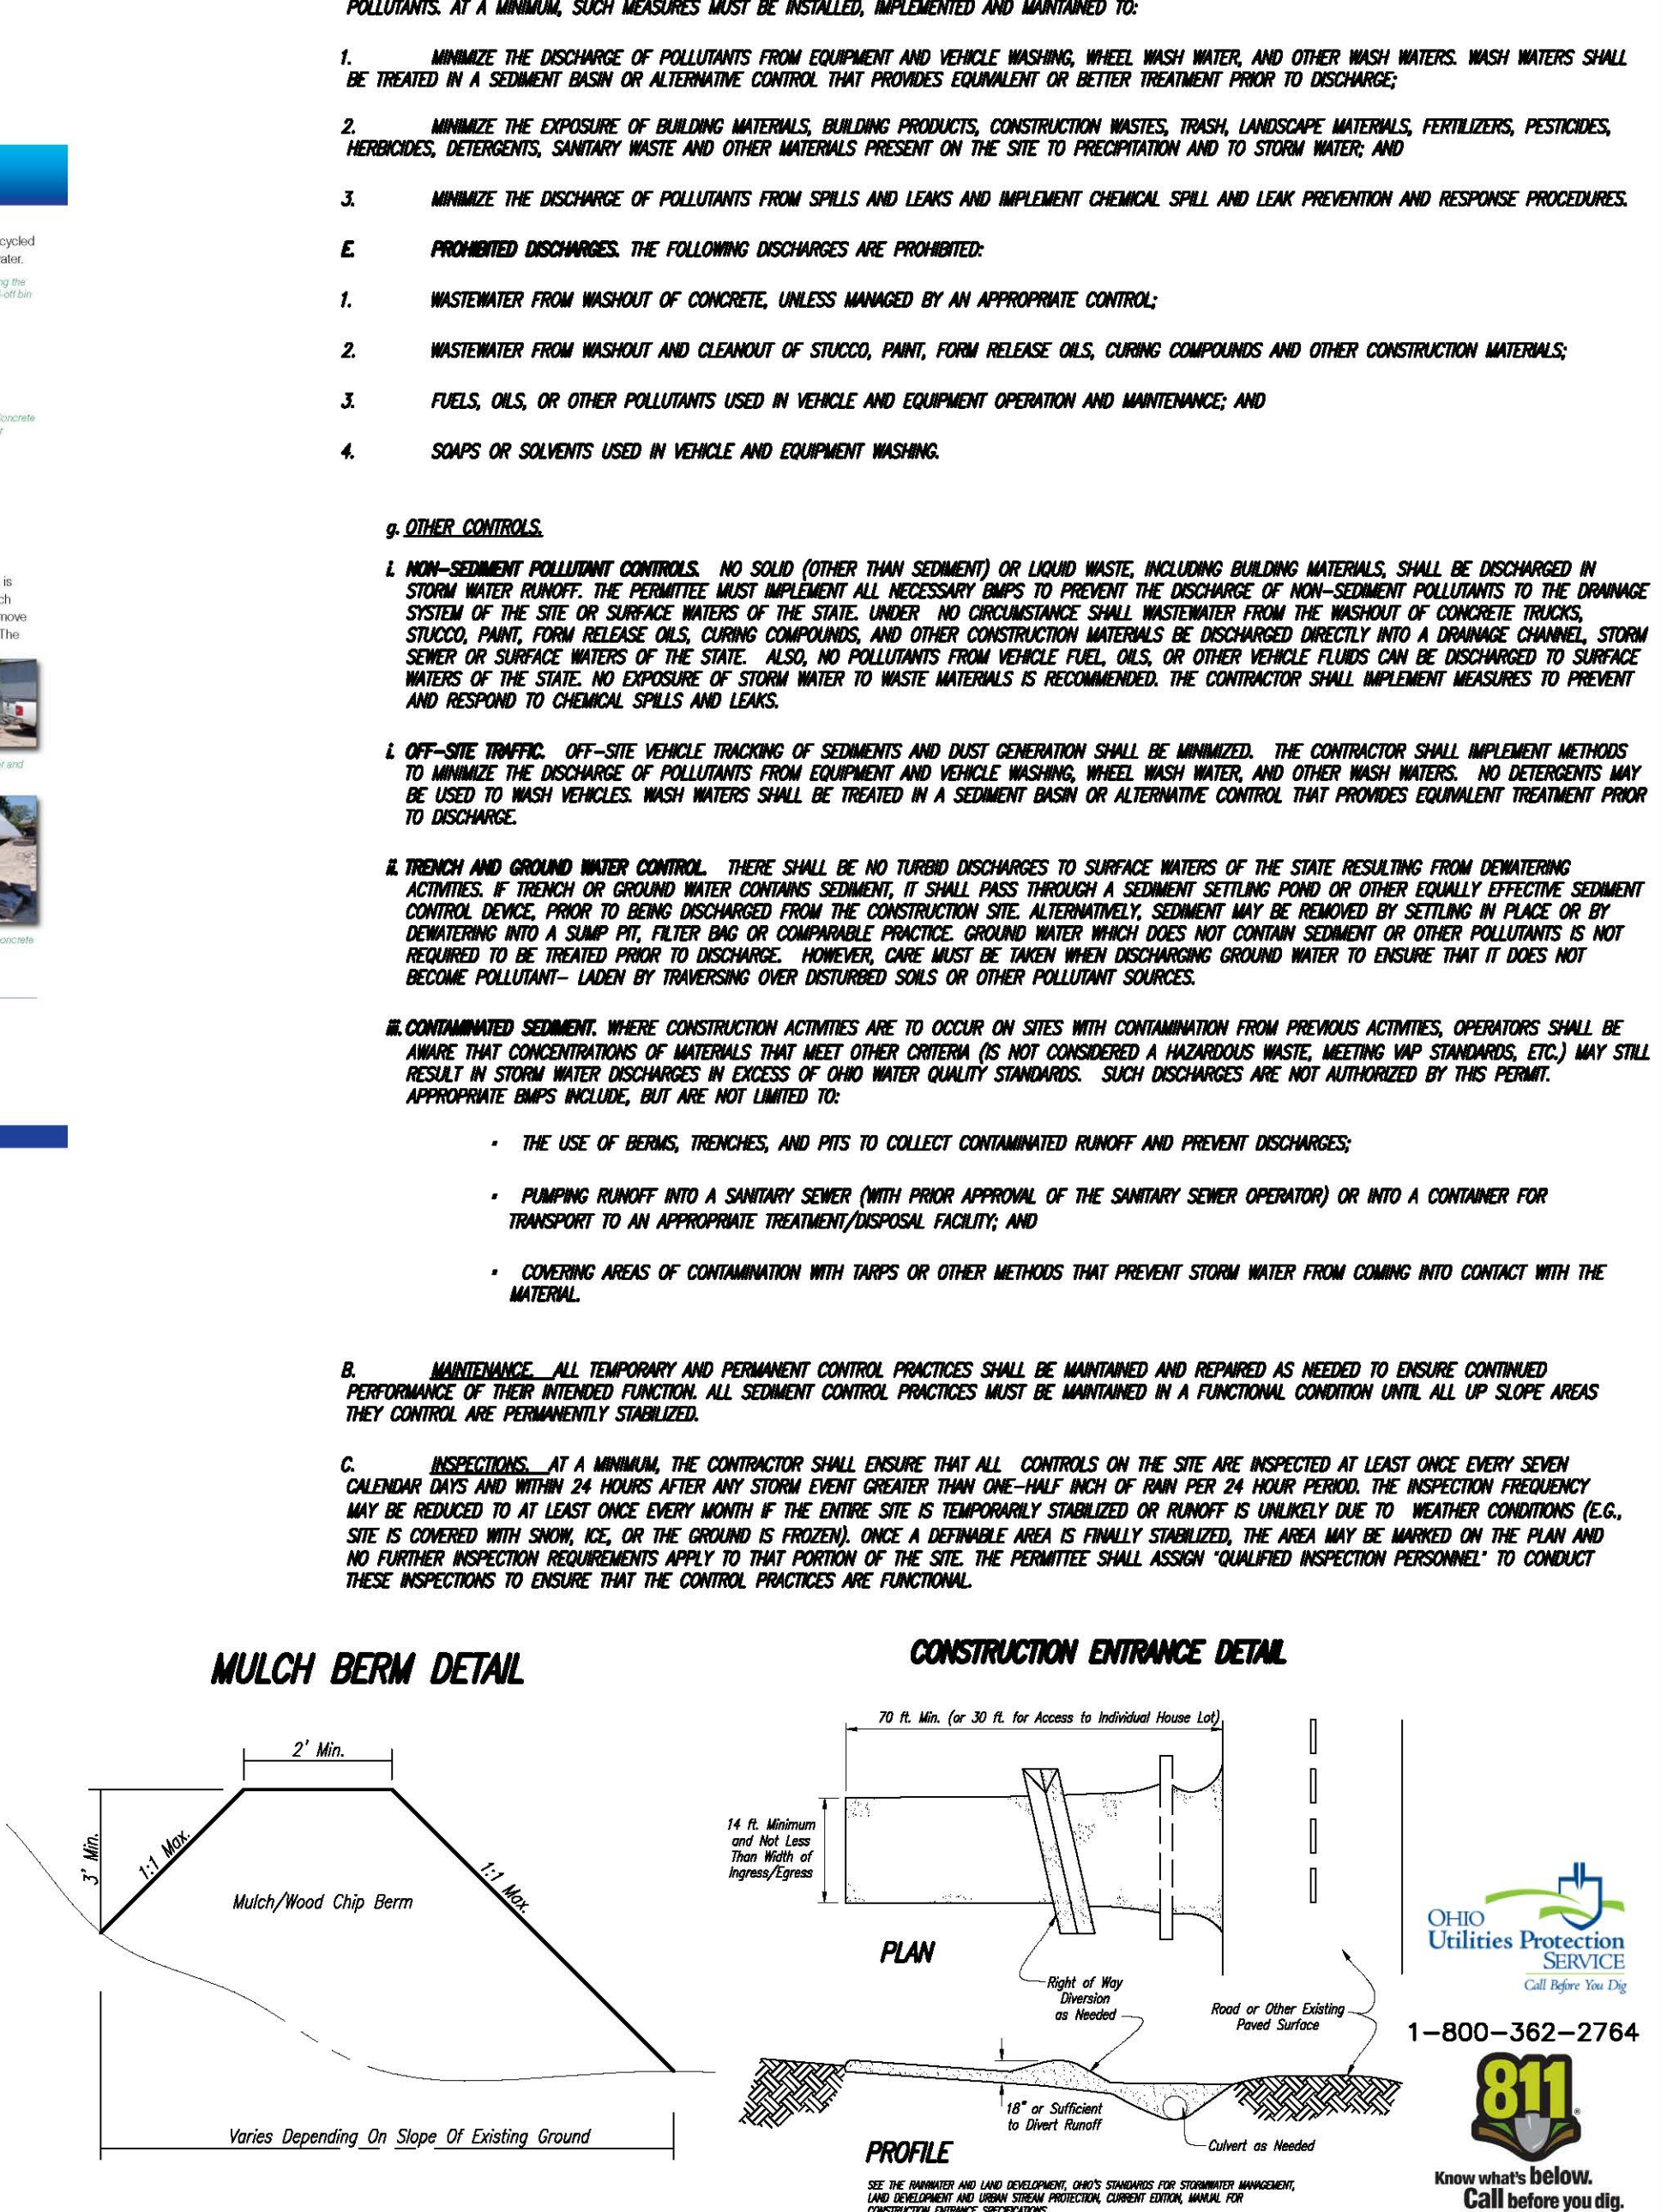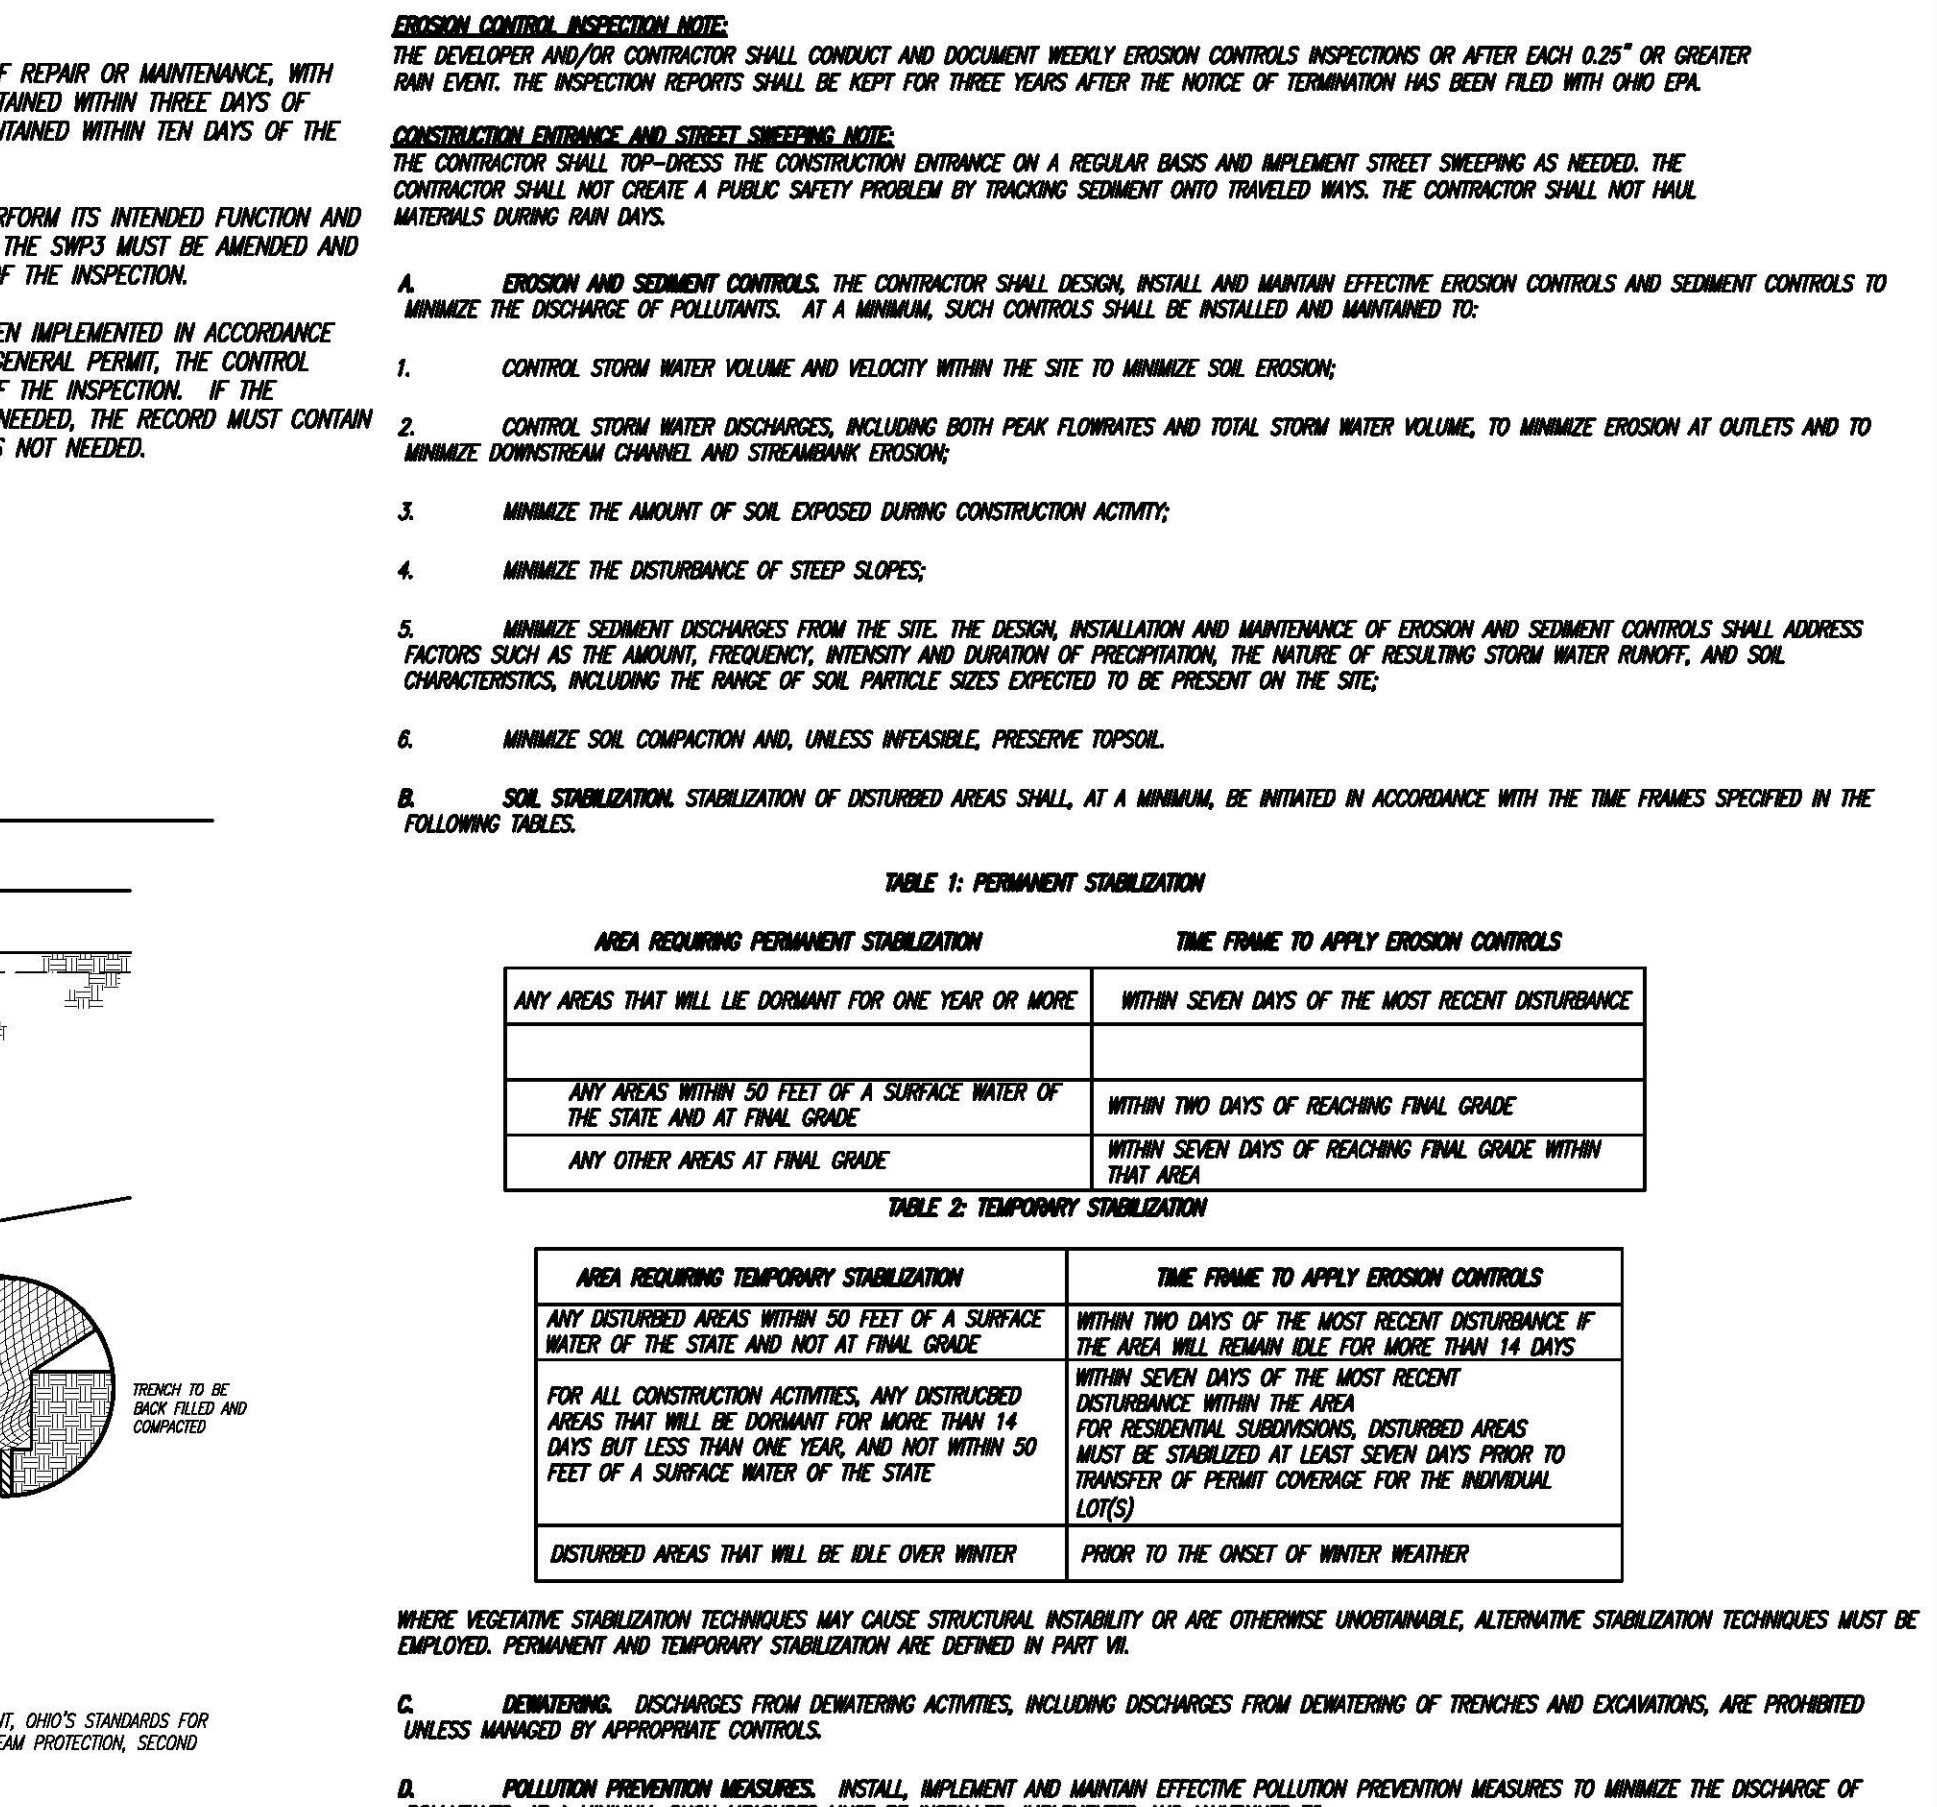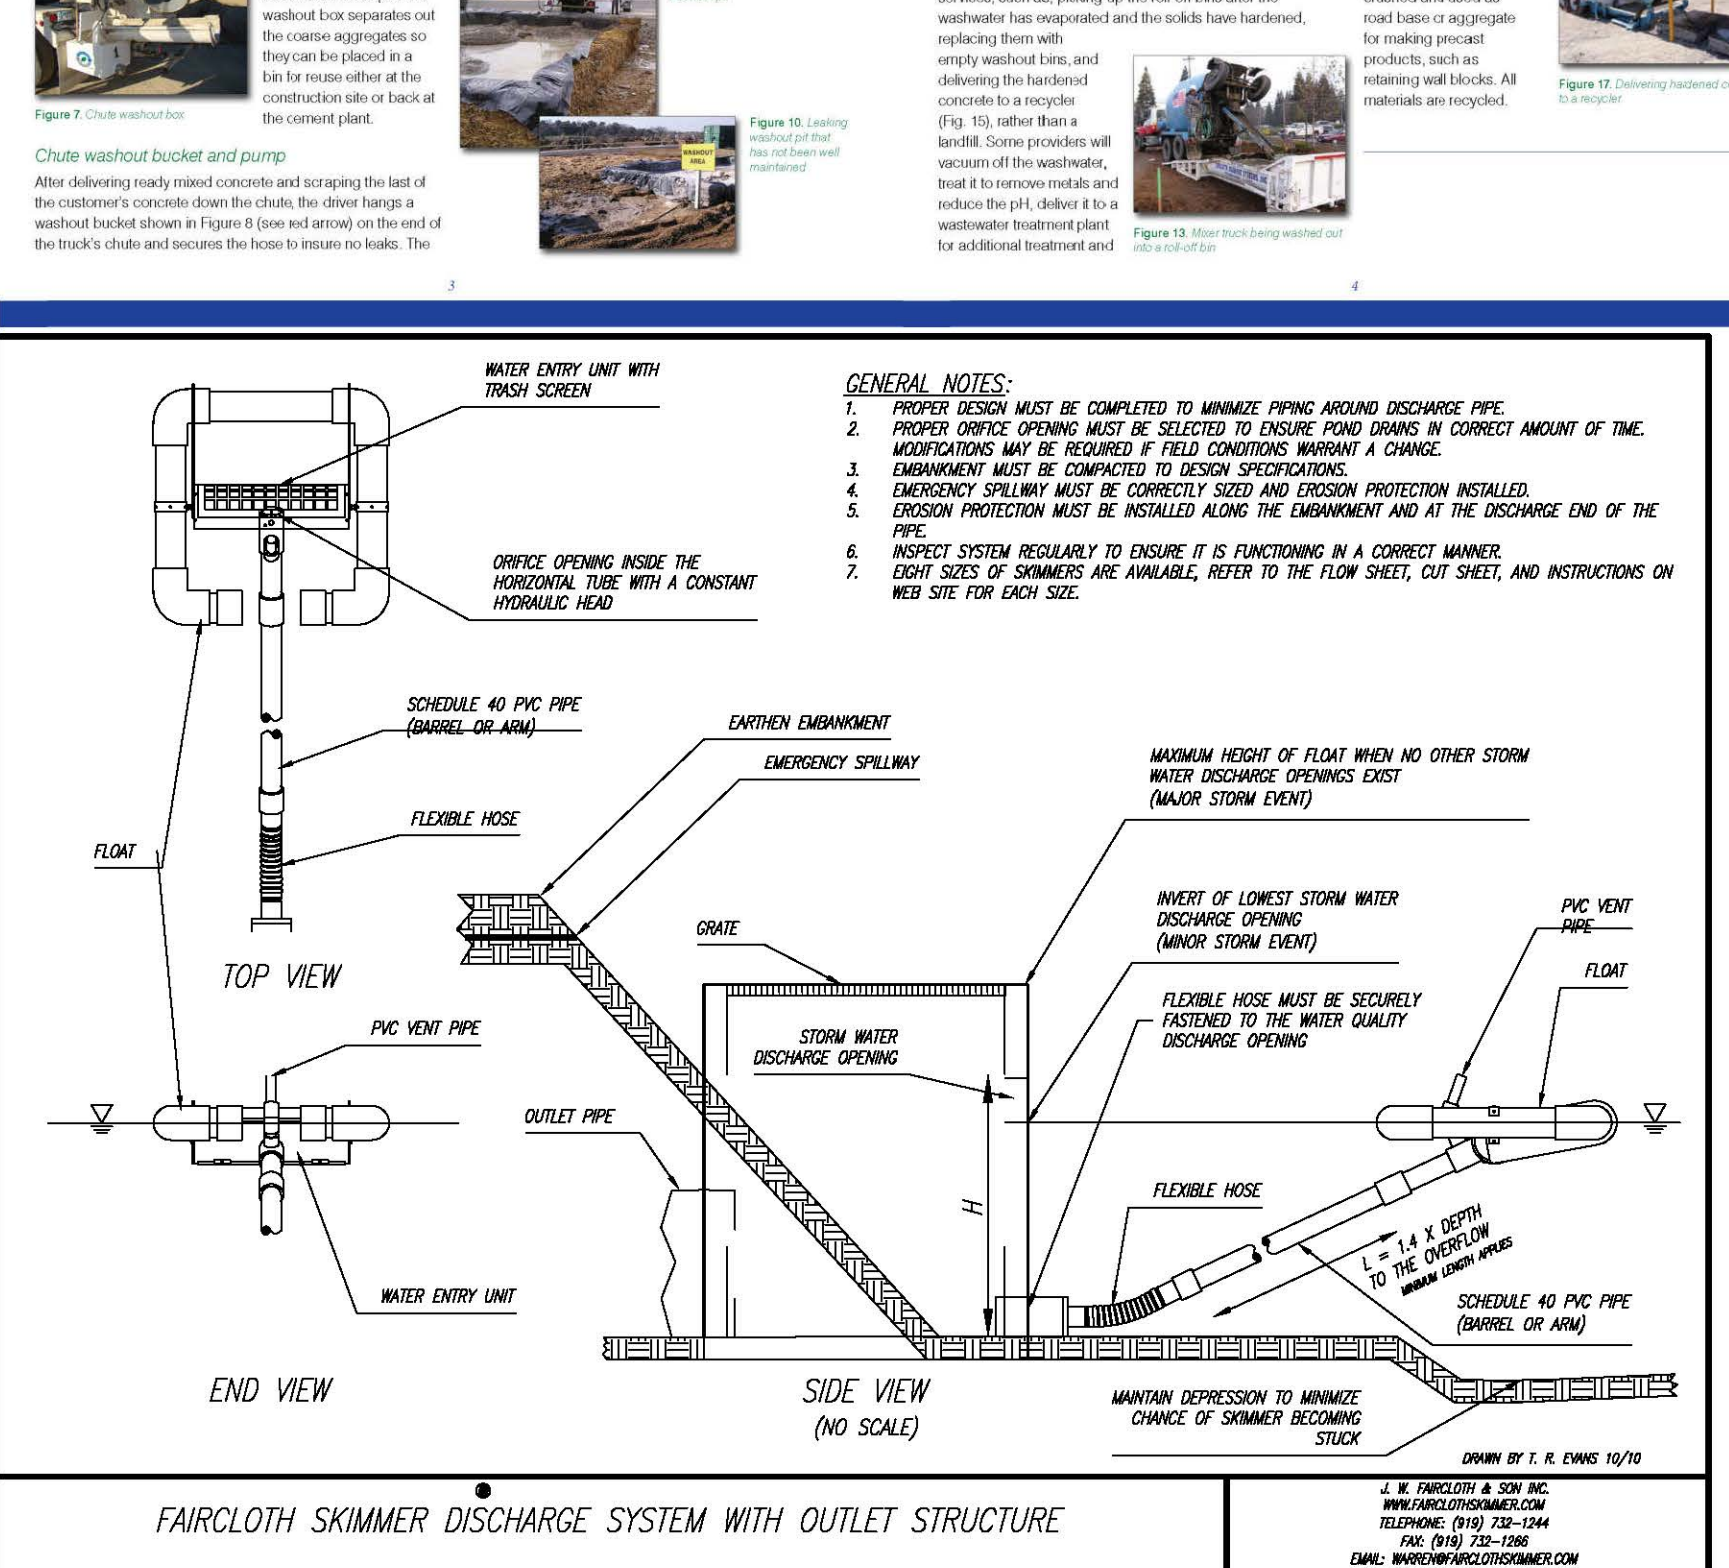

**ARBOR PARK**

**DETAIL SHEET**

Section: SECTION-21, TOWN-3, RANGE-3

Project: LIBERTY TOWNSHIP BUTLER COUNTY, OHIO

Scale: 1" = 50'

Drawn By: D.L.

Checked By: B.R.

Date: 7-20-18

Revisions:

1. 8-1-18, Miller & Sinner, Annotations & Rev. Set

2. 8-15-18, Miller & Sinner, Annotations & Rev. Set

3. 8-15-18, Miller & Sinner, Annotations & Rev. Set

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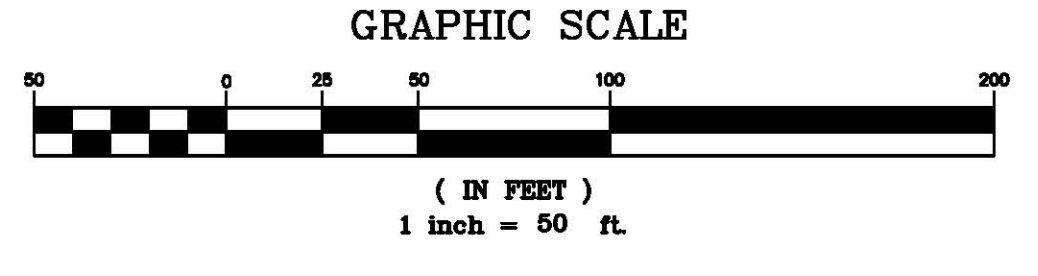
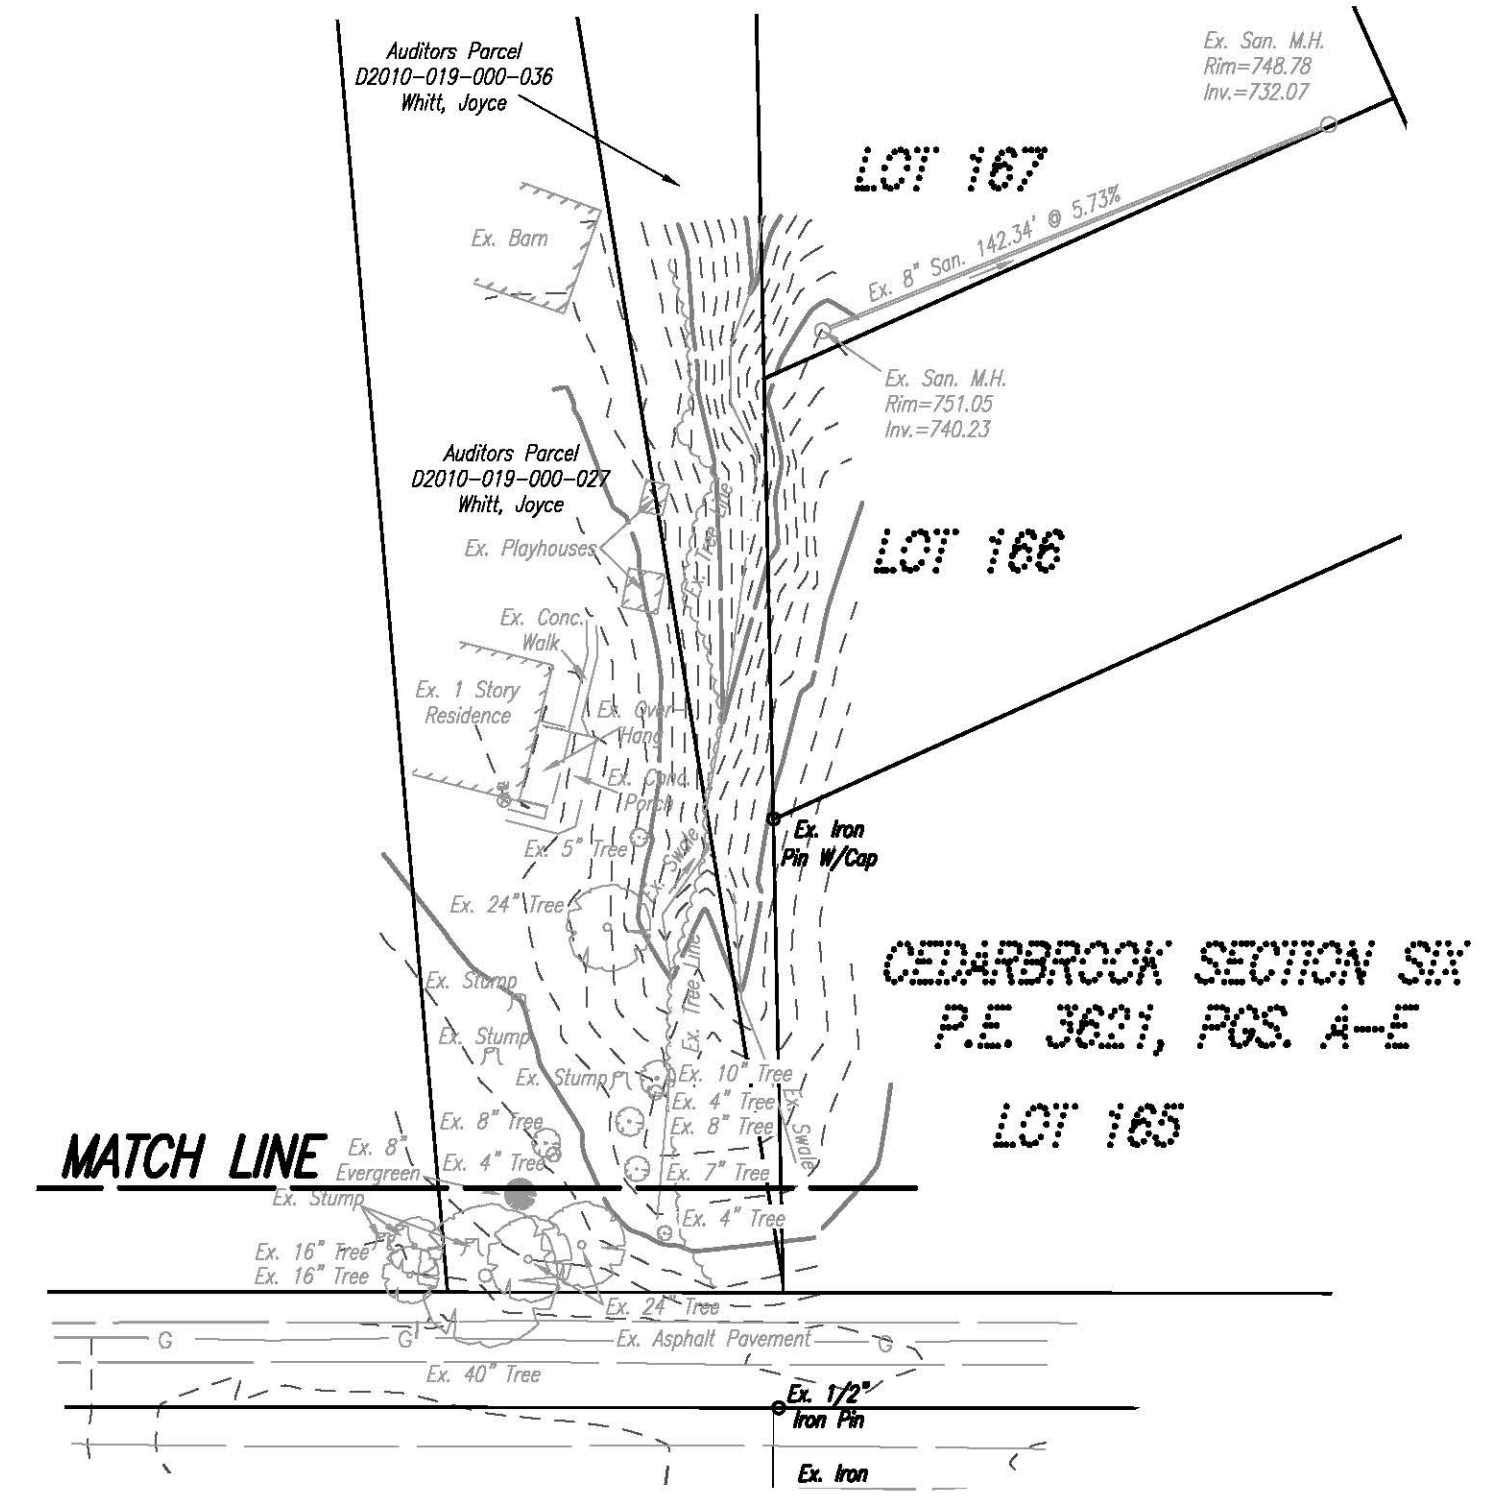
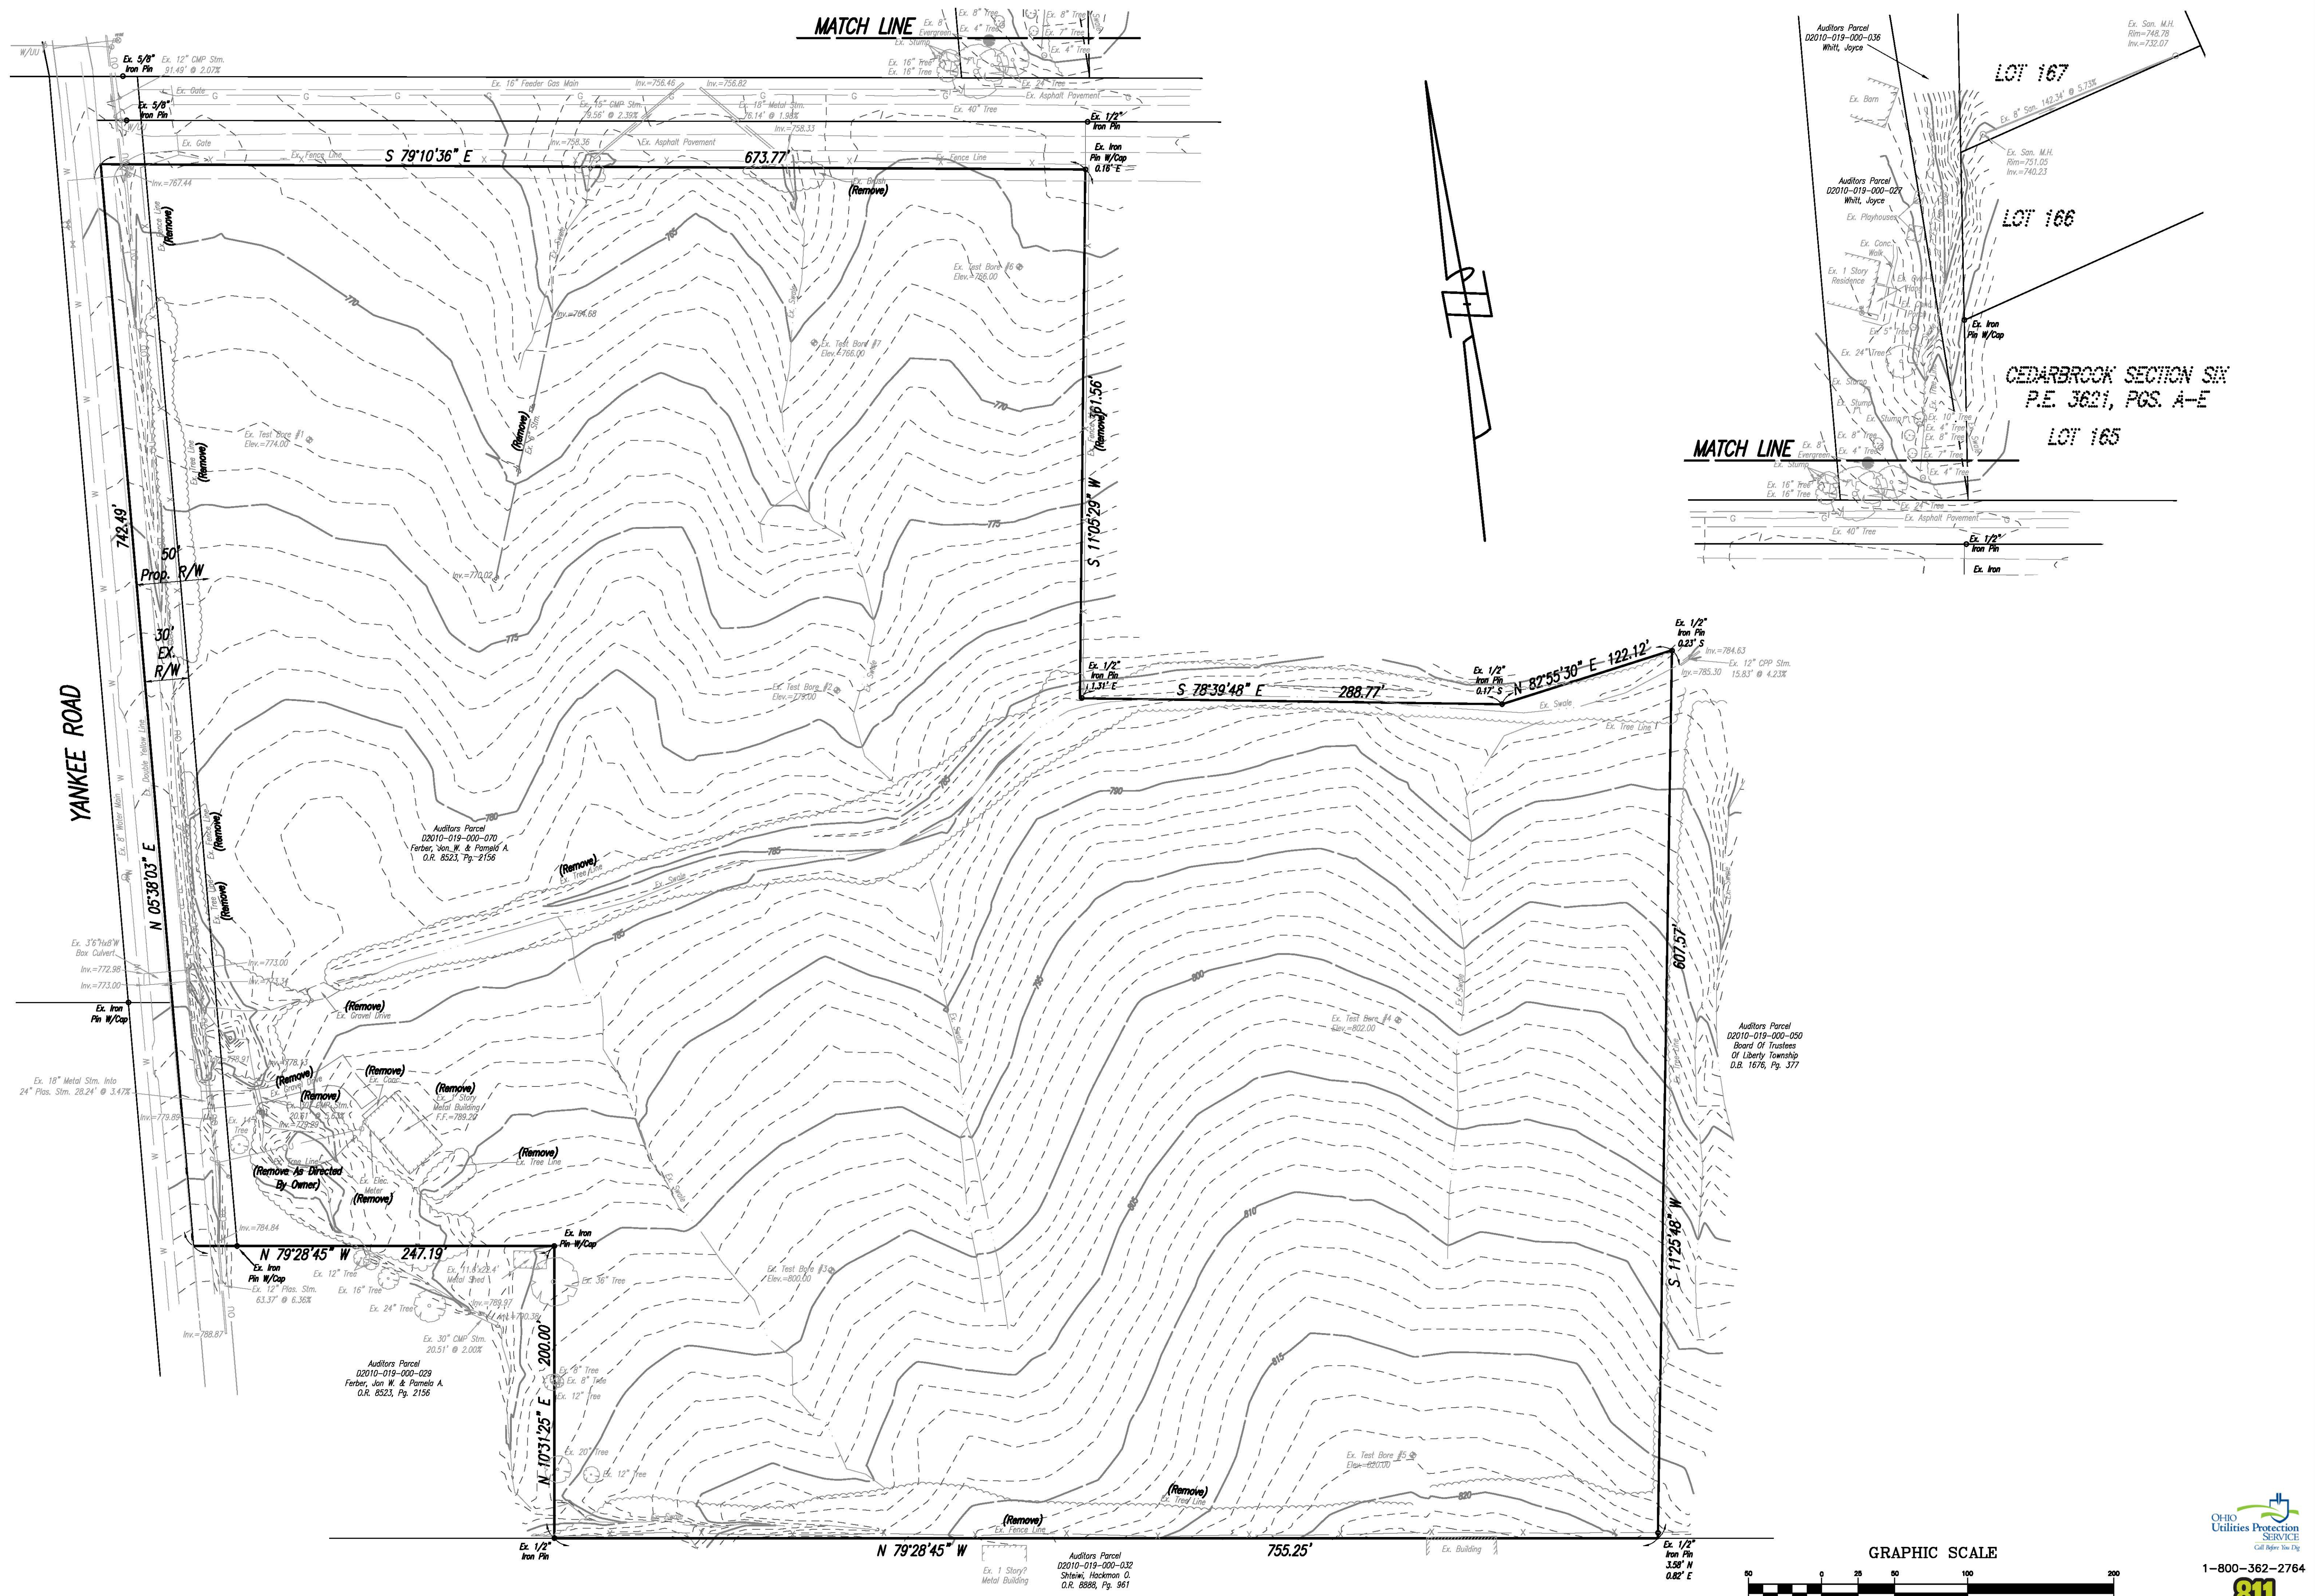
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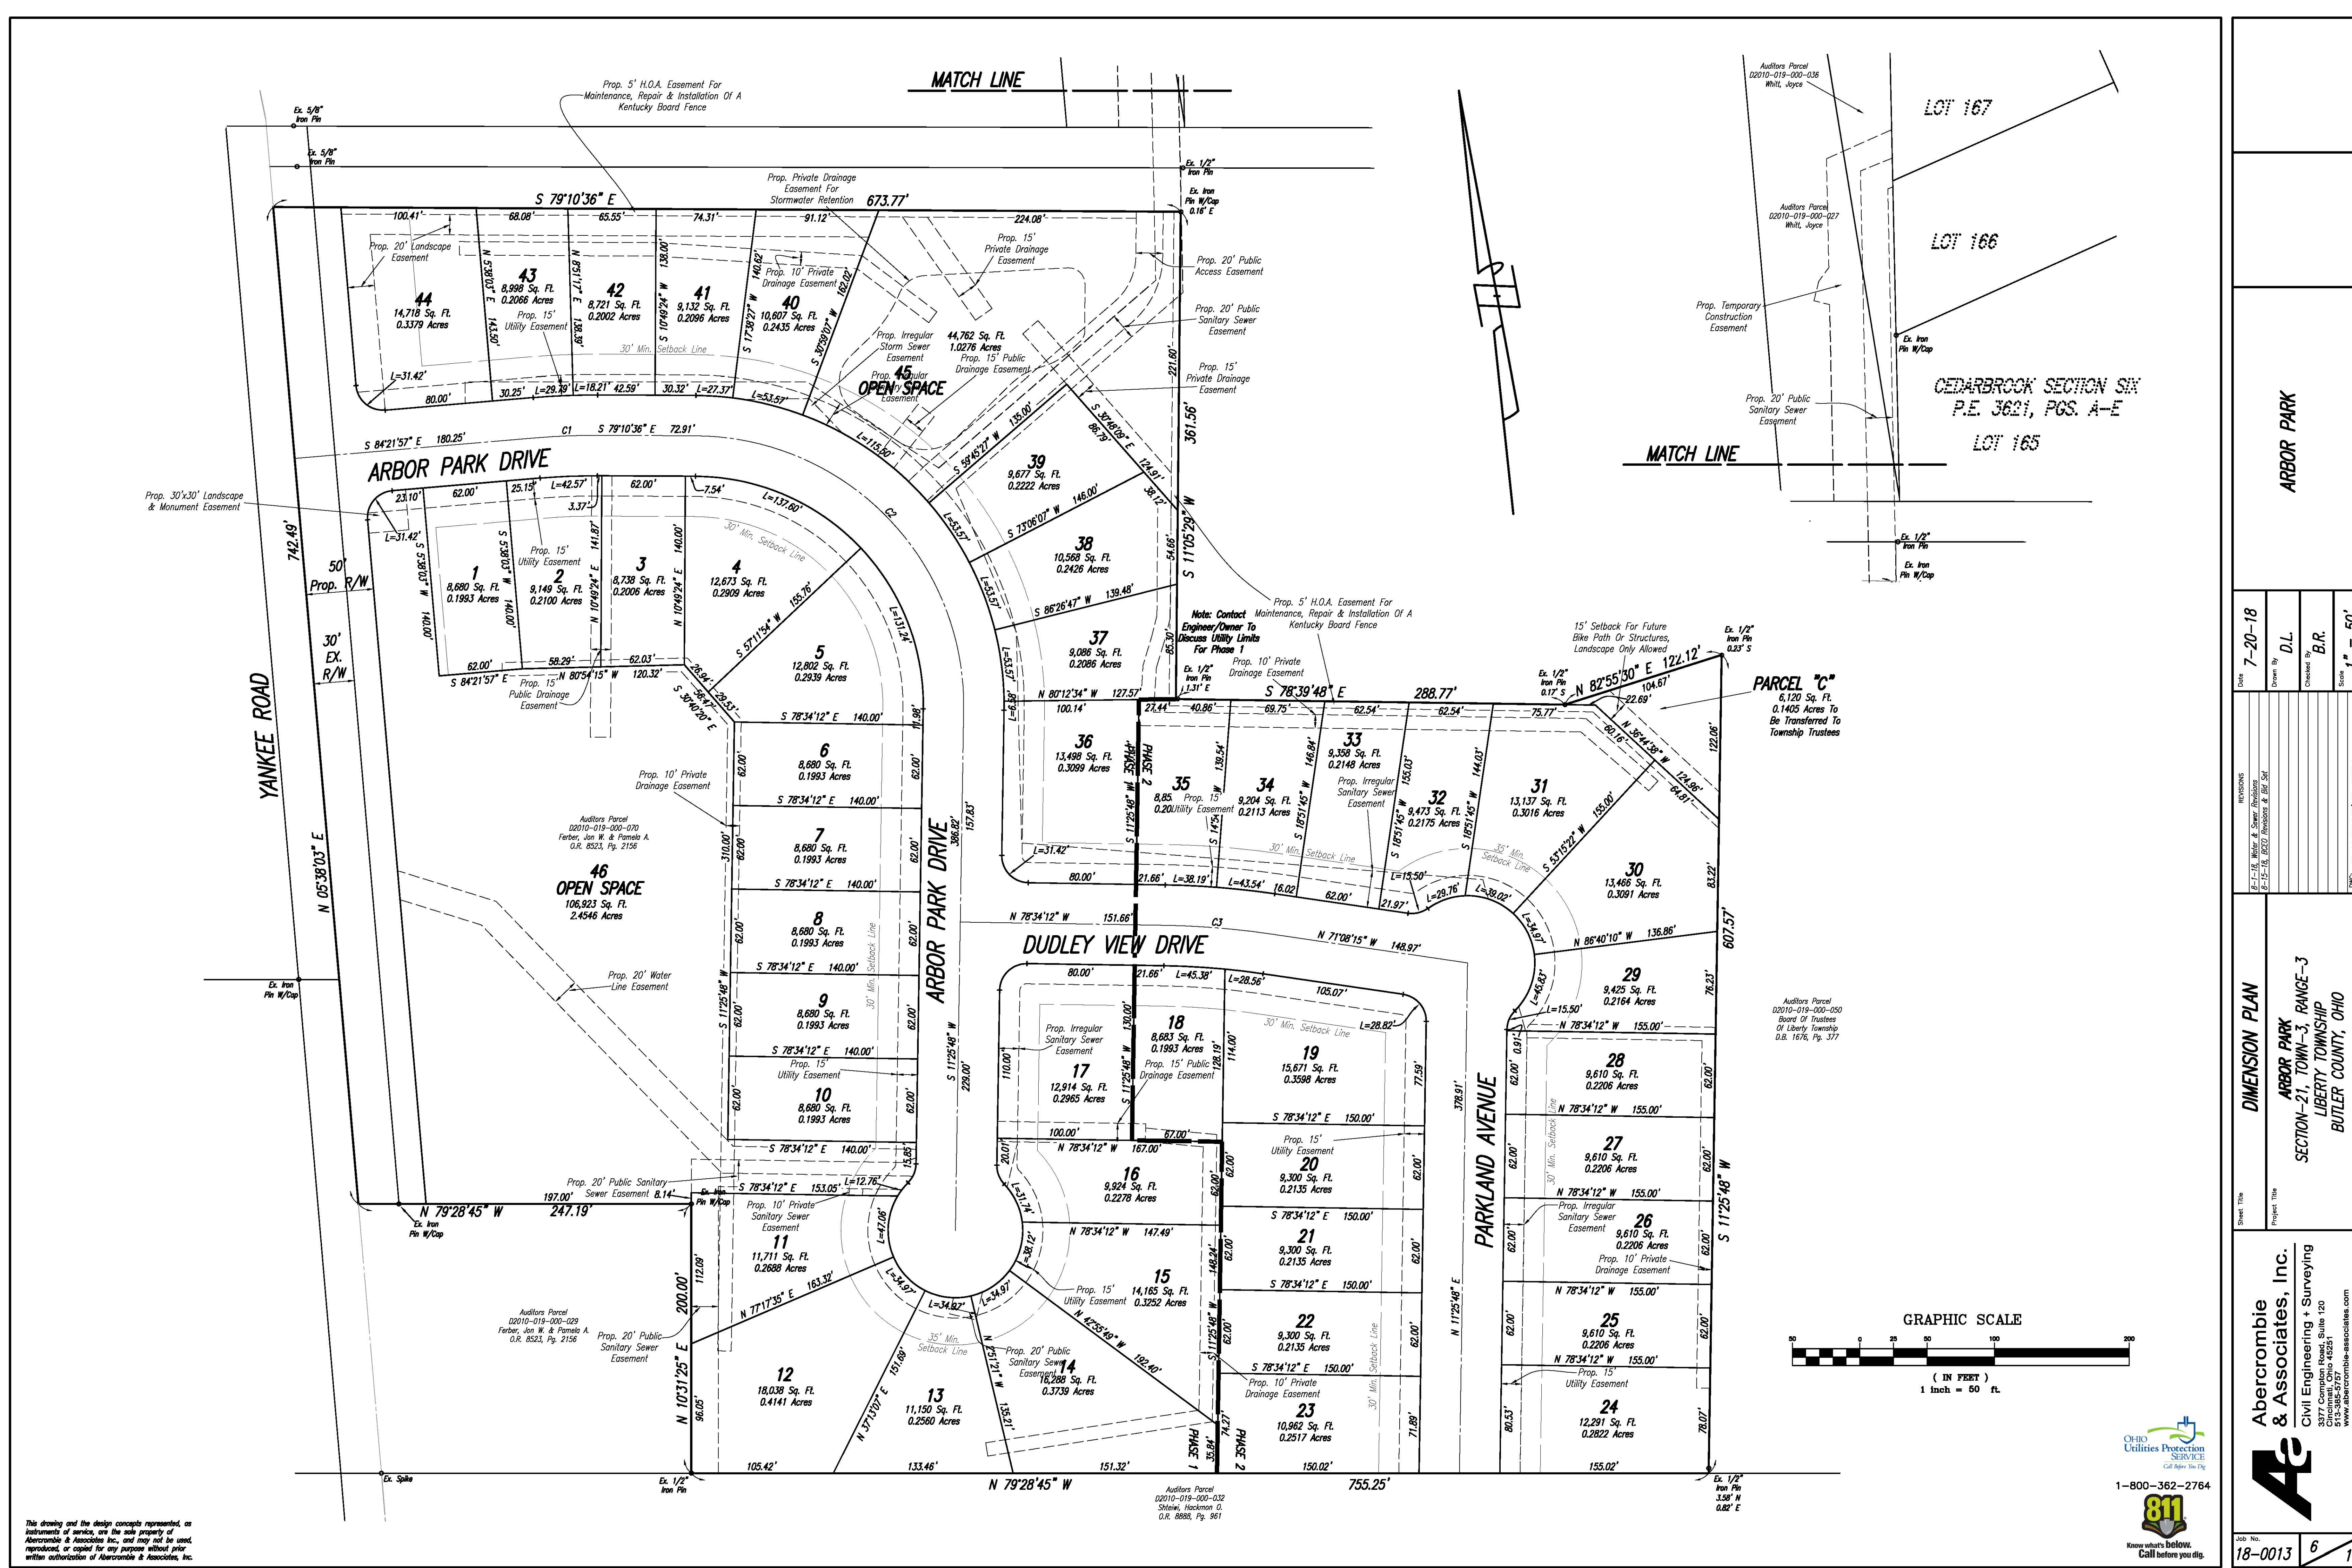
<b>ARBOR PARK</b>	
Date	7-20-18
Drawn By	D.L.
Checked By	B.R.
Scale	1" = 50'
REVISIONS	18-001305GM(DL-D56N)
Sheet Title	<b>EX. CONDITIONS &amp; DEMO PLAN</b>
Project Title	<b>ARBOR PARK SECTION-21, TOWN-3, RANGE-3 LIBERTY TOWNSHIP BUTLER COUNTY, OHIO</b>
Client	<b>Abercrombie &amp; Associates, Inc.</b> Civil Engineering + Surveying 3377 Compton Road, Suite 120 Cincinnati, Ohio 45251 www.abercrombie-associates.com
Job No.	18-0013
Sheet No.	5
Total Sheets	10

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**ARBOR PARK**

**DIMENSION PLAN**

ARBOR PARK  
SECTION-21, TOWN-3, RANGE-3  
LIBERTY TOWNSHIP  
BUTLER COUNTY, OHIO

Job No. 18-0013 6 10

Date	7-20-18
Drawn By	D.L.
Checked By	B.R.
Scale	1" = 60'

REVISIONS

8-1-18, Utility & Sewer Dimensions	
8-15-18, E&S Dimensions & Blk Set	

Sheet Title: DIMENSION PLAN  
Project Title: ARBOR PARK SECTION-21, TOWN-3, RANGE-3 LIBERTY TOWNSHIP BUTLER COUNTY, OHIO



**Abercrombie & Associates, Inc.**  
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3377 Compton Road, Suite 120  
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18-0013050M(DL-DSSN)








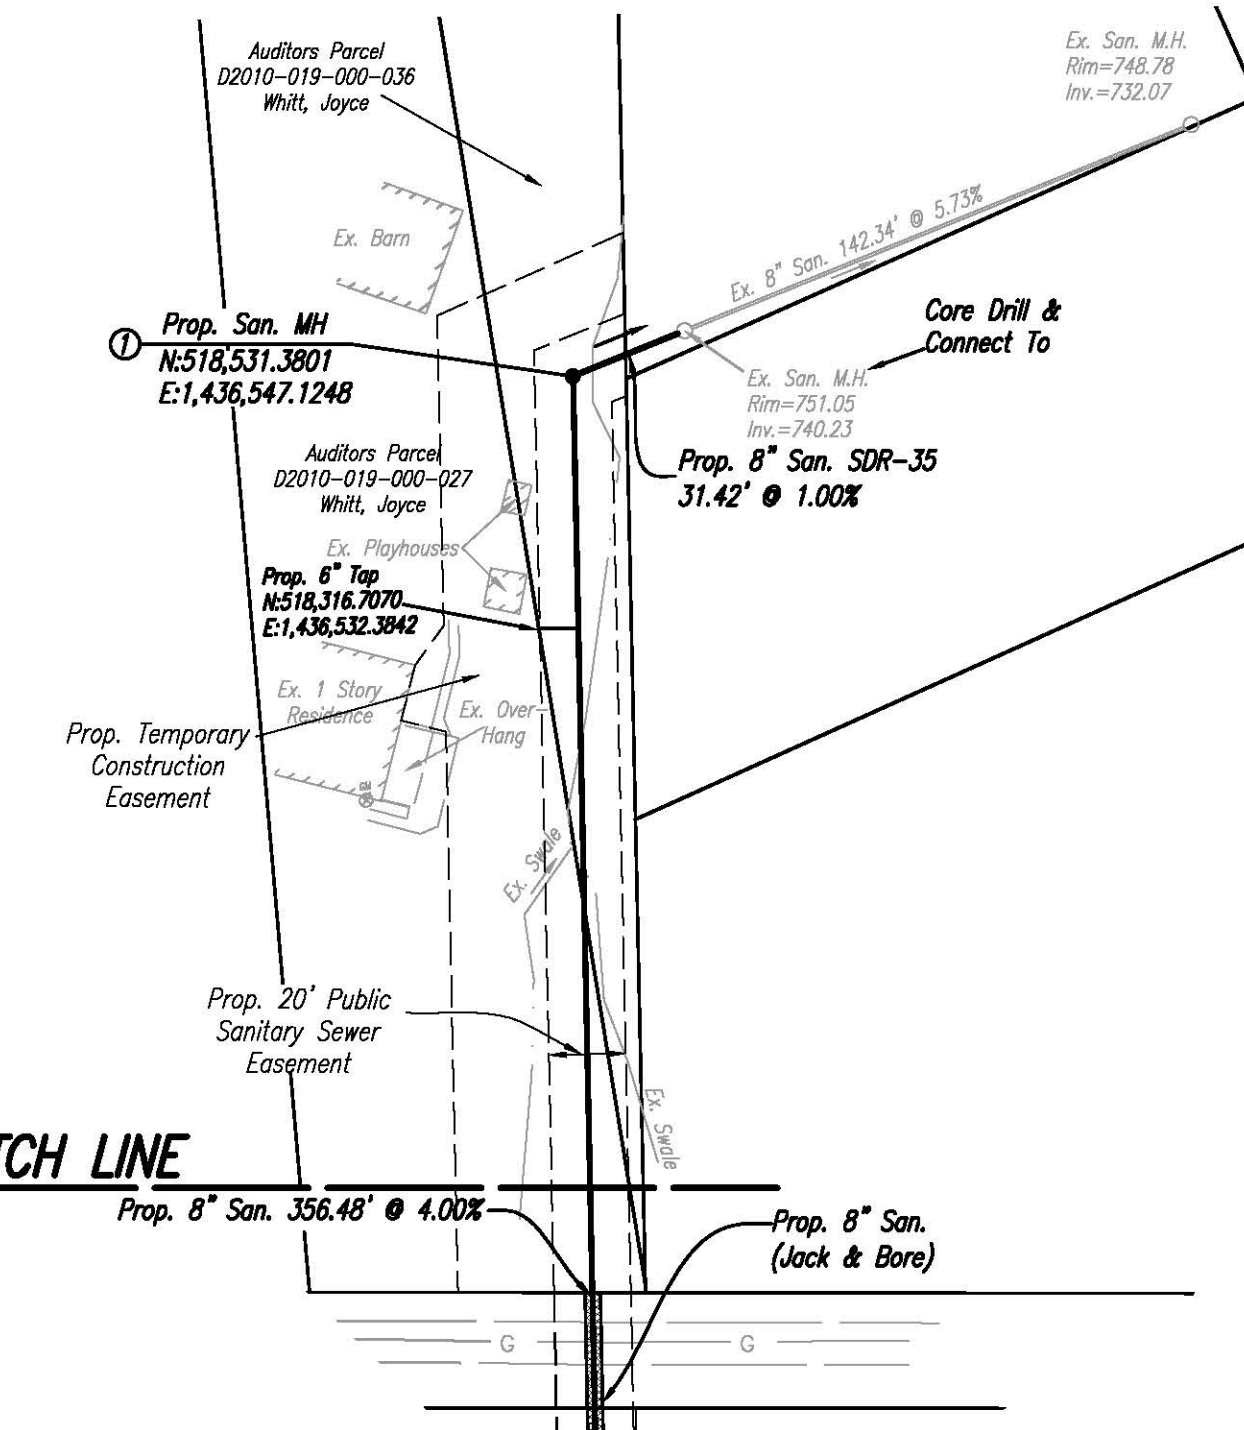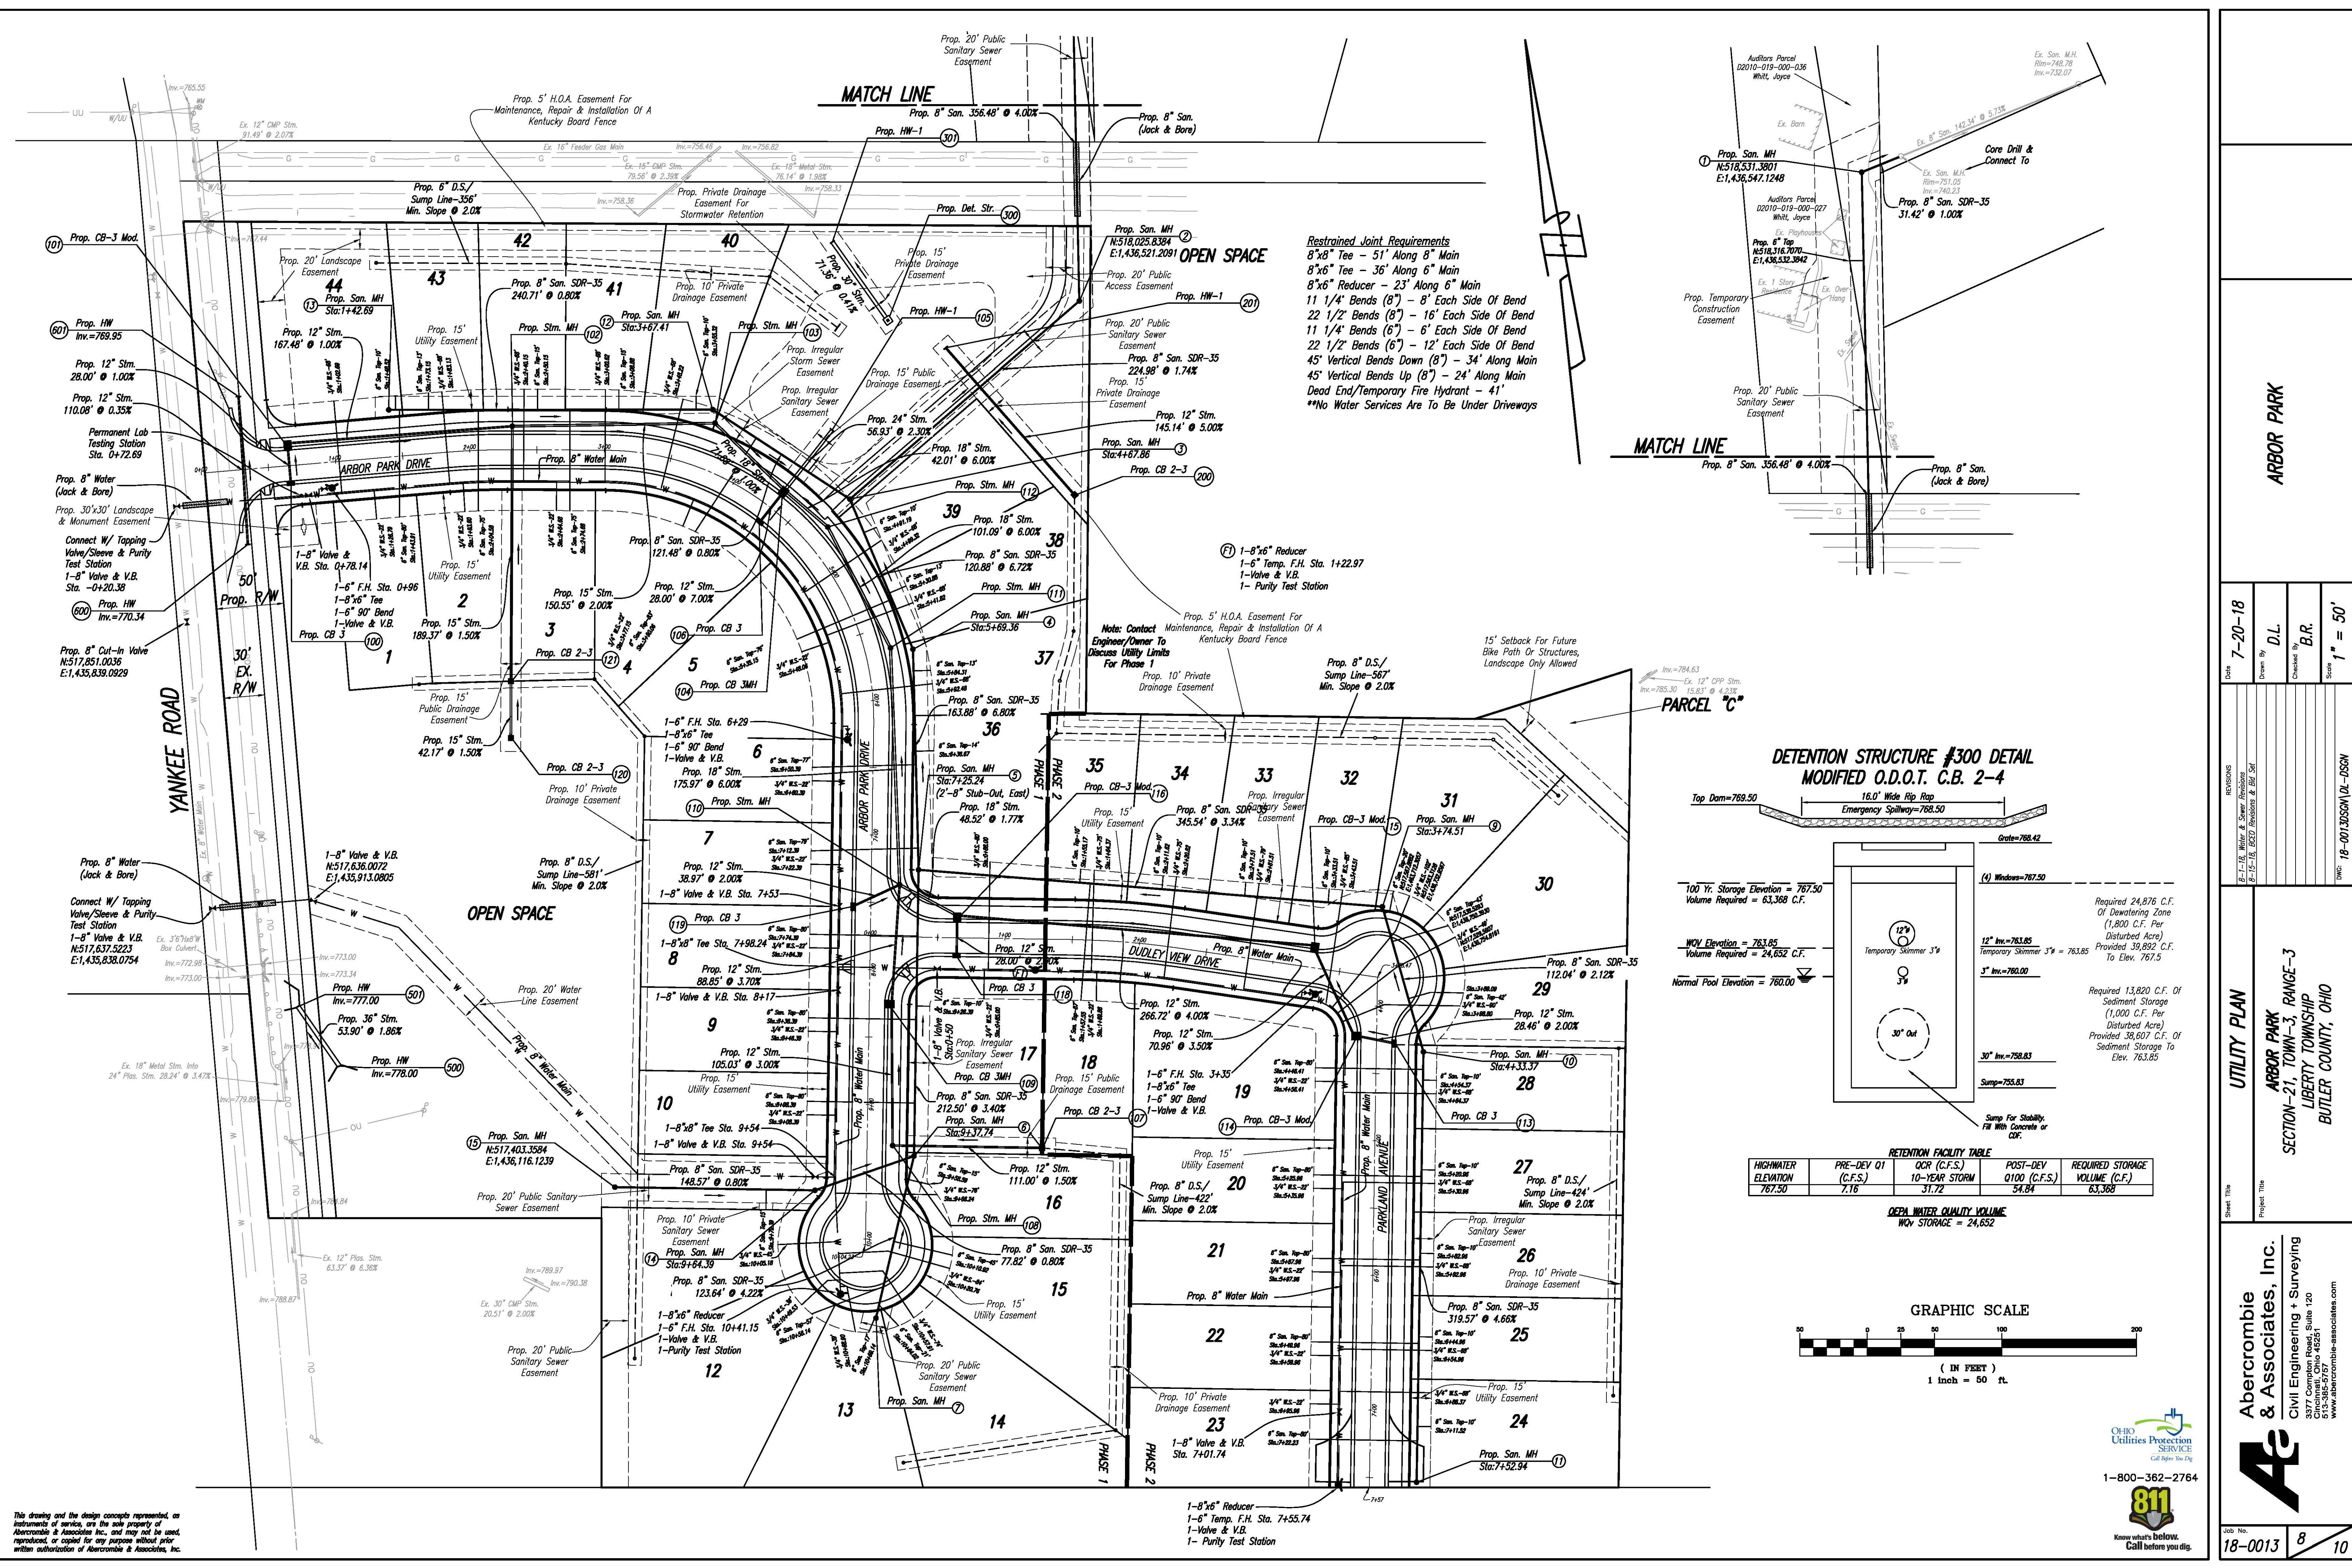

**RETENTION FACILITY TABLE**

HIGHWATER ELEVATION	PRE-DEV Q1 (C.F.S.)	OCR (C.F.S.)	POST-DEV Q100 (C.F.S.)	REQUIRED STORAGE VOLUME (C.F.)
767.30	7.16	31.72	54.84	63,368

**DETAILED WATER QUALITY VOLUME**  
WQV STORAGE = 24,652

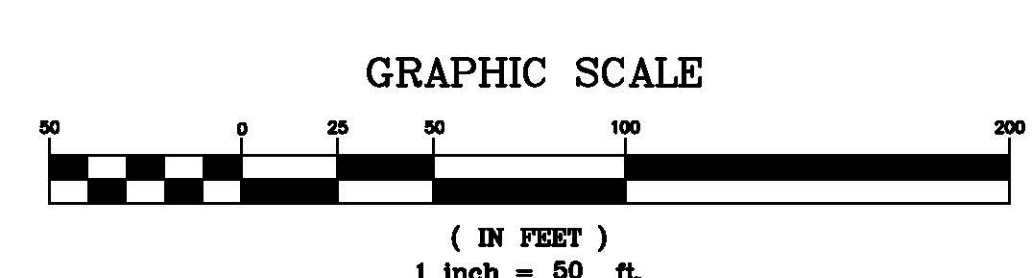

**Restrained Joint Requirements**  
 8"x8" Tee - 51' Along 8" Main  
 8"x6" Tee - 36' Along 6" Main  
 8"x6" Reducer - 23' Along 6" Main  
 11 1/4' Bends (8") - 8' Each Side Of Bend  
 22 1/2' Bends (8") - 16' Each Side Of Bend  
 11 1/4' Bends (6") - 6' Each Side Of Bend  
 22 1/2' Bends (6") - 12' Each Side Of Bend  
 45' Vertical Bends Down (8") - 34' Along Main  
 45' Vertical Bends Up (8") - 24' Along Main  
 Dead End/Temporary Fire Hydrant - 41'  
 \*\*No Water Services Are To Be Under Driveways

**PARCEL "C"**

**ARBOR PARK**

7-20-18  
 Drawn By: D.L.  
 Checked By: B.R.  
 Scale: 1" = 50'

**UTILITY PLAN**

**ARBOR PARK**  
 SECTION-21, TOWN-3, RANGE-3  
 LIBERTY TOWNSHIP  
 BUTLER COUNTY, OHIO

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 Civil Engineering + Surveying  
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**811**  
 Know what's below.  
 Call before you dig.


JOB NO. 18-0013 8 10

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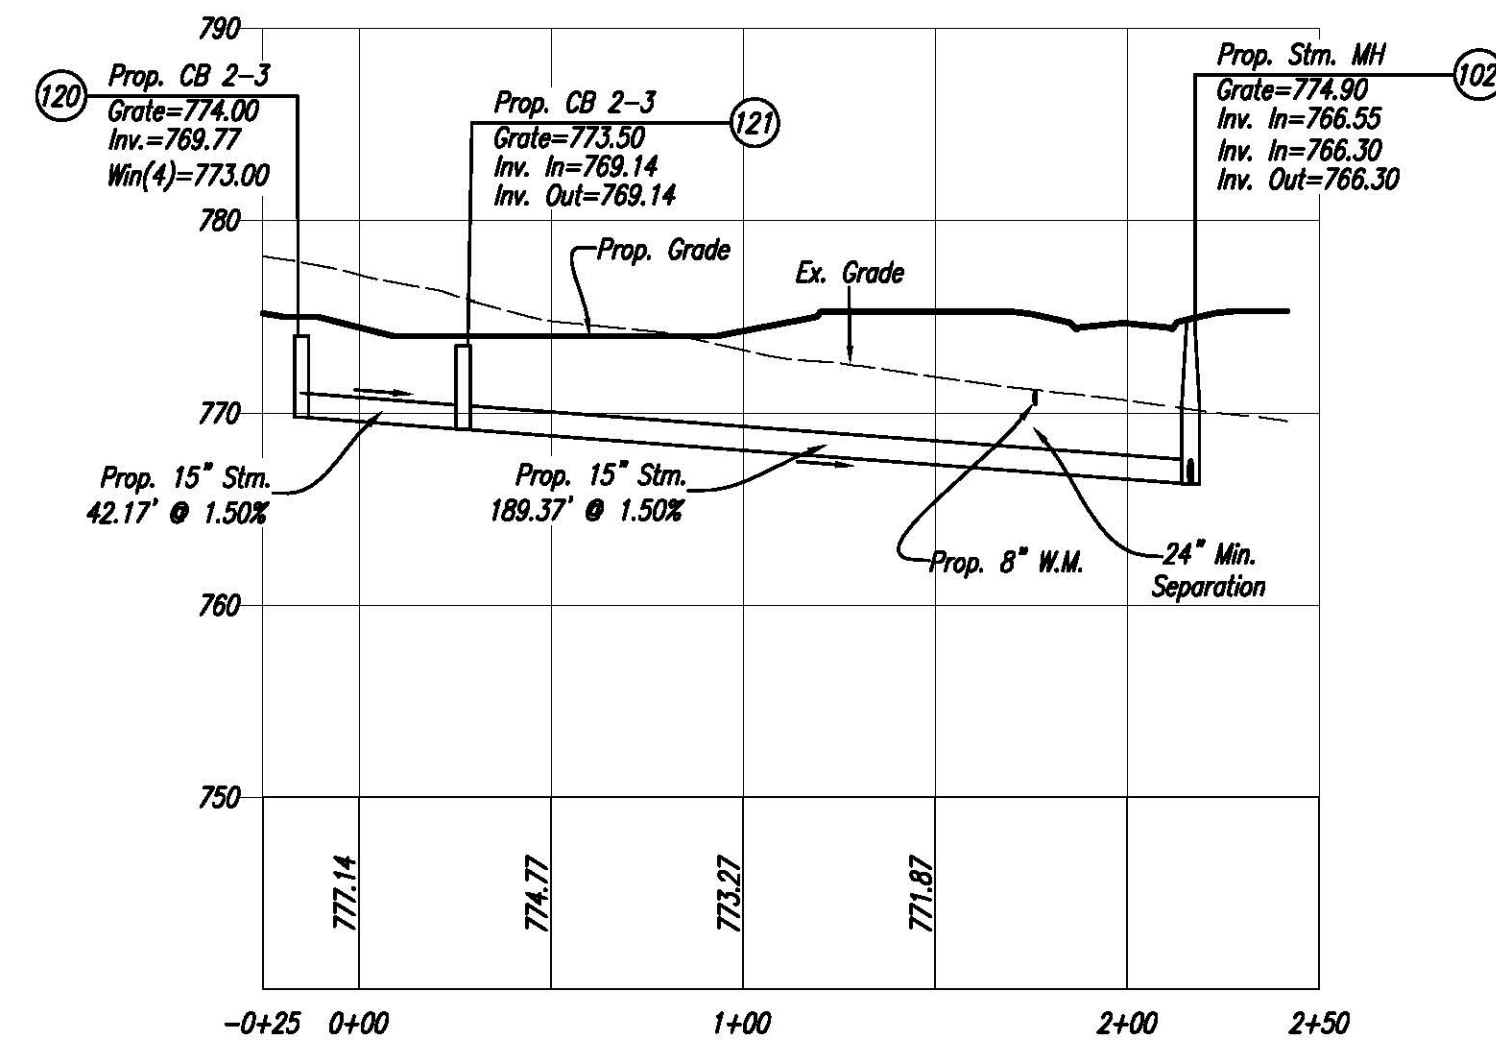







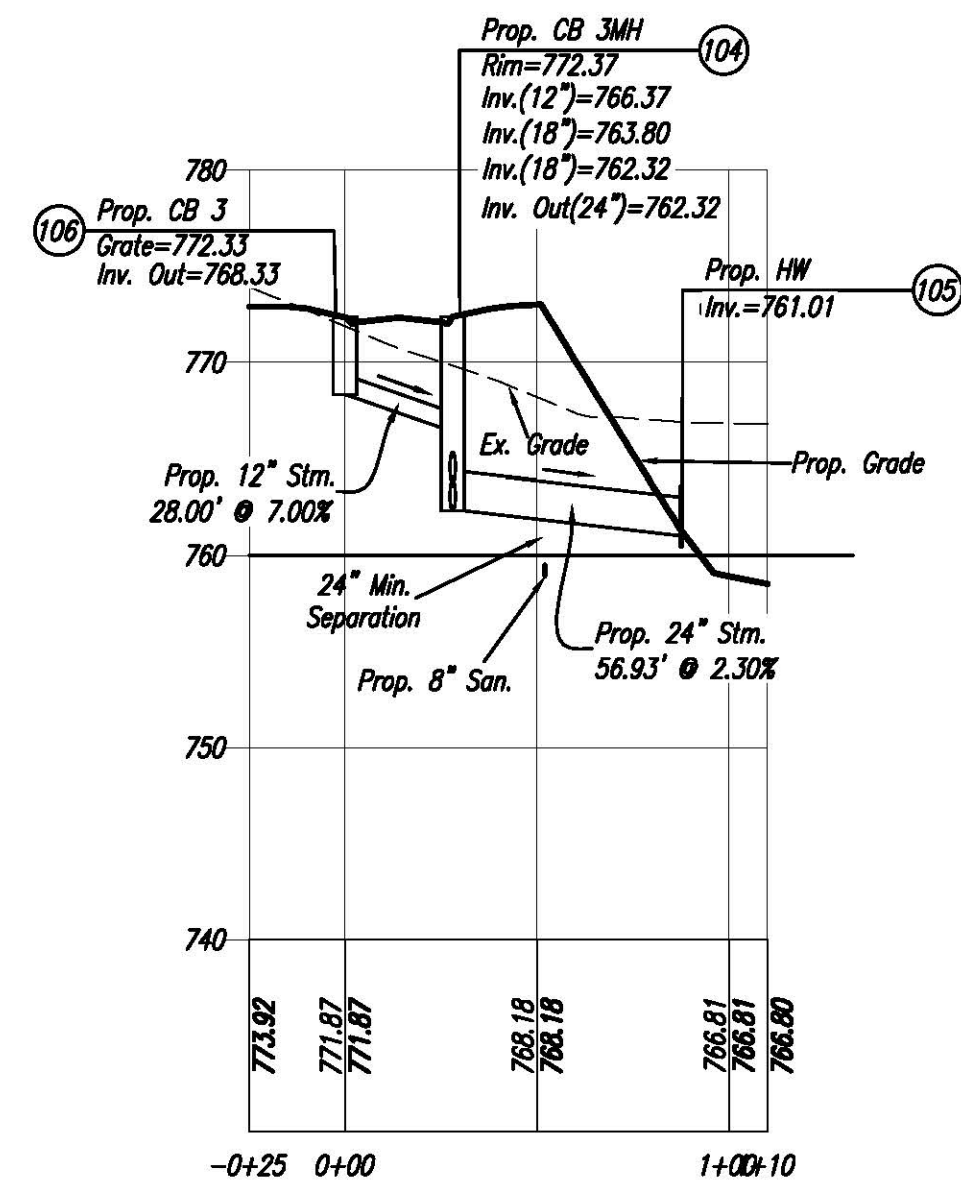


PROP. STM #105 TO #106




PROP. STM #120 TO #102

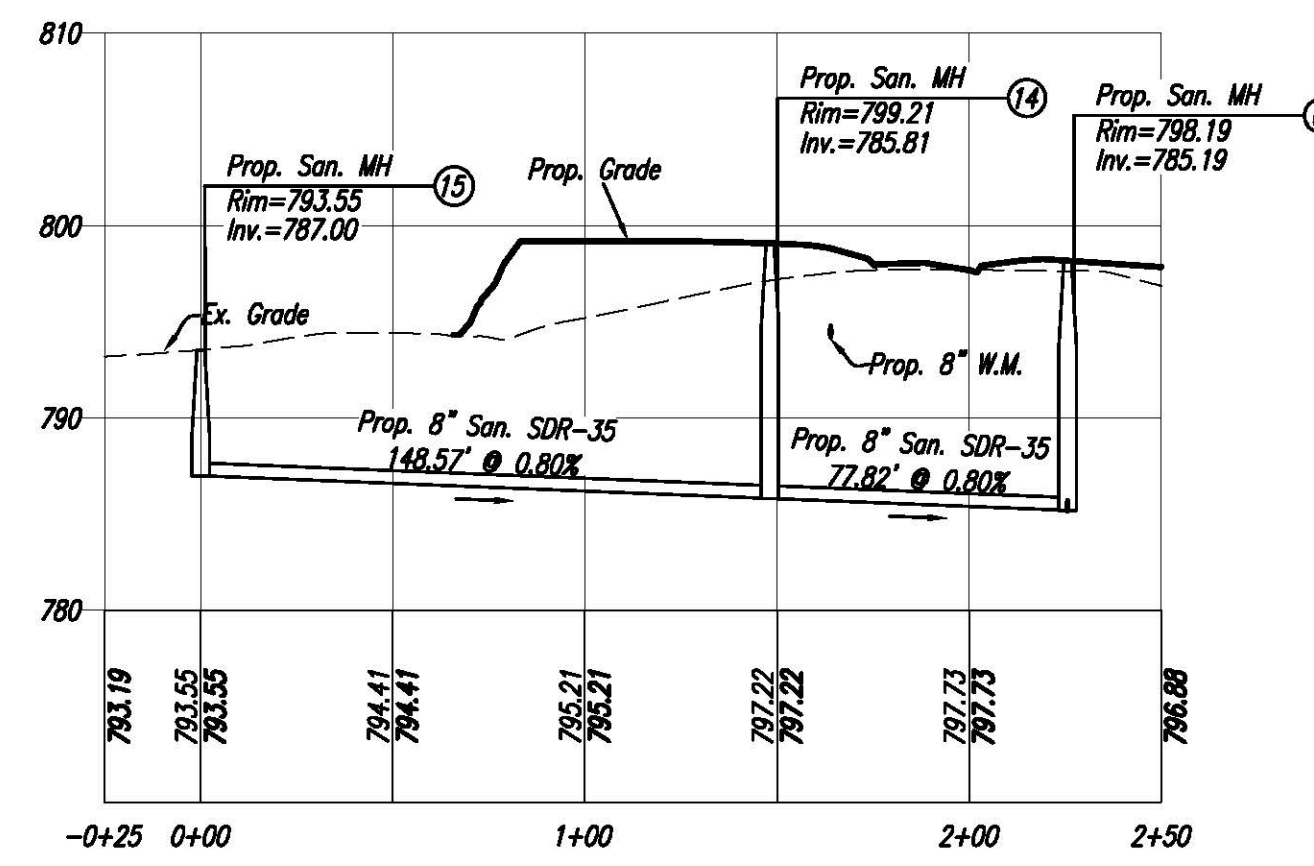


PROP. SAN. MH#15 TO MH#6

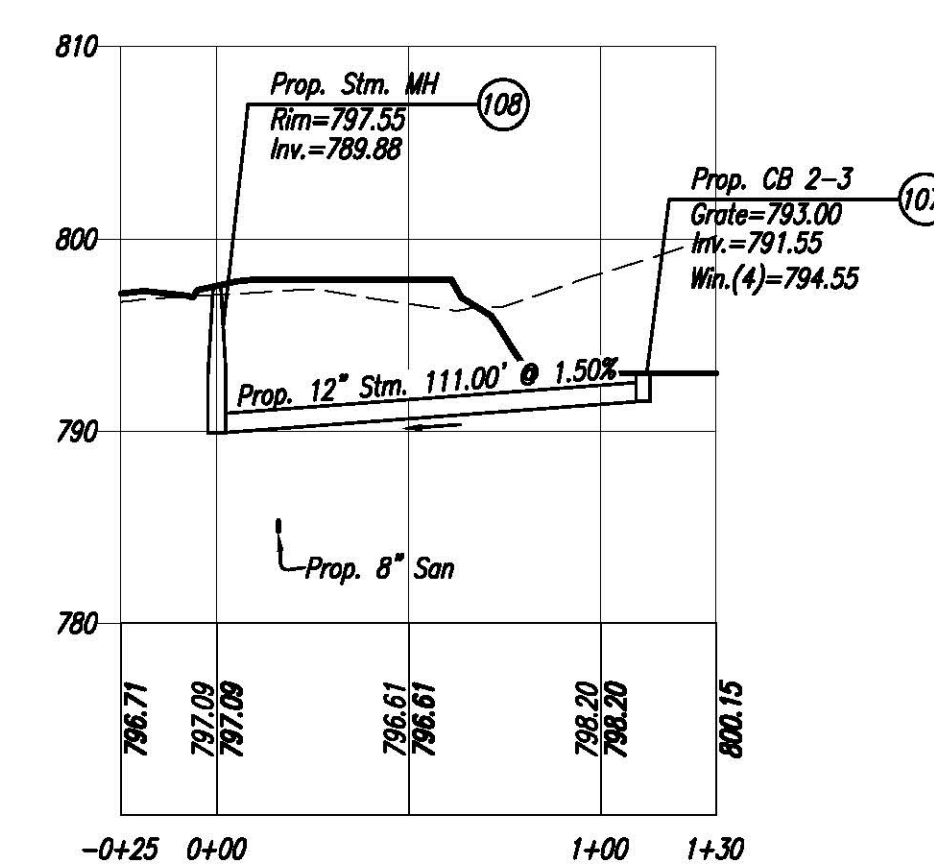


PROP. STM #108 TO #107

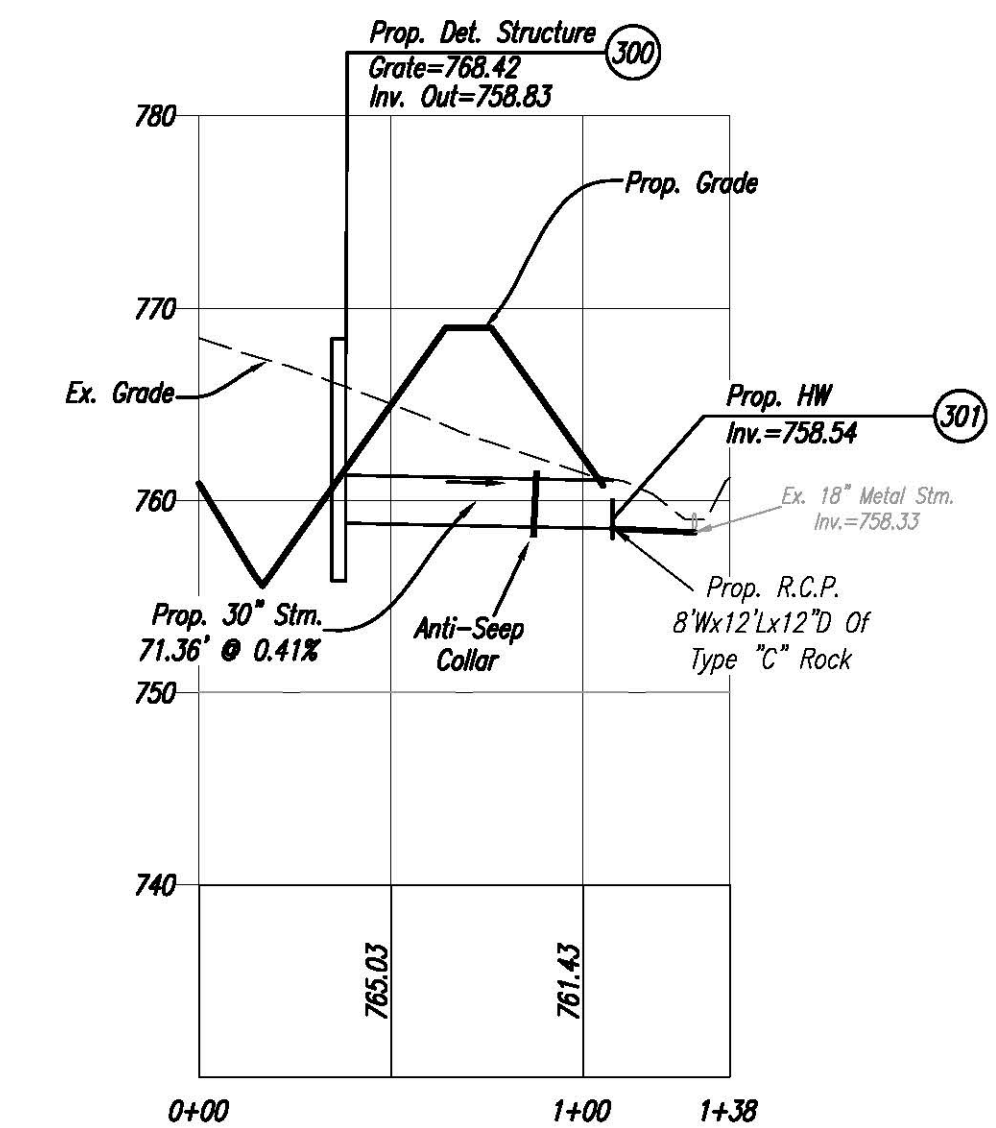



STORM SEWER FROM D.S.#300 TO HW#301

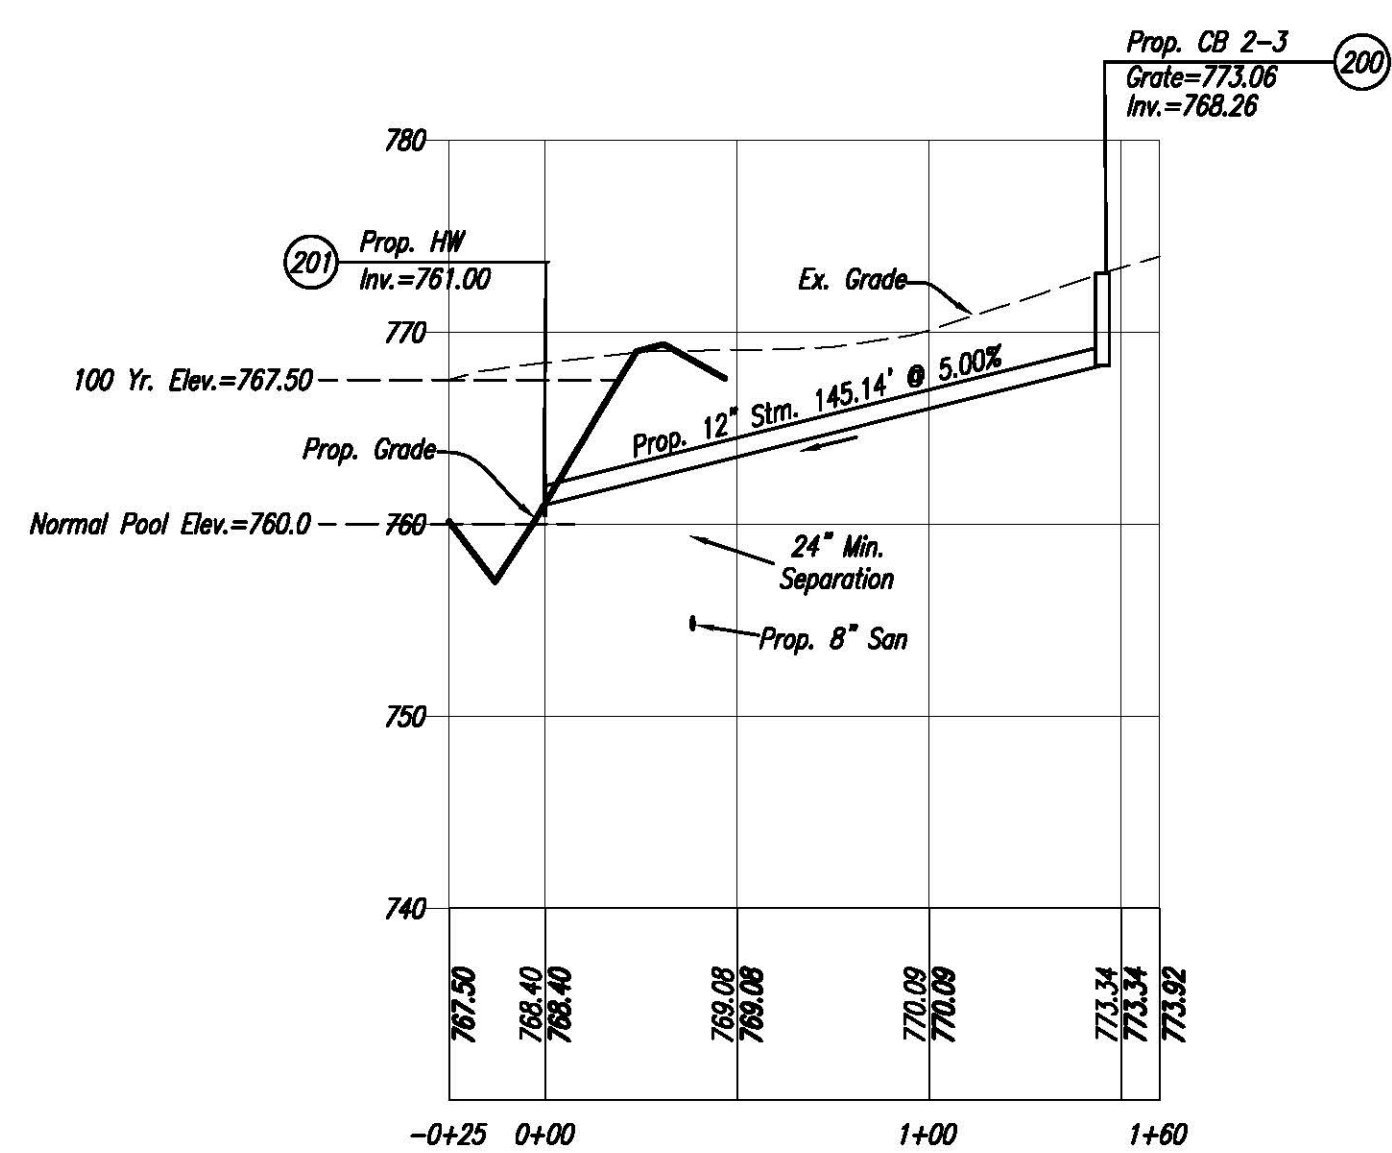

PROP. STM #200 TO #201

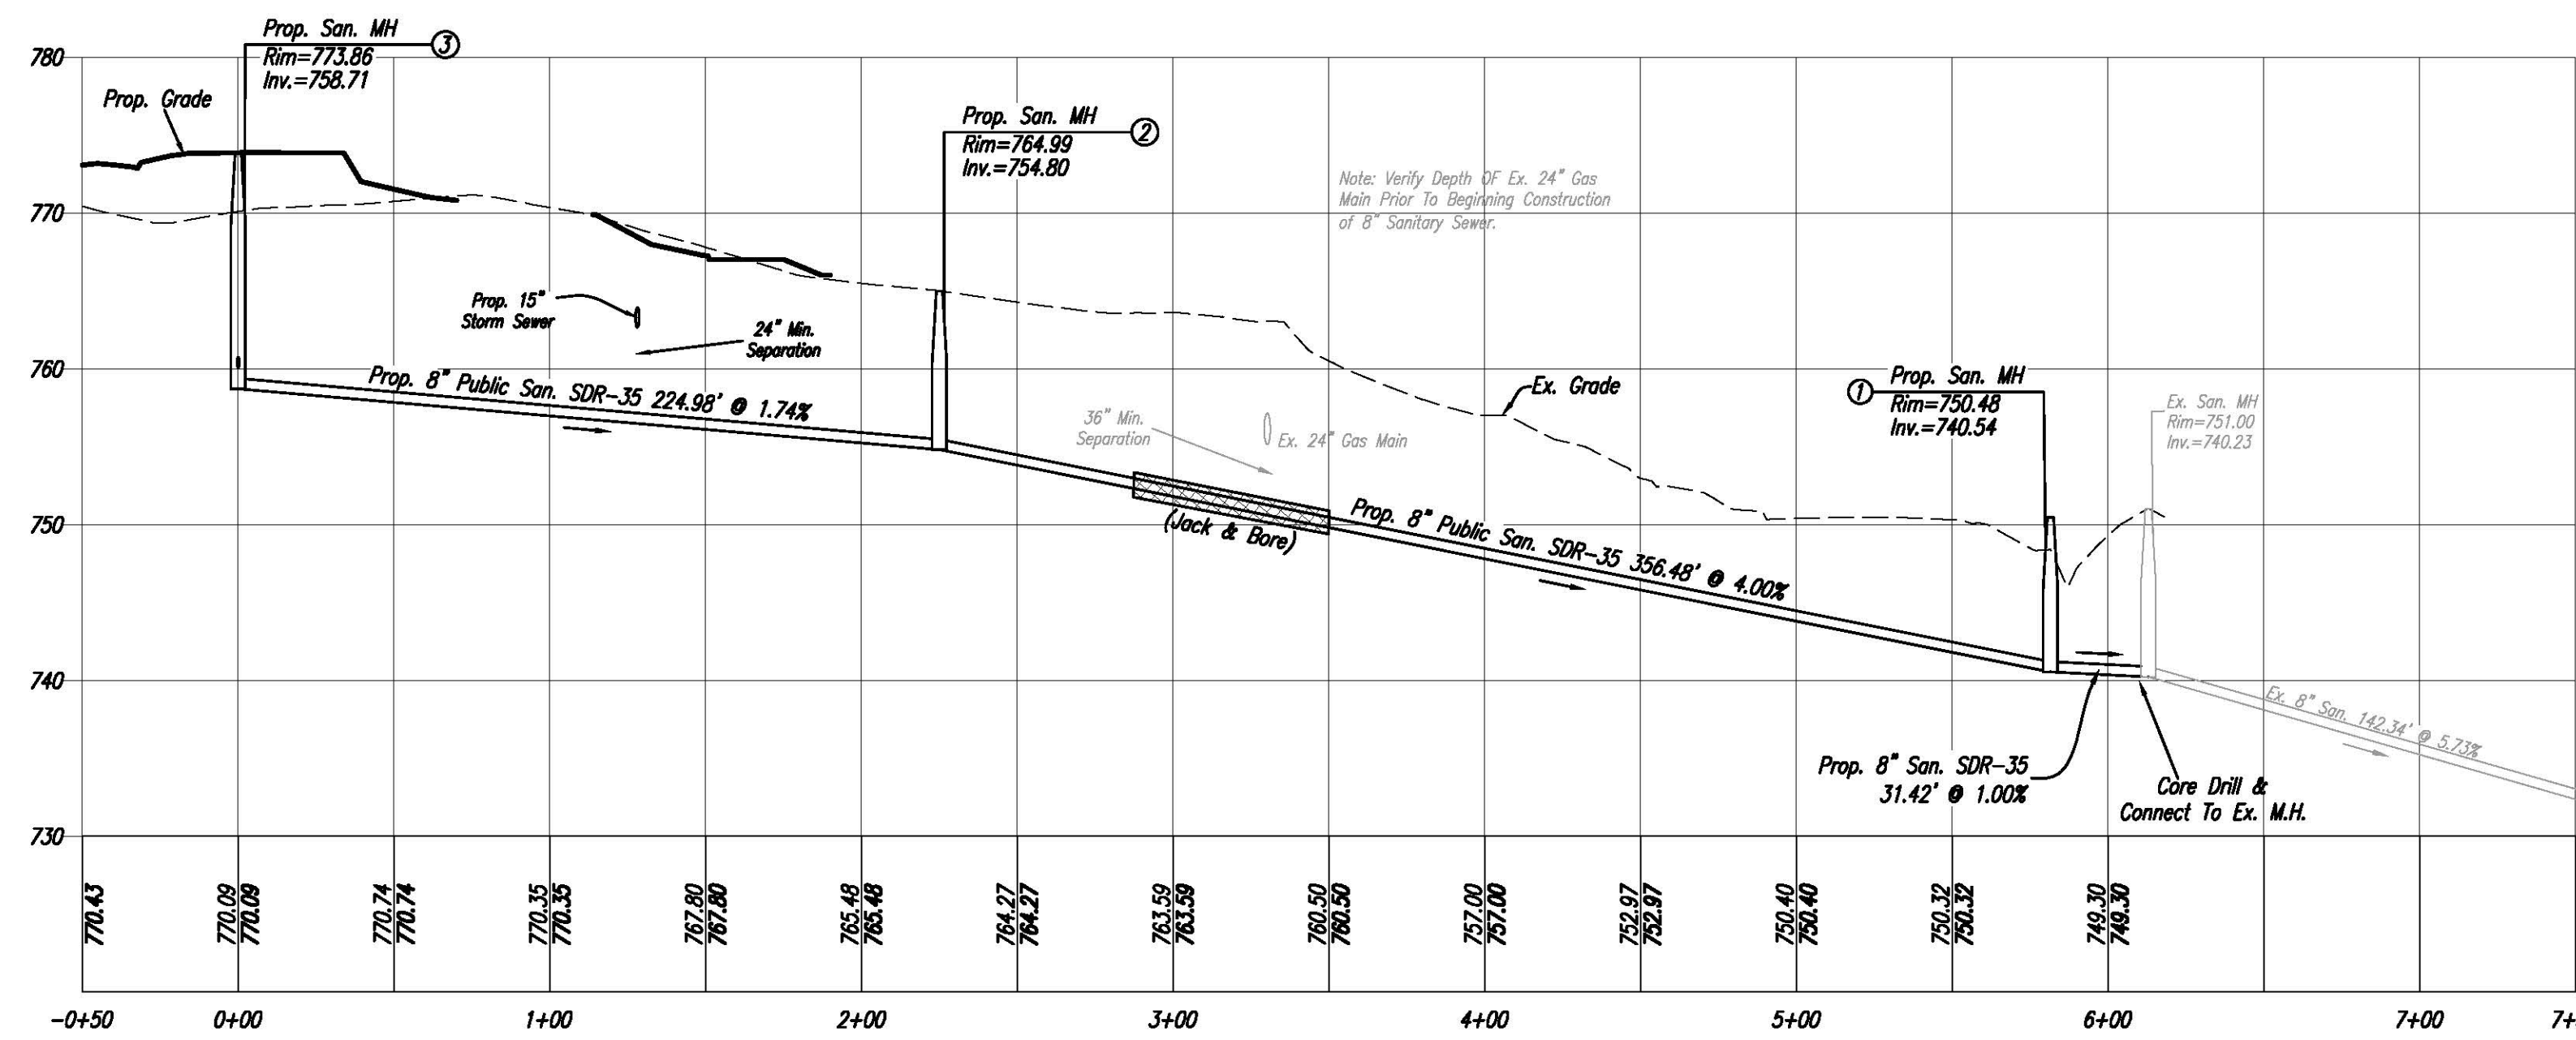

PROP. SAN. MH#3 TO EX. MH

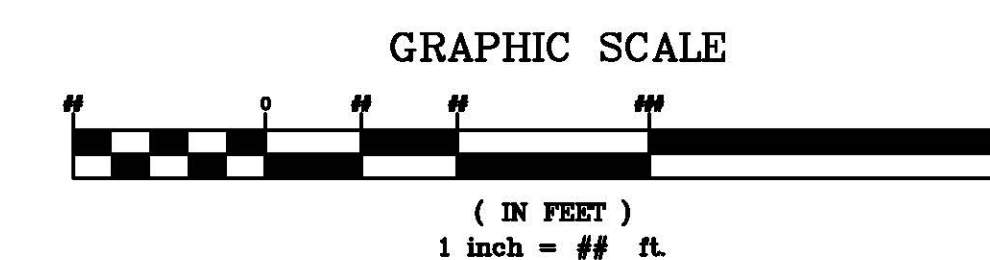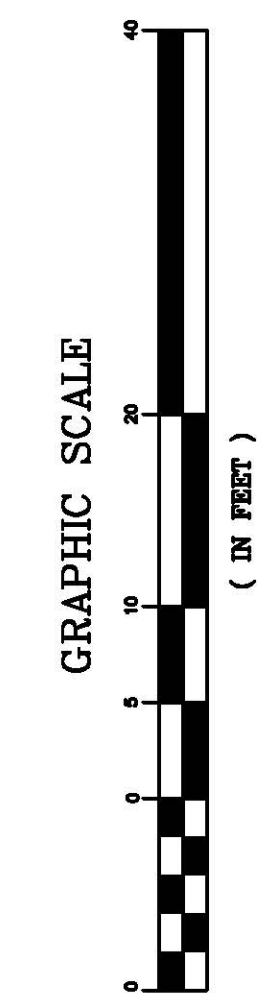

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ARBOR PARK

Date 7-20-18  
 Drawn By D.L.  
 Checked By B.R.  
 Scale AS SHOWN

REVISIONS  
 8-1-18, Meter & Sewer Dimensions  
 8-15-18, B&A Dimensions & Bid Set  
 DWG: 18-001305M(DL-D&A)

PROFILE SHEET  
 ARBOR PARK  
 SECTION-21, TOWN-3, RANGE-3  
 LIBERTY TOWNSHIP  
 BUTLER COUNTY, OHIO

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