

THE OAKS OF WEST CHESTER

SECTION SIX (PHASES 5, 6, & 7)

FINAL DEVELOPMENT PLAN


SECTION 22, TOWN 3, RANGE 2
WEST CHESTER TOWNSHIP
BUTLER COUNTY, OHIO

GENERAL NOTES

- Item numbers refer to the Ohio Department of Transportation construction and material specifications, and all construction work shall be done according to said specifications of Butler County requirements and standards for subdivisions. When in conflict, the County requirements shall prevail.
- Items that pertain to underground utilities such as watermain pipe, sanitary sewer pipe, water valves and manhole frames and covers, etc., will remain under specifications of the utility serving the area. Storm sewers shall be designed and constructed in accordance with the requirements of the Butler County Engineer.
- All trenches within the right-of-way and 10' utility easement shall be compacted and backfilled in accordance with item 204 and 603 (ODOT 2010) in the state specifications.
- Surface course (item 448) and tack coat (item 407) are to be applied no sooner than nine (9) months after the leveling course, (item 448), and fifty (50) percent of the homes are completed. If after two (2) years fifty (50) percent of the homes have not been completed, then the top course may be applied.
- All corner lots shall have driveway access to the lesser traveled road.
- A minimum 10' utility easement shall be shown on the record plat parallel and immediately adjacent to the right-of-way line allowing for installation, operation and maintenance of sewers, water, electric and telephone conduits and any other public or quasi public utility.
- Developer shall be responsible for the installation of conduits for the full width of the public right-of-way at a depth of 36" for use by the electric, telephone and cable services. The location of the lines shall be coordinated with utility companies by the developer.
- All electrical transformers shall be located so that they do not interfere with the existing manholes or water main appurtenances.
- Sump line conduits are to be SDR 35.
- WATER MAIN**
 - Water main materials, valves, fire hydrants, fittings and appurtenances and installation to be as per Butler County specifications, using class 53 Ductile Iron as per AWWA C-151 with minimum 4' cover.
 - All water main valves to have a minimum depth of 2.5' and a maximum depth of 4' from proposed grade to the top of the Valve Operating Nut.
 - Minimum 10' horizontal, 18" vertical separation between water main and sanitary and/or storm sewer.
 - If meter pits cannot be initially installed at the location shown on the typical section, a curb stop can be set up at this location.
- SANITARY SEWER**
 - Sanitary sewer materials and installation to be as per Butler County specifications, using Section 3110 for PVC SDR-35 & 26 pipe, Section 3140 for ABS or PVC composite pipe, Section 3410 for manholes.
 - Crossings Whenever a sanitary sewer and water main must cross, the sewer shall be at such an elevation that the crown of the sewer is at least 18 inches measured between the outside pipe walls, below the bottom of the water main. If it is absolutely impossible to maintain the 18 inch vertical separation, the water main shall be relocated or the sewer shall be constructed as follows:
 - A sewer passing over or under the water main shall be encased or constructed of materials that are equivalent to water main standards of construction for a minimum distance of 10 feet on each side of the water main.
 - The sewer crossing shall be constructed so that the sewer joints will be equidistant and as far as possible from the water main joints.
 - Where a water main passes under a sewer, adequate structural support shall be provided for the sewer to prevent damage to the water main.
 - Sanitary laterals shall be extended to at least ten (10) feet beyond the Property / Right-of-Way or to the edge of the easement, whichever is greater.
 - Sanitary sewer laterals, which shall include all pipe and appurtenances from the building to the public sewer main, and the connection to the public sewer main shall be considered private and the responsibility of the property owner to maintain. The connection to the sewer would be any piping that extends out from the main barrel of the sewer main.
 - All buildings to be served by the public sewer system shall be constructed so as to provide a minimum of four feet (4') of vertical separation between the public sanitary sewer, at the point of connection, and the lowest building level served by a gravity sewer connection and shall not exceed a depth of 12 feet below finish grade at the end of the lateral at the right-of-way unless specifically authorized by the County. In addition, said building level shall be at least one (1) foot above the lowest point of free-overflow (non-sealed manhole cover) upstream of any treatment facility or wastewater pumping facility that receives the discharge from said building. Said minimum service levels shall be recorded on the "As-built" plans for the development which will be kept on file in the office of the Butler County Department of Environmental Services.
- Butler County Water and Sewer Department does not accept any responsibility for the relocation, repair, or replacement of any other utility installed within five (5) feet of the center line of any sanitary sewer main or water main.
- STORM SEWER**
 - Storm sewer pipe shall meet the requirements as follows:
 - PVC pipe as per ODOT Specification 707.42 for all diameters
 - HDPE pipe as per ODOT Specification 707.33
 - Corrugated steel pipe as per ODOT Specification 707.01 or 707.02 for all diameters
 - Reinforced concrete pipe as per ODOT Construction and Material Specification 706.02 for all diameters. Class shall be specified at the contractor's request. (Cincinnati Concrete Pipe, Duracrete or equal).
 - Bituminous coated corrugated steel pipe as per ODOT Specification 707.05 or 707.07. Installation shall meet Butler County Specifications. All joints shall be soil seal joints unless specifically noted on the plans.
 - Deflection Testing for Storm Sewers and Culverts 15% of all storm sewers shall be tested for deflection within thirty days after they are completed. Butler County Engineer or his designated representative will determine what 15% shall be tested. If any storm sewer in the original 15% found out of compliance with deflection, will be required on 100% of the remaining storm sewers. A vertical rise deflection greater than 5% will not be allowed. This deflection is defined as 5% reduction in the vertical base or average inside diameter. The method of testing shall be subject to the approval of the engineer. If grid balls or mandrels are used to test pipe deflection, no mechanical pulling devices shall be used. The deflection test may be conducted with a nine prong mandrel, a ball or a cylinder or another manner acceptable to the Butler County Engineer or his designated representative. The testing will be accomplished from manhole to manhole or catchbasin to catchbasin, following the complete flushing of the line. The contractor shall furnish all equipment required to complete the deflection testing. The deflection test shall be witnessed by the County Engineer or his designated representative. Any section of pipe that fails to meet the aforementioned requirements shall be rerounded by a procedure acceptable to the County or be excavated and either be relayed or replaced, and retested until the requirements are met.
 - All catch basins and manholes with a depth greater than 4' shall be provided with steps. Steps shall meet the requirements of ODOT STD. 804 and shall conform to the details as shown on Butler County Standard Drawing MH-1A.
 - Headwall: HW-4A to be used with Corrugated Metal pipe or HW-4B to be used with Concrete Pipe.
- Roof drains, foundation drains, and other clean water connections to the sanitary sewer system are prohibited.
- Any detention basin on site should be constructed prior to the clearing of topsoil and grading of the site. All trees and vegetation shall be removed from all proposed detention basins regardless of maintenance responsibility.
- SEDIMENTATION CONTROL**
 - The project has been designed to control erosion and prevent damage to other property. All stripping, earthwork, and grading shall be performed to minimize erosion. Natural vegetation shall be retained wherever possible. The proposed plan will allow almost all eroded material to be retained on site.
 - All areas disturbed by the construction of the roadways, ditches and sediment basins shall be seeded and strawed as soon as possible to limit the erosion and stabilize the soil. Payment will be by the number of square yards disturbed as per the grading plan. For additional sedimentation control details, see grading plan.
- Butler County will not be responsible for any pavement or storm sewer repairs resulting from water main and sanitary sewer repairs. Butler County also will not be responsible for adjusting manholes, valves, fire hydrants, meter pits, etc. as a result of grade changes. The grantor shall be responsible for proper adjustment of manholes, valves, fire hydrants, meter pits, etc. to the satisfaction of Butler County, due to grade changes, paving, repairing, etc. initiated by the grantor.
- A typical five (5) foot drainage easement is to be provided on both sides of every lot line.
- Any roadway settlement greater than one inch will be required to be repaired with Item 613 Low Strength Mortar Backfill (Type 1). See Detail on Sheet C8.0.
- Provide the Butler County Engineer's Office with a forty-eight (48) hour notice prior to the start of any construction, including sanitary installation. Phone 765-4145.
- Contractors to accept all Quantities as correct prior to beginning construction.
- Contractor shall include the cost of County inspection and extension fees in unit price bid.
- Private driveways, parking lots and other paved areas, earthen berms or structures should not be constructed over private water or sewer service lines within the public road right of way or within the easement areas for the public utilities. Should this occur, the property owner shall be held responsible for the protection and repair and for providing access to any curb stops, meter pits, manholes, clean-outs, etc. installed in conjunction with these private service lines and for any damage or restoration of the paved surfaces or structures that may result from the future operation, maintenance, repair or replacement of said service lines and appurtenances.



EJP 08-26-2020

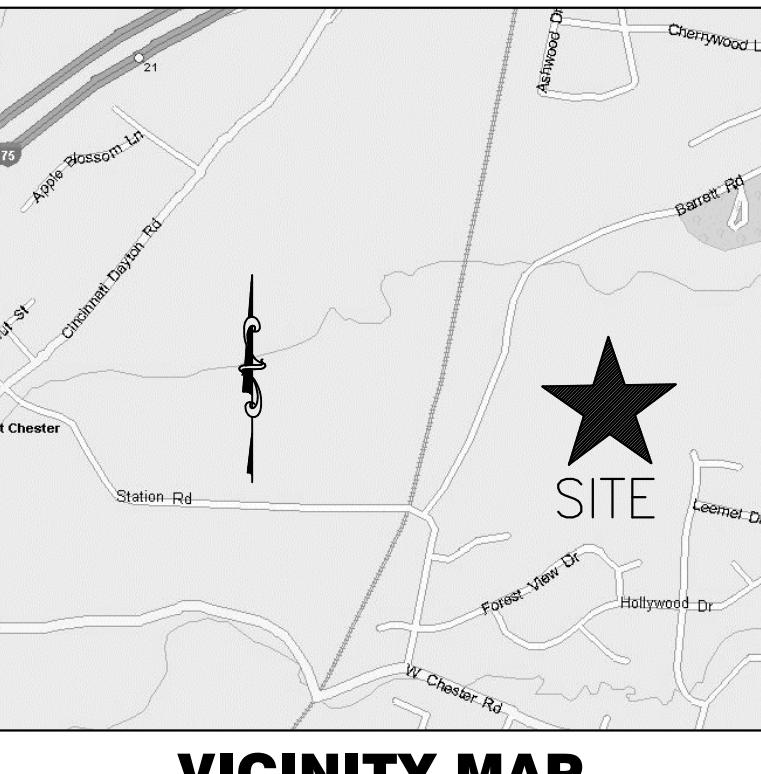

VICINITY MAP
NOT TO SCALE

SECTION SIX SUMMARY

EXISTING ZONING	R-PUD (7/18/2008)
TYPICAL LOT FRONTRAGE	100 FT
SQUARE FOOTAGE (MIN)	15,000 SF
FRONT SETBACK (MIN)	30 FT
SIDE SETBACK (MIN)	5 FT
SIDE SETBACK (TOTAL)	30 FT (20 FT MIN REQUIRED BTW HOUSES)
REAR SETBACK	30 FT
NUMBER OF LOTS	43 LOTS
OPEN SPACE LOTS	2 LOTS
TOTAL	45 LOTS
TOTAL ACREAGE	36.785 ACRES
TOTAL OPEN SPACE	10.320 ACRES
% OF OPEN SPACE	28.05%

PLANNER, ENGINEER, SURVEYOR, AND LANDSCAPE ARCHITECT

BAYER BECKER
6900 TYLERVILLE ROAD, SUITE A
MASON, OH 45040
PH: 513-336-6600

DEVELOPER

RHEIN GUNDLER LLC
11025 REED HARTMAN HIGHWAY, SUITE B-1
CINCINNATI, OH 45242
PH: 513-891-7100

OWNERS

ERROL & NANCY GUNDLER
6466 CONTRERRAS ROAD,
OXFORD, OH 45056

LAWRENCE & ESTELLA GUNDLER
6745 BARRETT ROAD
WEST CHESTER, OH 45071

BENCHMARK

ON PIN SET - CAPPED BB TRAVERSE LOCATED 12.00'
WEST OF FIRE HYDRANT AT THE SOUTHWEST
INTERSECTION OF BARRET ROAD & SPRUCE HILL CIRCLE
ELEVATION = 768.52
ELEVATION BASED ON STATE PLANE COORDINATE
SYSTEM (NAD 83) OHIO SOUTH ZONE 3402

INDEX OF SHEETS

DRAWING NO.	DRAWING TITLE	ISSUE DATE	REVISION NO.	REVISION DATE
C1.0	TITLE SHEET	06-15-20	3	08-05-20
C1.1	TYPICAL SECTIONS & MISC. DETAILS	06-15-20	1	08-05-20
C2.0	LAYOUT PLAN	06-15-20	3	08-05-20
C3.0	UTILITY PLAN	06-15-20	2	08-05-20
C3.1	UTILITY PLAN NORTH BASIN	06-15-20	2	08-05-20
C4.0	UTILITY PROFILES	06-15-20	1	08-05-20
C4.1	UTILITY PROFILES	06-15-20	1	08-05-20
C4.2	UTILITY PROFILES	06-15-20	2	08-05-20
C4.3	UTILITY PROFILES & INTERSECTION DETAILS	06-15-20	1	08-05-20
C5.0	GRADING AND EROSION CONTROL PLAN	06-15-20	2	08-05-20
C5.1	BASIN GRADING AND EROSION CONTROL PLAN	06-15-20	2	08-05-20
C5.2	SOIL AND EROSION CONTROL DETAILS	06-15-20		
C6.0	SIGHT DISTANCE EXHIBIT	06-15-20	2	08-05-20
C7.0	BUTLER COUNTY SANITARY DETAILS	06-15-20		
C7.1	BUTLER COUNTY WATER DETAILS	06-15-20	1	08-05-20
C7.2	BUTLER COUNTY STORM DETAILS	06-15-20		



Know what's below.
Call before you dig.

LOCATION OF ALL EXISTING UTILITIES TO BE
DETERMINED IN THE FIELD PRIOR TO CONSTRUCTION


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Item	Revision Description	Date	Drawn: Chk:	
1	REVISED PER ZONING COMMENTS	07-05-20	DTM JSD	
2	REVISED PER ZONING COMMENTS	07-15-20	JSD	
3	BUTLER COUNTY COMMENTS	08-05-20	DFD	
4				
5				

STATE OF OHIO
JOHN S. DELVERNE
REGISTERED PROFESSIONAL ENGINEER
E-59378
8/5/20
Signature

bayer becker
www.bayerbecker.com
6900 Tylerville Road, Suite A
Mason, OH 45040 - 513-336-6600

Drawing: 06F158-006 CD
Drawn by: LDF
Checked By: JSD
Issue Date: 06-15-20
Sheet: C1.0

Plot time: Aug 05, 2020 - 9:24am
Drawing name: I:\20006\06E158-00

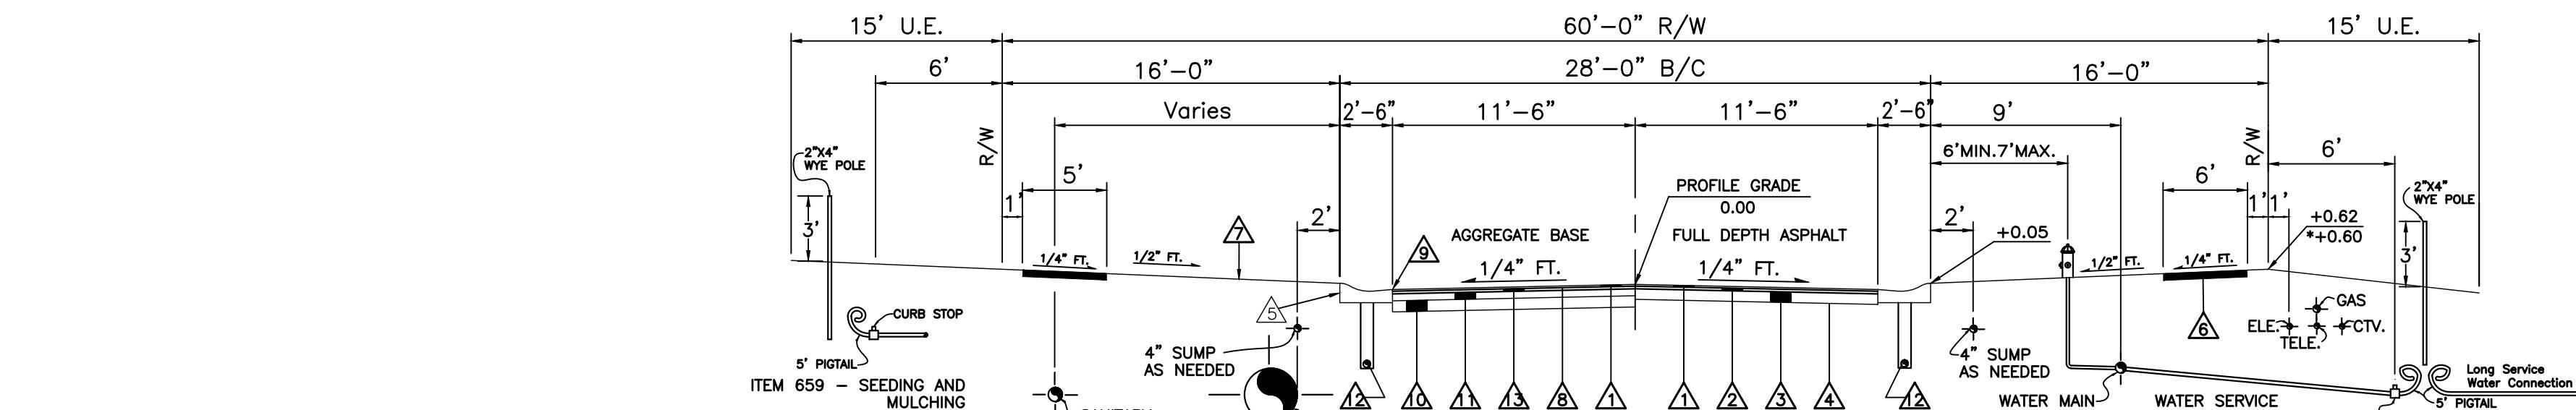

ITEM	DEPTH TOP OF PIPE	
Underdrain	18"	
Sumplines	24" - 30"	
Gas	24" - 30"	
Water	48" - 54"	
Electric	36" - 40"	
Telephone	36" - 40"	
Cable TV	36" - 40"	

*SURFACE COURSE (ITEM 448) AND TACK COAT (ITEM 407) ARE TO BE APPLIED NO SOONER THAN TWELVE (12) MONTHS AFTER THE LEVELING COURSE (ITEM 448), AND FIFTY (50) PERCENT OF THE HOMES ARE COMPLETED. IF AFTER TWO (2) YEARS FIFTY (50) PERCENT OF THE HOMES HAVE NOT BEEN COMPLETED, THEN THE TOP COURSE MAY BE APPLIED.

C-1) **XCEPT
2"**


- 8** TACK COAT - ITEM 407 - TO BE APPLIED AT A RATE OF 0.05 GAL. PER SQUARE YARD, SEE * NOTE
- 9** TACK COAT - ITEM 407 - TO BE APPLIED TO FRONT FACE OF CURB PRIOR TO INSTALLATION OF 301 BITUMINOUS AGGREGATE BASE. ALSO TO BE APPLIED TO CURB JOINT AFTER THE INSTALLATION OF 448 LEVELING COURSE.
- 10** 6" BASE COURSE - ITEM 304 AGGREGATE BASE
- 11** 5" BASE COURSE - ITEM 301 BITUMINOUS AGGREGATE BASE
- 12** 4" UNDERDRAIN - ITEM 605. CONNECT UNDERDRAIN TO CENTERLINE OF CURB AND GUTTER. CONNECT TO SIDEWALL OF NEAREST CATCH BASIN
- 13** 1 1/2" LEVELING COURSE - ITEM 448 ASPHALTIC CONCRETE

TYPICAL STREET SECTION

SUSAN SPRINGS DRIVE & OAKCREST WAY (STA. 16+42.09 TO STA. 17+68.68)

NOT TO SCALE


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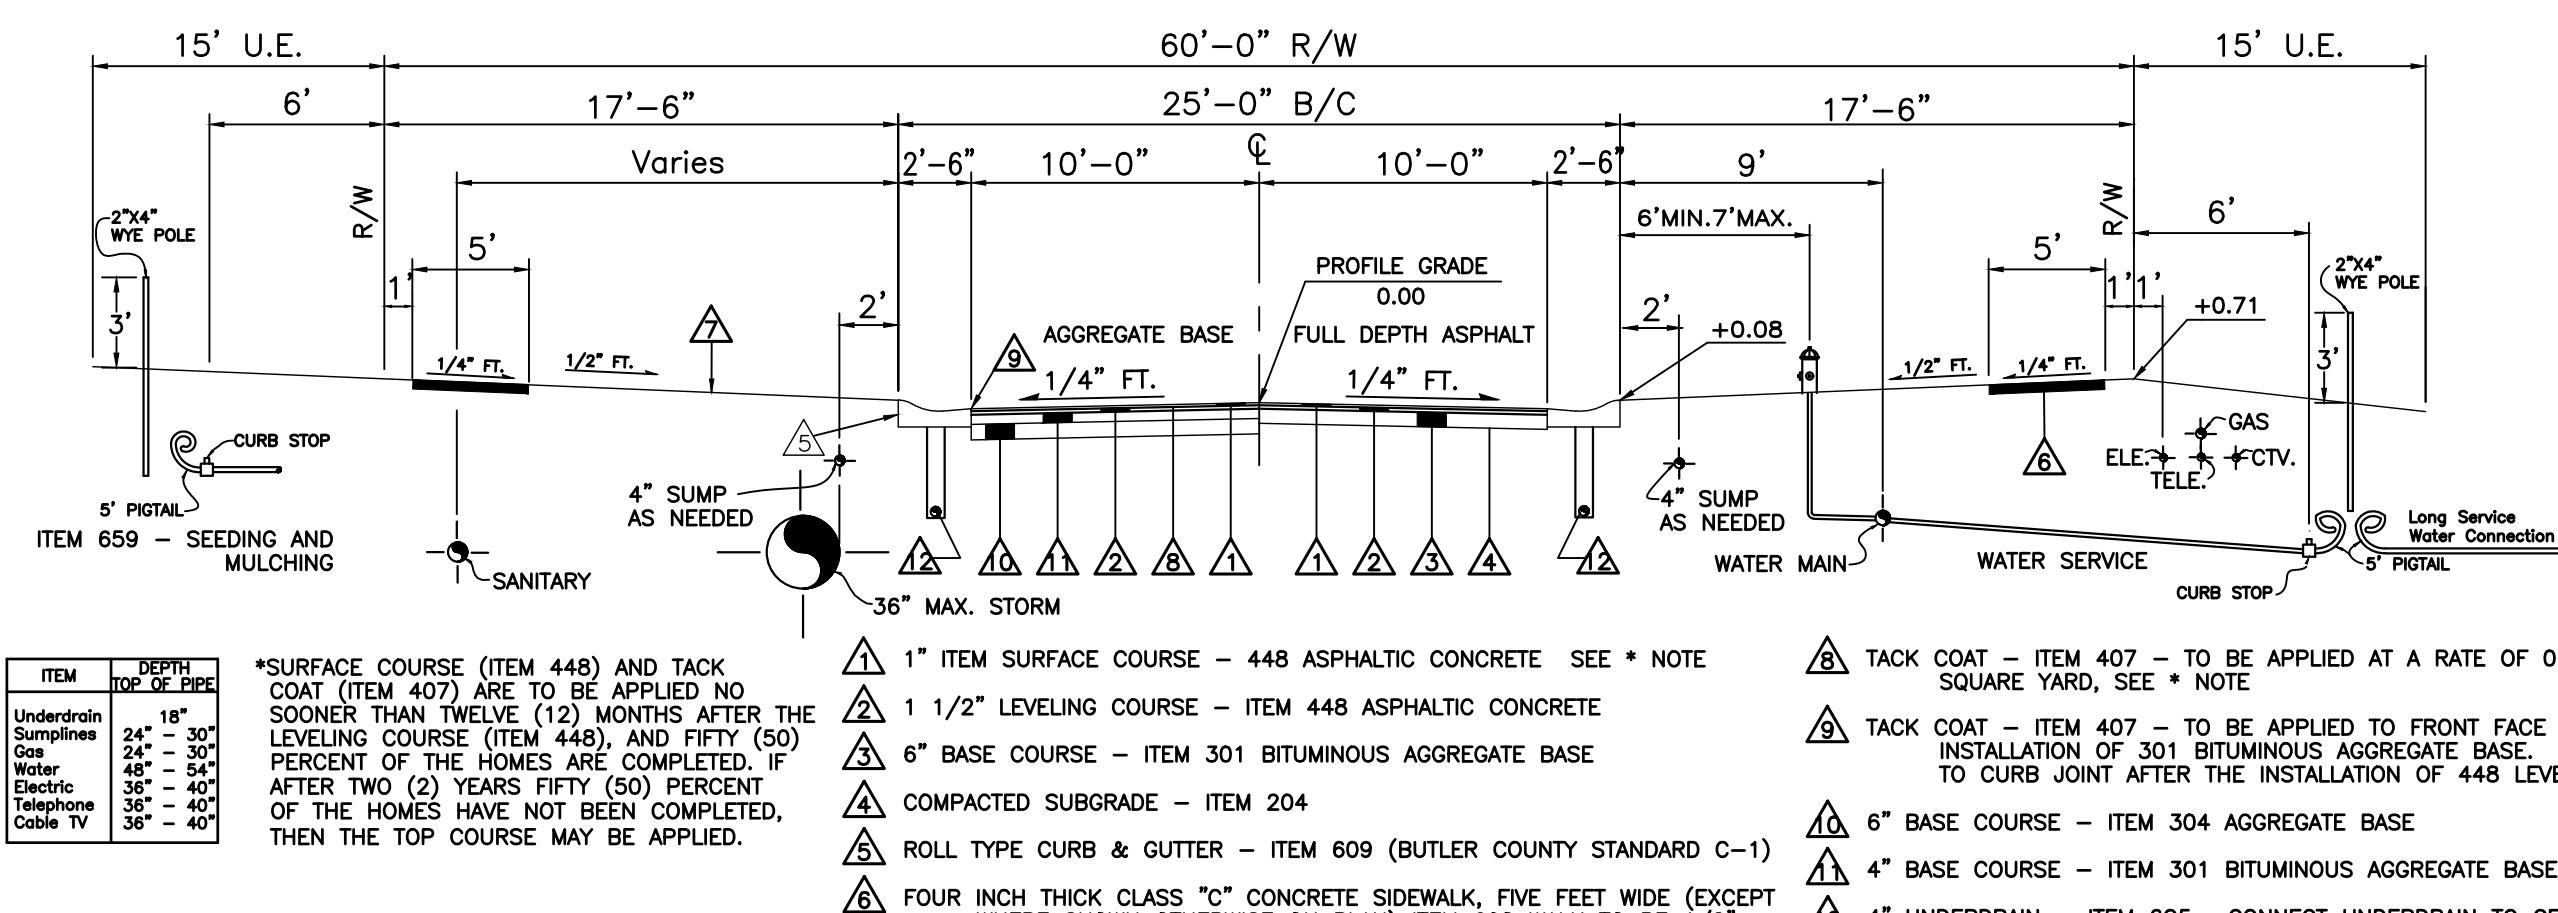
R1-1 STOP SIGN

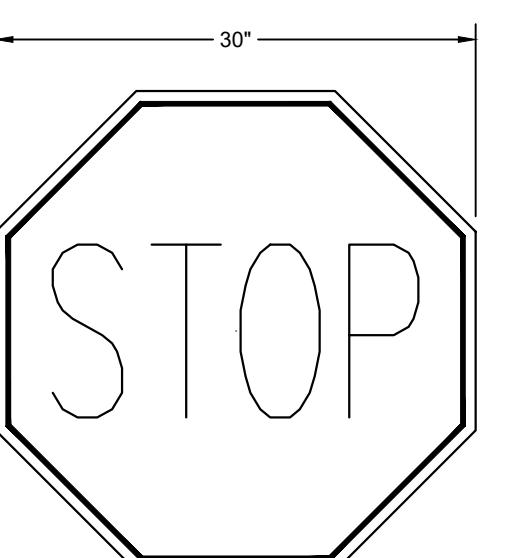NOT TO SCALE

*NOTE: ALL SIGNS TO BE INSTALLED WITH GROUND MOUNTED SUPPORT NO. 3 POST



STANDARD DROP CURB AT DRIVEWAYS BUTLER COUNTY STANDARD C-1

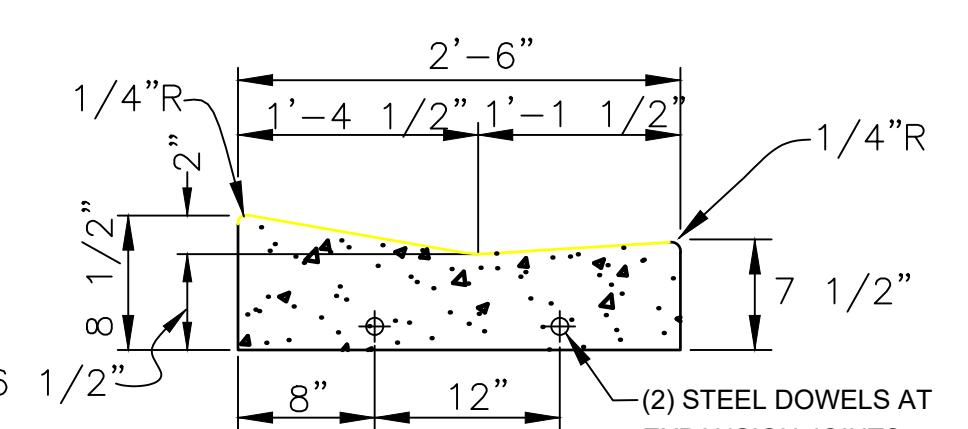


ITEM	DEPTH TOP OF PIPE	*SURFACE COURSE (ITEM 448) AND TACK COAT (ITEM 407) ARE TO BE APPLIED NO SOONER THAN TWELVE (12) MONTHS AFTER THE LEVELING COURSE (ITEM 448), AND FIFTY (50) PERCENT OF THE HOMES ARE COMPLETED. IF AFTER TWO (2) YEARS FIFTY (50) PERCENT OF THE HOMES HAVE NOT BEEN COMPLETED,	1" ITEM SURFACE COURSE - 448 ASPHALTIC CONCRETE 1 1/2" LEVELING COURSE - ITEM 448 ASPHALTIC CONCRETE 6" BASE COURSE - ITEM 301 BITUMINOUS AGGREGATE COMPACTED SUBGRADE - ITEM 204
Underdrain	18"		
Sumplines	24" - 30"		
Gas	24" - 30"		
Water	48" - 54"		
Electric	36" - 40"		
Telephone	36" - 40"		
Cable, Pvc	30" - 40"		

C-1)
KCEPT
2"


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- 11 4" BASE COURSE - ITEM 301 BITUMINOUS AGGREGATE BASE
- 12 4" UNDERDRAIN - ITEM 605. CONNECT UNDERDRAIN TO CENTERLINE OF CURB

TYPICAL STREET SECTION

NOT TO SCALE
***ADD "NO PARKING" SIGNS ON:**
OAKCREST WAY (NORTH OF SUSAN SPRINGS DRIVE): WEST SIDE

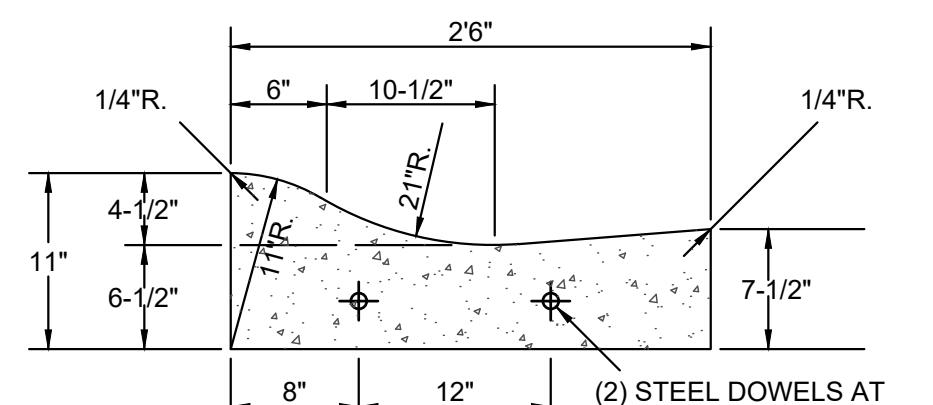

TYPICAL ROLL-TYPE CURB BUTLER COUNTY STANDARD C-1

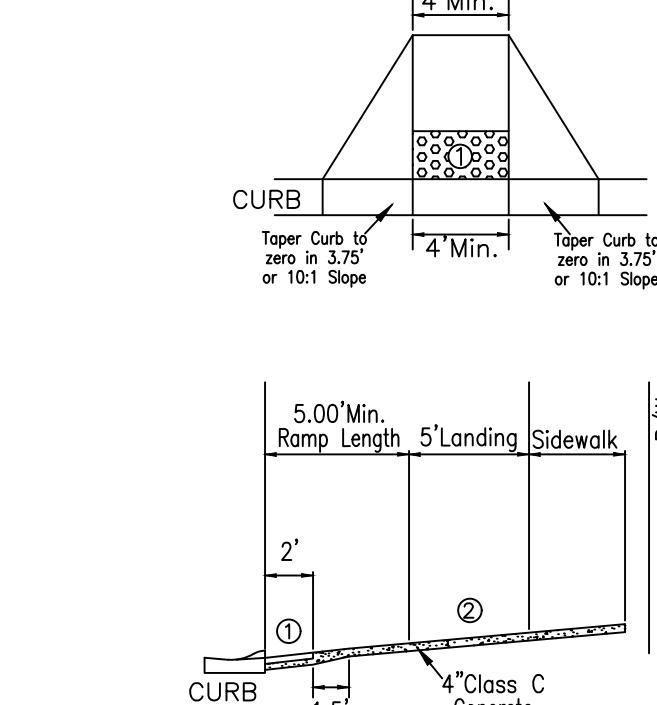


- ① Detectable Warning (Truncated Domes) are to be installed in the location shown. Dimensions of the domes are 24" from the back of the curb by the width of the ramp.
- ② Minimum Landing is to be 4' but 5' is preferred. The slope of the ramp is preferred to be 12:1 or flatter related to the horizontal, but the minimum slope shall be 12:1 relative to the existing or proposed walk slope.
- ③ Curb ramps shall be design A or design B per ODOT Drawing 7-12-02, sheets 1 thru 3. Truncated domes are to meet the

CURB RAMP DETAIL

NOT TO SCALE

NOT TO SCALE

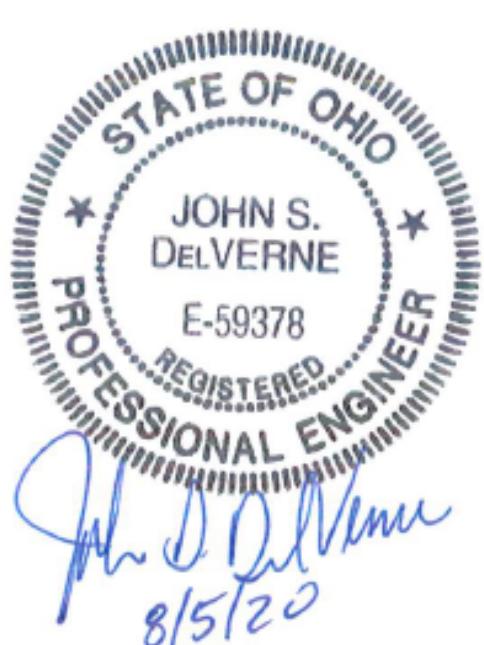

**THE OAKS OF WEST CHESTER
SECTION SIX (PHASES 5, 6, & 7)**


**SECTION 22, TOWN 3, RANGE 2
WEST CHESTER TOWNSHIP,
BUTLER COUNTY, OHIO**

bayer
becker

www.bayerbecker.com
6900 Tylersville Road, Suite A
Mason, OH 45040 - 513.336.6600

Plot time: Aug 05, 2020 - 9:26am
Drawing name: J:\2006\06F158-006\CV\DWG\06F158-006 CD.dwg - Layout Tab: C2.0 LAYOUT PLAN

LEGEND

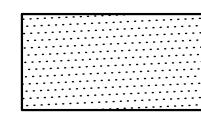

ASPHALT PAVEMENT FOR 24' PRIVATE DRIVE
(PAVEMENT TO MATCH ROADWAY TYPICAL SECTION
MATERIALS & THICKNESS, SEE SHEET C1.1)

RESTRICTIONS ON CONSERVATION/PRESERVATION EASEMENT:

THE CONSERVATION EASEMENT SHOWN ON LOTS 53 & 54 HAVE BEEN ESTABLISHED TO PRESERVE EXISTING TREES. NO LIVING AND HEALTHY DECIDUOUS OR EVERGREEN TREE LOCATED WITHIN THIS EASEMENT GREATER THAN 3" IN DIAMETER SHALL BE REMOVED WITHOUT THE APPROVAL FROM WEST CHESTER TOWNSHIP, OHIO AND THE OAKS OF WEST CHESTER HOMEOWNERS ASSOCIATION. THE OWNER OF LOTS 107-111 ("OWNERS") MAY CUT AND REMOVE ANY DEAD STANDING TREES, FALLEN TREES, DISEASED TREES AND UNDERGROWTH WITHIN THE EASEMENT. THE OWNERS SHALL NOT CONDUCT OR PERMIT TO BE CONDUCTED ANY TYPE OF ACTIVITY WITHIN THE EASEMENT WHICH WILL CAUSE THE EXISTING TREES TO BE HARMED OR KILLED, INCLUDING BUT NOT LIMITED TO MASS FILLING OR REMOVAL OF SOIL OR THE SPRAYING OF DANGEROUS HERBICIDES. THE OWNER MAY SUPPLEMENT THE EXISTING PLANTS IN THE EASEMENT WITH ADDITIONAL TREES OR VEGETATION OF A SPECIES NATIVE TO WEST CHESTER TOWNSHIP, OHIO AREA.


The stamp is circular with a decorative outer border. The words "STATE OF OHIO" are at the top, "JOHN S. DELVERNE" are in the center, and "E-59378" is below that. The bottom arc contains "REGISTERED" and "PROFESSIONAL ENGINEER". The inner circle has two stars at the top and bottom. A blue signature "John S. DelVerne" is written across the bottom left, and the date "8/5/20" is written in blue at the bottom right.

GENERAL NOTES

1. ALL WORK SHALL BE PERFORMED IN ACCORDANCE WITH THE LATEST EDITION OF THE OHIO DEPARTMENT OF TRANSPORTATION (ODOT) "CONSTRUCTION AND MATERIAL SPECIFICATIONS," AND PROJECT SPECIFICATIONS. IN THE EVENT OF A CONFLICT, THE MORE STRINGENT STANDARD APPLIES.
 2. WHERE CONNECTING TO EXISTING ASPHALT PAVEMENT, THE CONTRACTOR SHALL SAW CUT THE EXISTING EDGE OF PAVEMENT TO PROVIDE A CLEAN EDGE. ITEM 407 TACK COAT SHALL BE APPLIED TO THE ENTIRE CUT FACE OF THE EXISTING PAVEMENT PRIOR TO THE PLACEMENT OF THE PROPOSED PAVEMENT.
 3. TWO (2) AUTUMN BLAZE MAPLE TREES TO BE PLANTED ON EACH LOT BY BUILDER, MINIMUM 2 $\frac{1}{2}$ " CALIPER.

**Know what's below.
Call before you dig.**

LOCATION OF ALL EXISTING UTILITIES TO BE DETERMINED IN THE FIELD PRIOR TO CONSTRUCTION

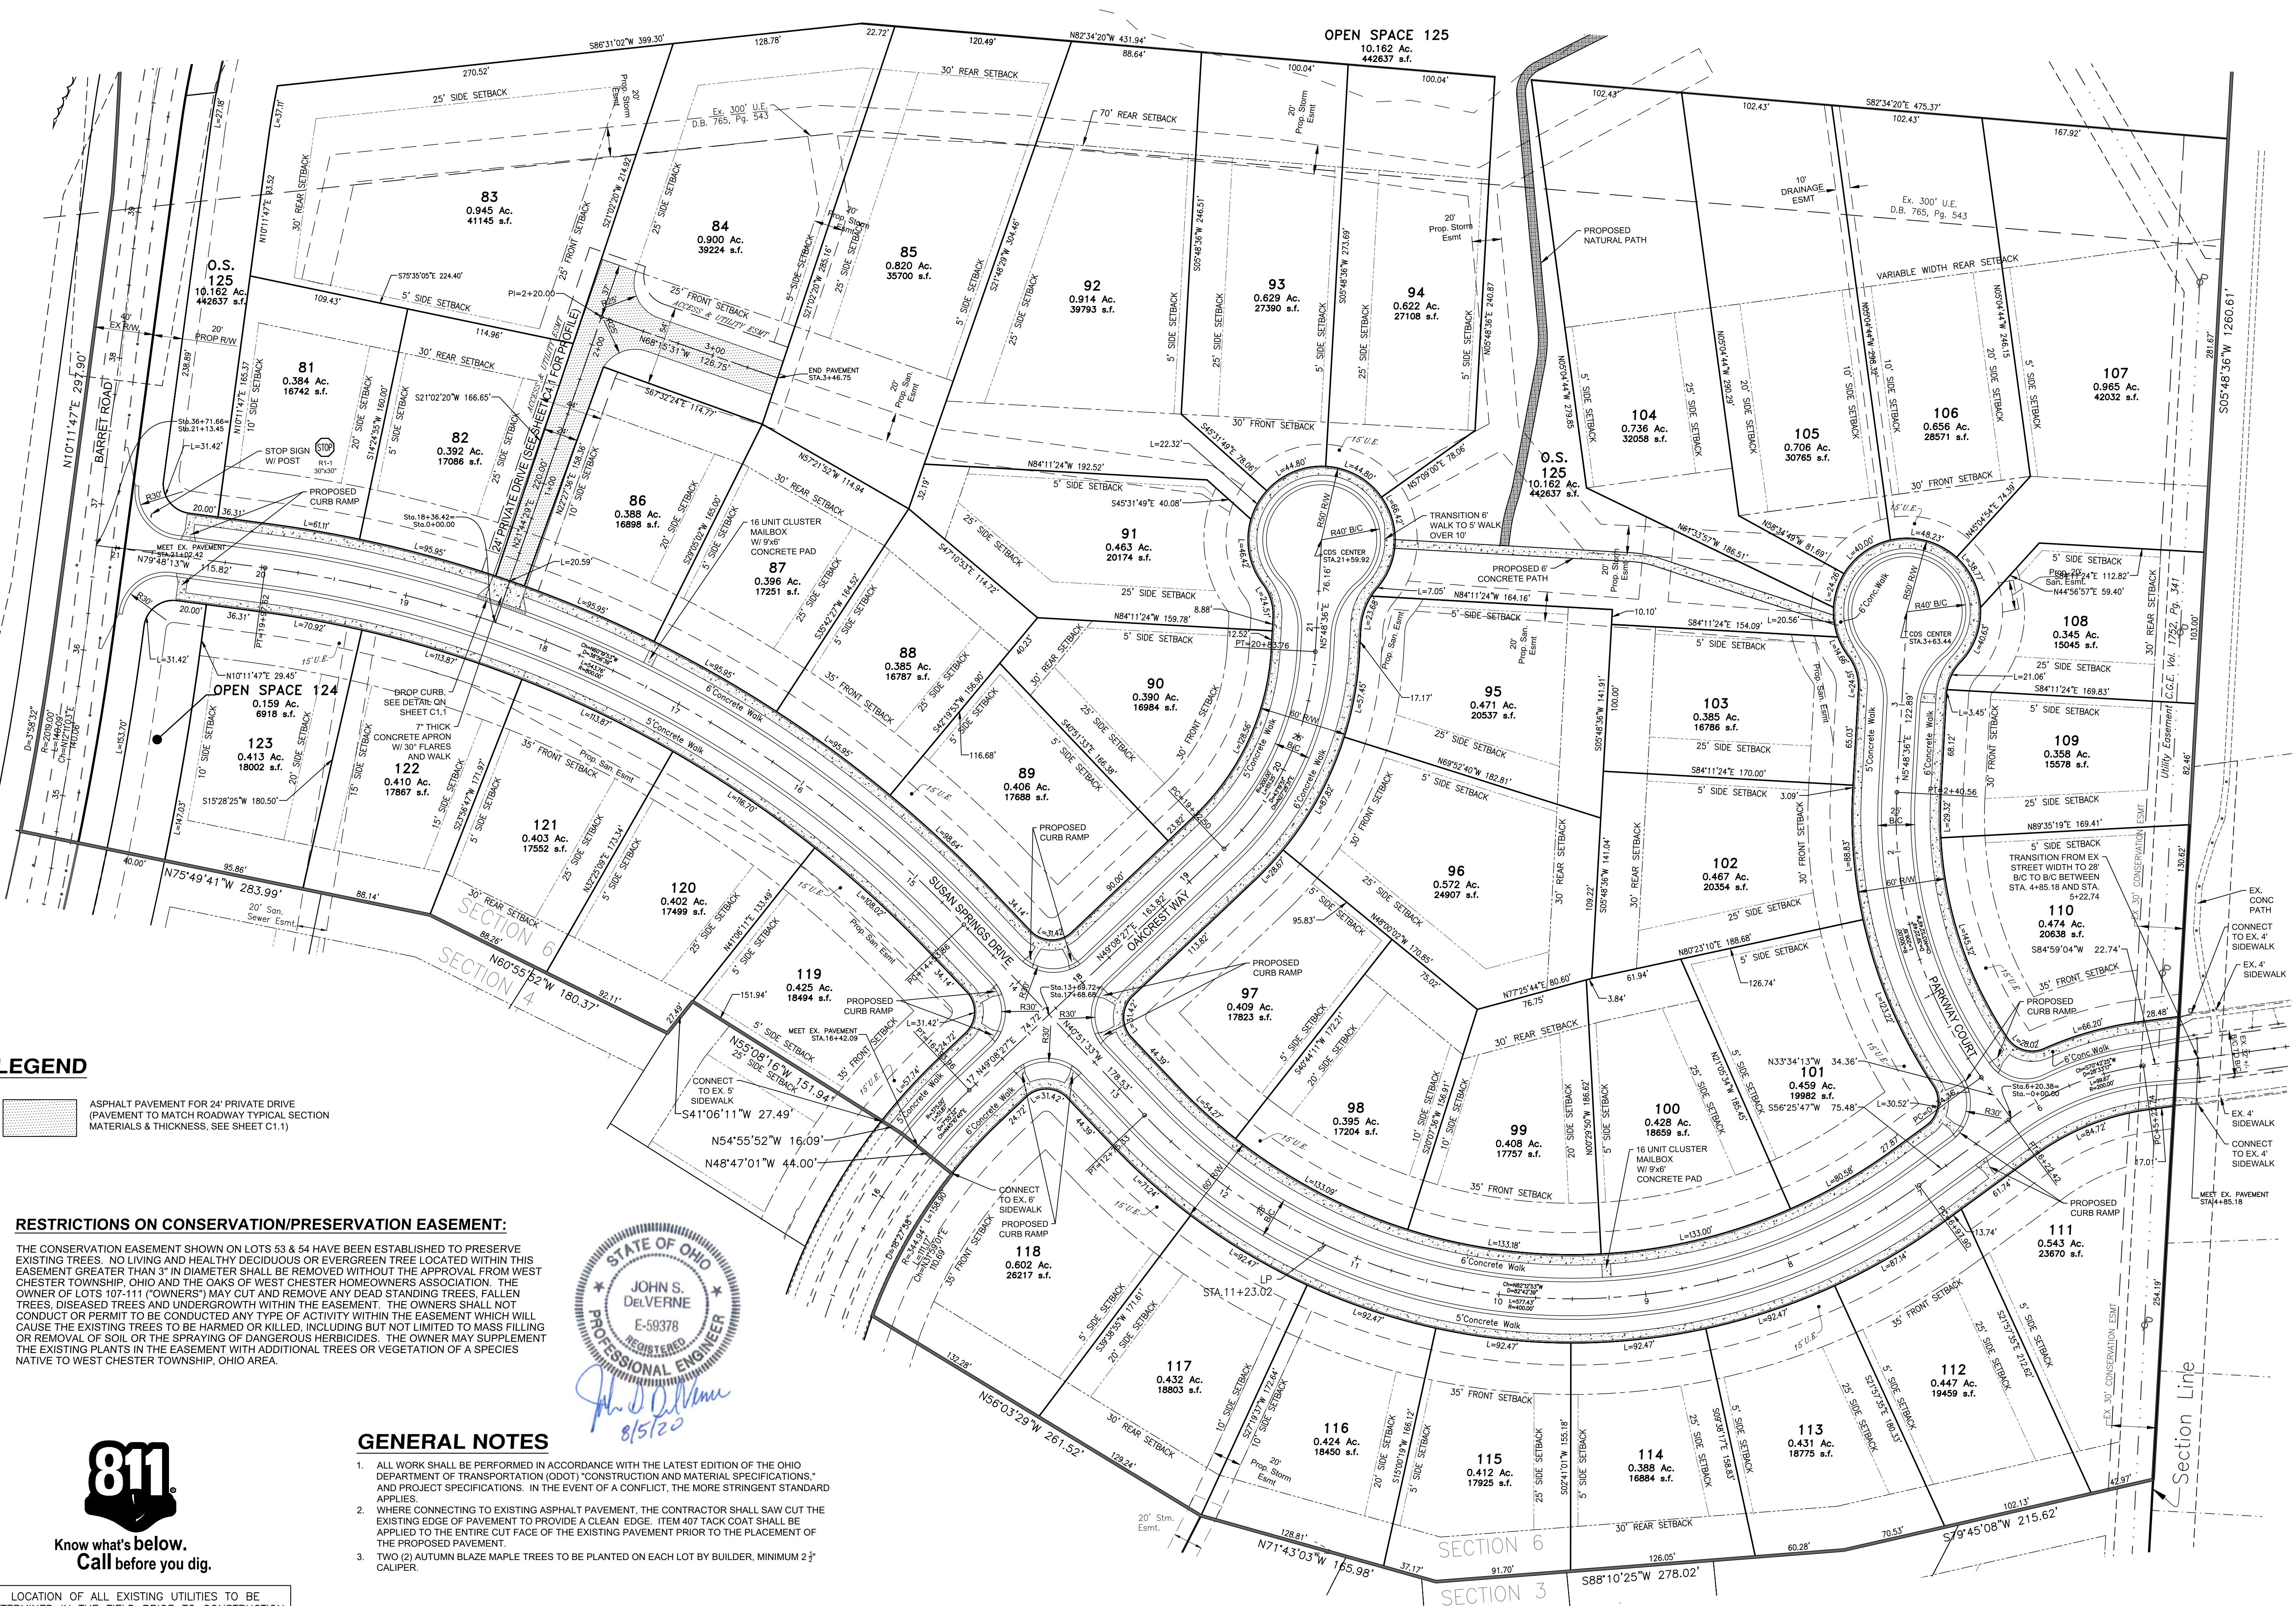

THE OAKS OF WEST CHESTER SECTION SIX (PHASES 5, 6, & 7)

bayer hecker

DRAWING NUMBER
06F158-006 CD
DRAWN BY LDF
CHECKED BY JSD
ISSUE DATE 06-15-20

Sheet:

C2.0

C2.0



Basis of Bearing:

State Plane NAD83 GPS Observations

0 50 75

SCALE: 1" = 50'



0 50 75

SCALE: 1" = 50'

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0 50 75

SCALE: 1" = 50'

S054836W 260.61'


0 50 75

SCALE: 1" = 50'

THE OAKS OF WEST CHESTER SECTION SIX (PHASES 5, 6, & 7)

SECTION 22 TOWN 3 RANGE 2
WEST CHESTER TOWNSHIP,
BUTLER COUNTY, OHIO

UTILITY PLAN

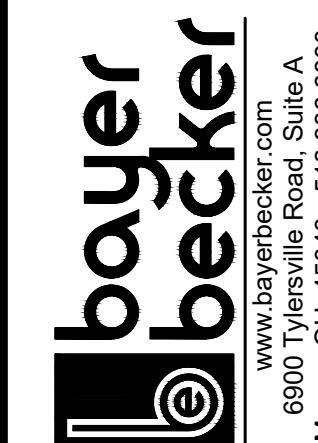www.boyerbecker.com
6900 Tylerville Road Suite A
Mason, OH 45040-336600

Drawing: 06F158-006 CD
Drawn by: LDF
Checked By: JSD
Issue Date: 06-15-20
Sheet: C3.0

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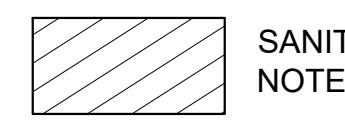
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0 50 75

SCALE: 1" = 50'


LEGEND

SANITARY BACKFILL COMPACTION, SEE
NOTE #12 ON THIS SHEET

NOTE:
At crossings, the water main shall have a minimum vertical distance of eighteen (18") inches from storm and sanitary sewers. Also, one full length of water main shall be located so the joints are as far from the storm and sanitary sewers as possible.

WATER MAIN RESTRAINT JOINT LOCATION CHART

Water Main Dia.	Horizontal 45° Bends	Vertical 45° Bends (Lower Water Under...)	Vertical 45° Bends Down (Lower Water Under...)	Ded End (Permanent & Temporary)
6"	16' both sides	16' both sides	36' both sides	72' Back
8"	18' both sides	36' both sides	36' both sides	90' Back
10"	36' both sides	36' both sides	54' both sides	117' Back
12"	36' both sides	54' both sides	72' both sides	180' Back
14"	54' both sides	54' both sides	90' both sides	198' Back
16"	54' both sides	54' both sides	90' both sides	216' Back

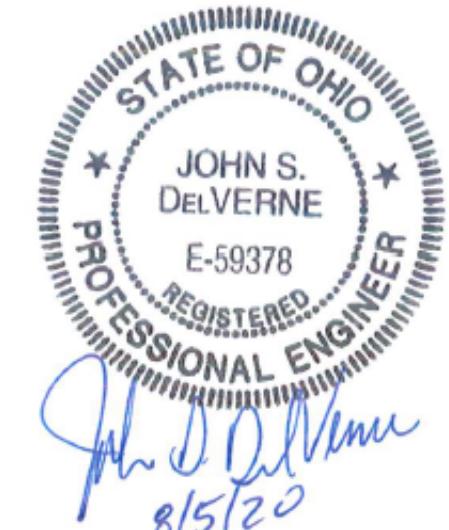

JOHN S.
DelVERNE
E-59378
REGISTERED
PROFESSIONAL ENGINEER

John S. DelVerne
8/5/20

UTILITY NOTES:

- 48 hours notice to be given to affected residents before construction begins.
- All Catch Basin T/G Elevations located within the curb are set to the Gutter Line Elevations.
- Lower 1" Water Services as needed to avoid conflicts with Storm with Min. 4" Cover.
- 1" water services to be installed with Type K Copper per BCWS specifications.
- Location of existing utilities to be determined in the field prior to work beginning.
- All lots Sump to Sump Drain unless otherwise noted in plan.
- Sump Lines to be installed as per Standard Service Detail. Wyes or Tees are to be placed ten feet past lot line, on the low side of specified lots, and marked with Wye poles.
- All roof drains for lots 83-85, and 92-94 to be directed to the storm sewer system.
- Contractors to accept all quantities as correct prior to beginning construction.
- Contractor end deep connection sanitary sewer laterals at 12' below grade. See detail on sheet C8.0.
- Trench Backfill for the storm system constructed along the slope north of lots 83-85, 92-94, and 104-106, and the trenches between lots 84 & 85, 93 & 104, and 105 & 106 shall be compacted to at least 95% Standard Proctor (ASTM D698).
- Trench Backfill for the sanitary system between manholes CC-DD-EE-GG, EE-OO-PP-QQ-RR, RR-TT-UU, RR-SS, and TT-VV shall be compacted to at least 95% Standard Proctor (ASTM D698).



Know what's below.
Call before you dig.



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Call before you dig.

LOCATION OF ALL EXISTING UTILITIES TO BE
DETERMINED IN THE FIELD PRIOR TO CONSTRUCTION



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STATE OF OHIO
JOHN S. DELVERNE
E-59378
REGISTERED
PROFESSIONAL ENGINEER

Basis of Bearing:
State Plane NAD83 GPS Observations

Scale: 1" = 50'






*John S. DelVerne
8/5/20*

Date [Drafn: Chk: 07-09-20 DTM JSD 08-05-20 LDF JSD]
Item 1 REVISED PER ZONING COMMENTS
Revision Description 2 BUTLER COUNTY COMMENTS
Section 3
Sheet 4

THE OAKS OF WEST CHESTER SECTION SIX (PHASES 5, 6, & 7)
SECTION 22 TOWN 3 RANGE 2
WEST CHESTER TOWNSHIP,
BUTLER COUNTY, OHIO

UTILITY PLAN


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Mason, OH 45040 - 513.336.6600

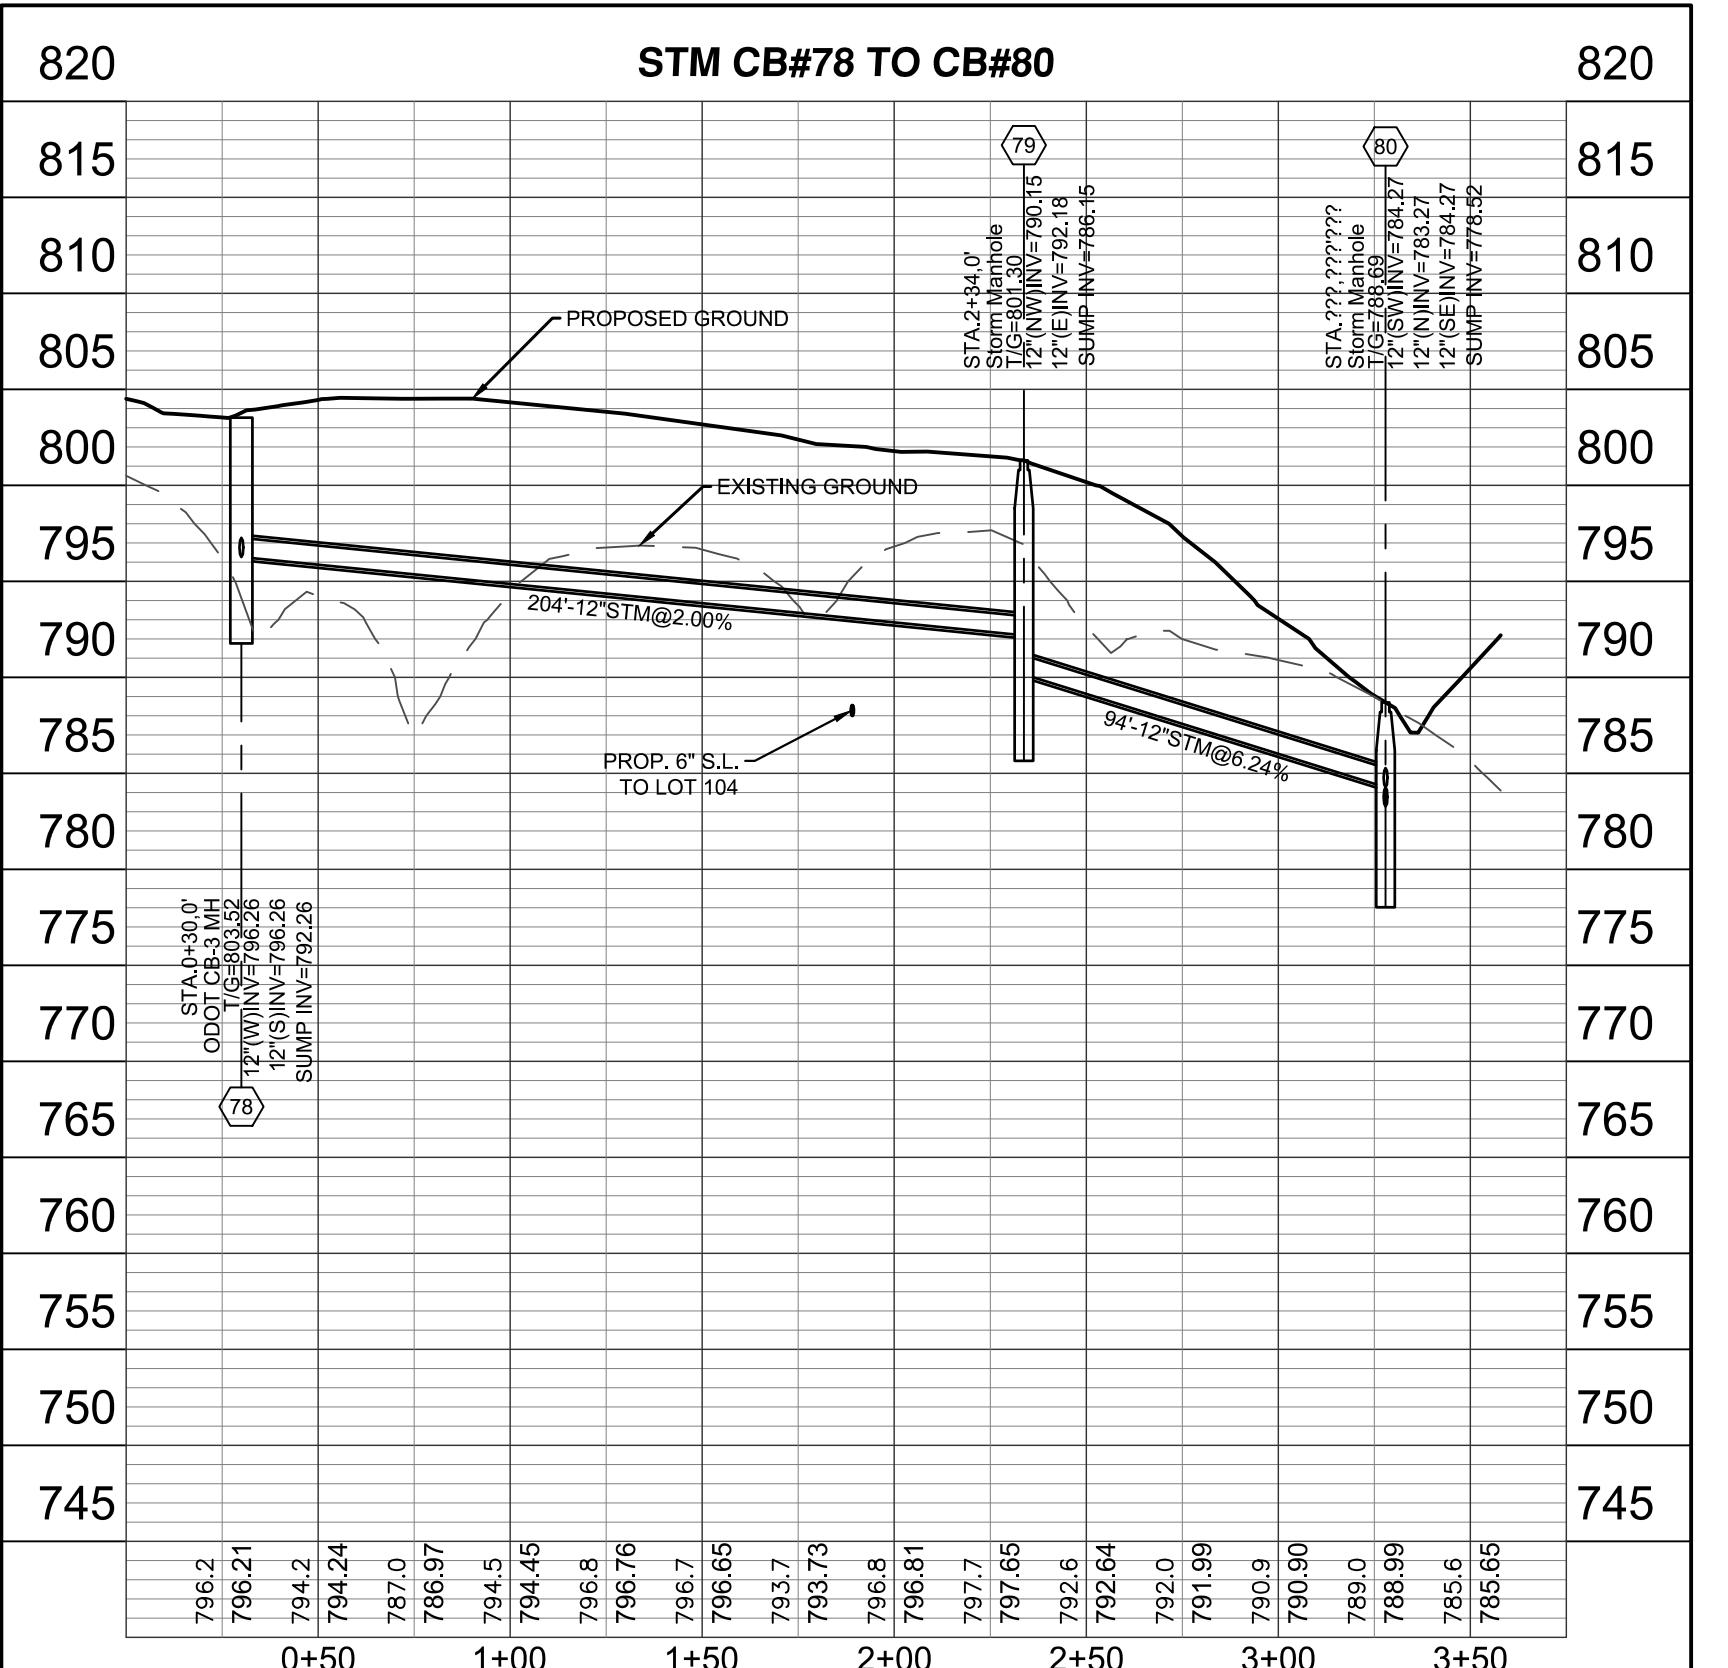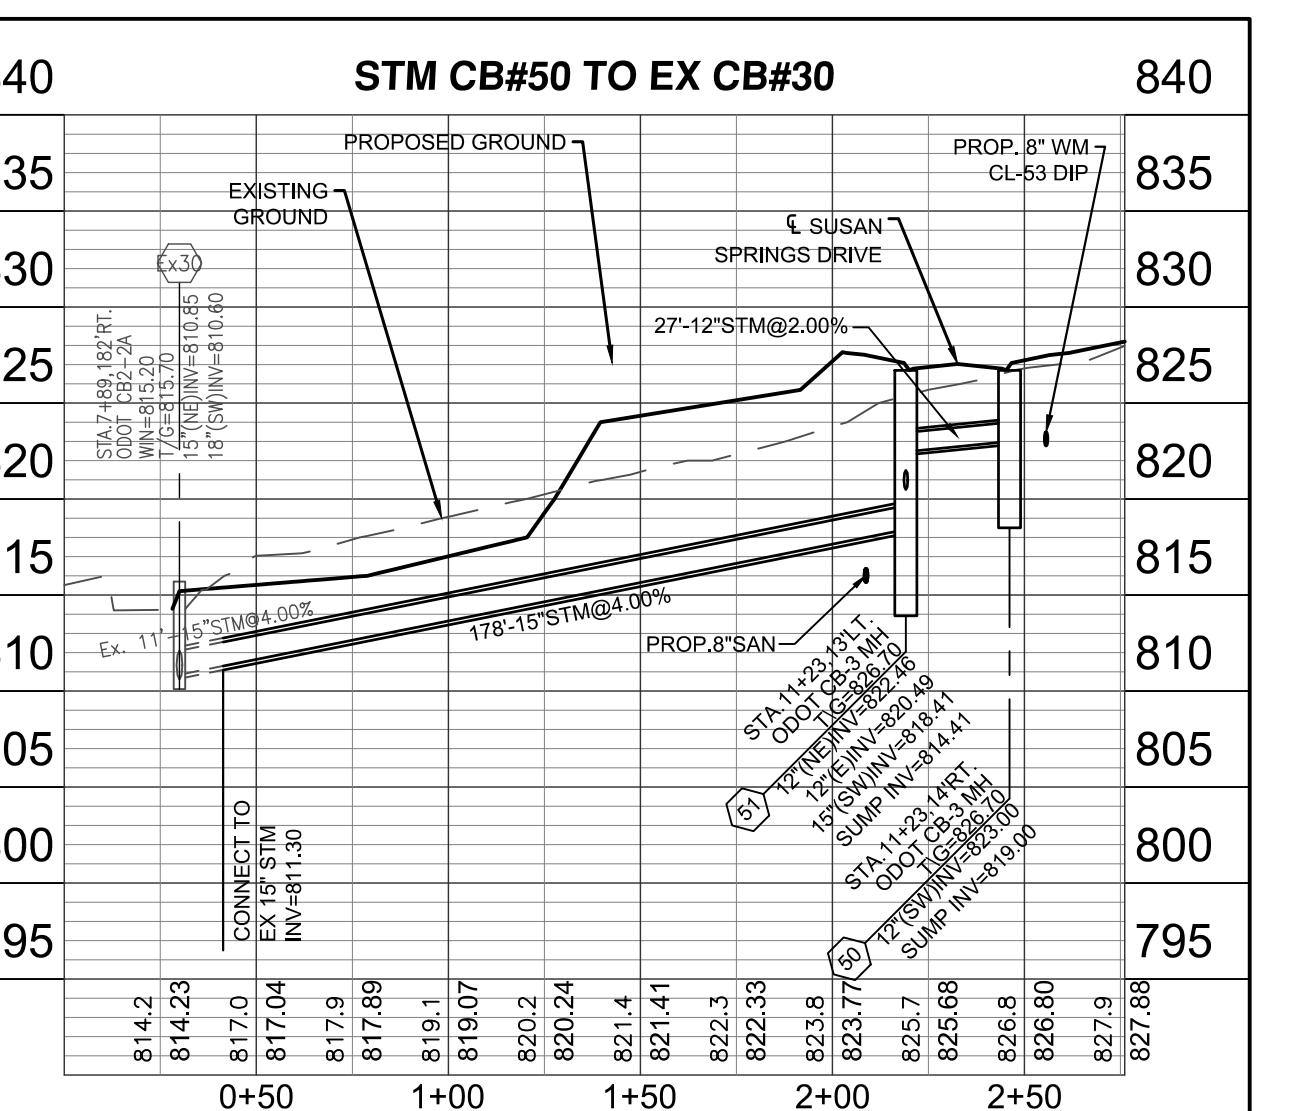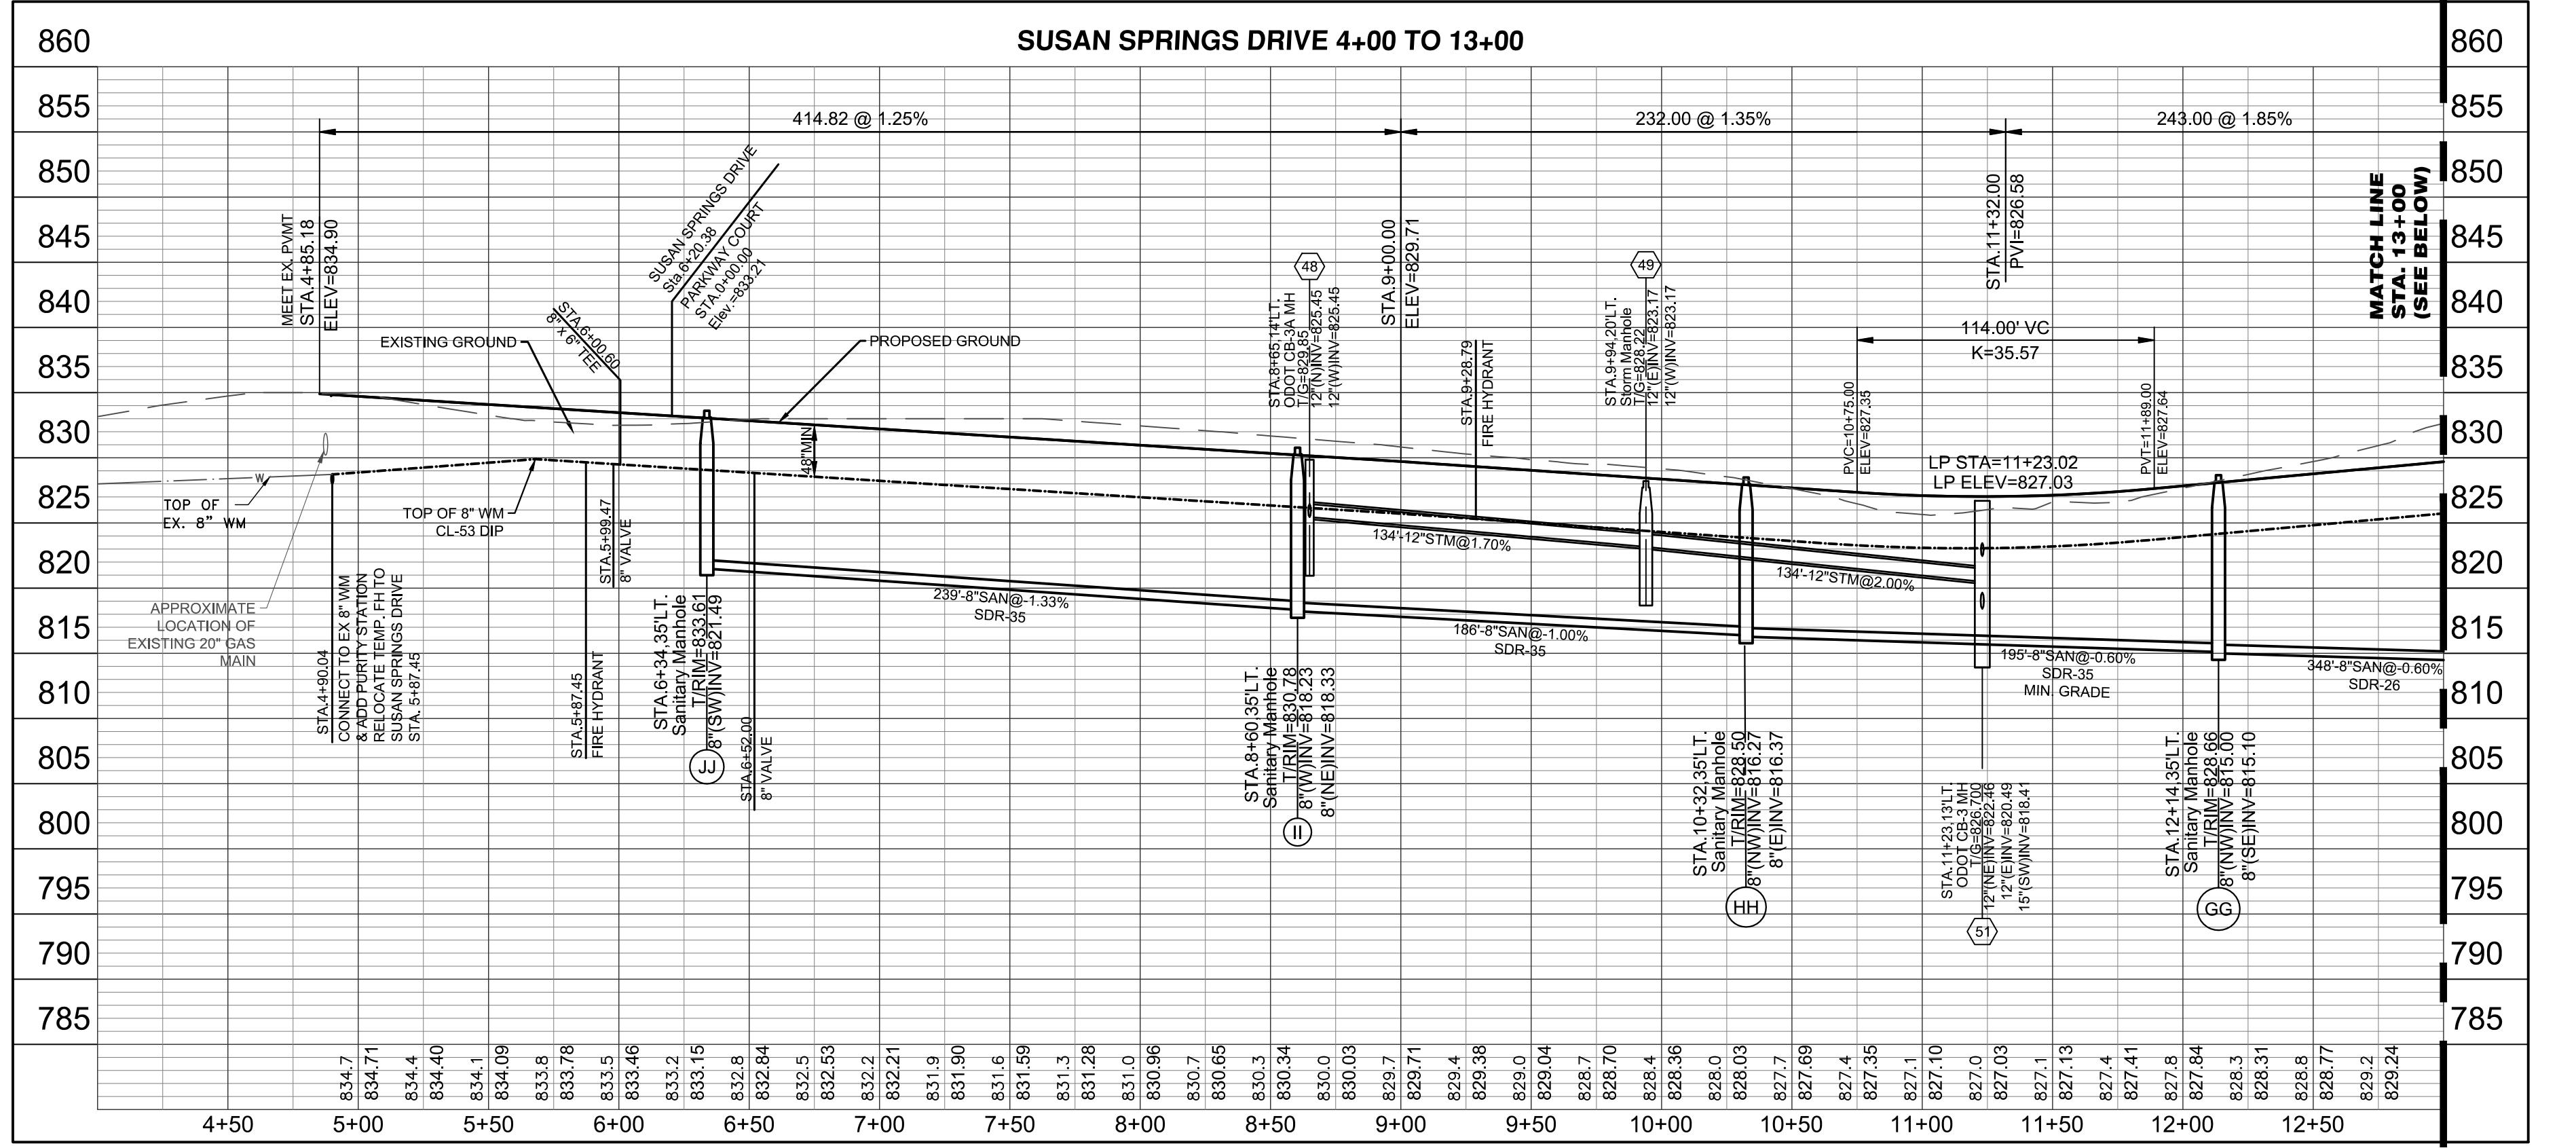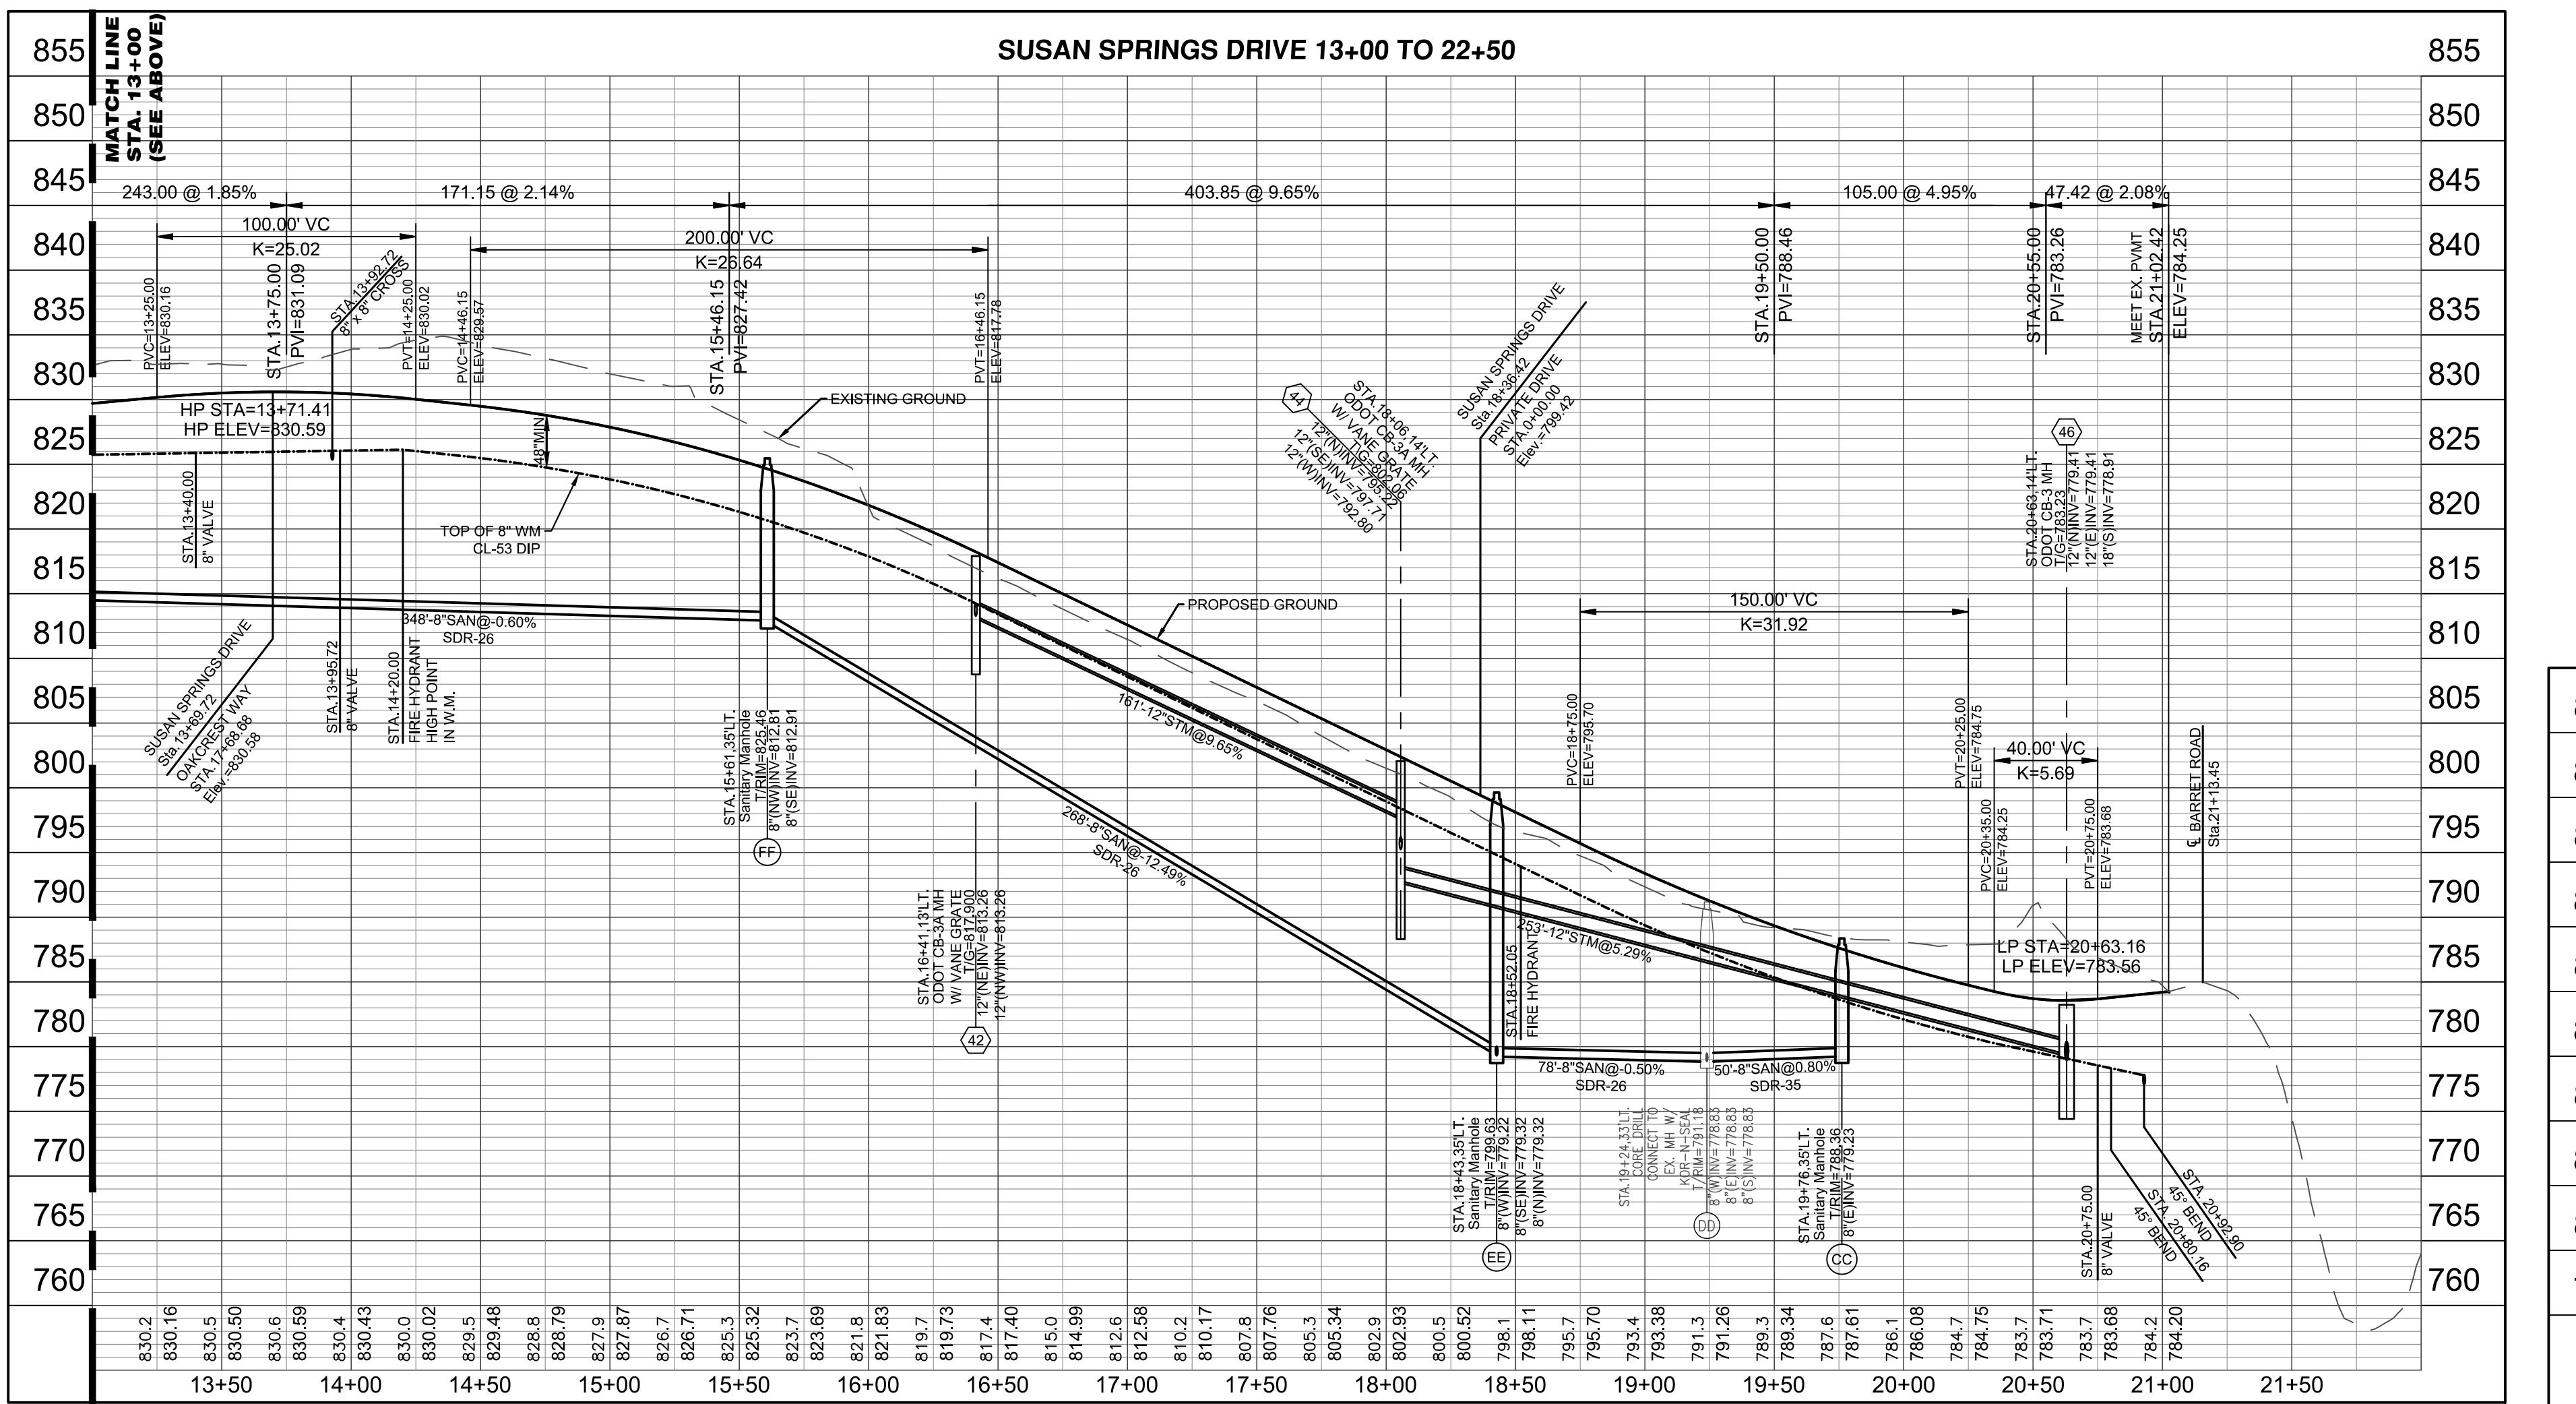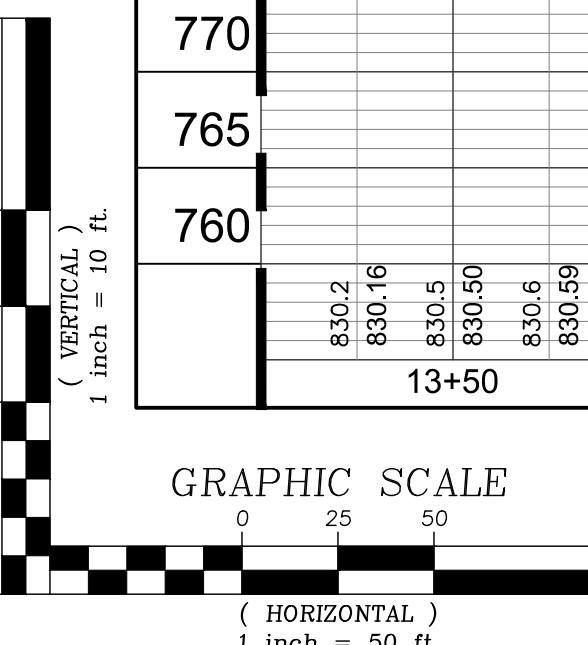

**THE OAKS OF WEST CHESTER
SECTION SIX (PHASES 5, 6, & 7)**






SECTION 22 TOWN 3 RANGE 2
WEST CHESTER TOWNSHIP,
BUTLER COUNTY, OHIO

UTILITY PROFILES

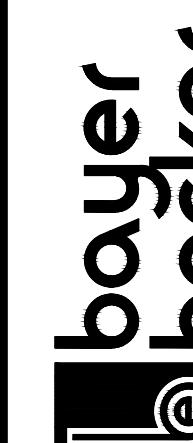

**boyer
becker**


www.boyerbecker.com
6900 Tyner Road Suite A
Mason, OH 45040-336600

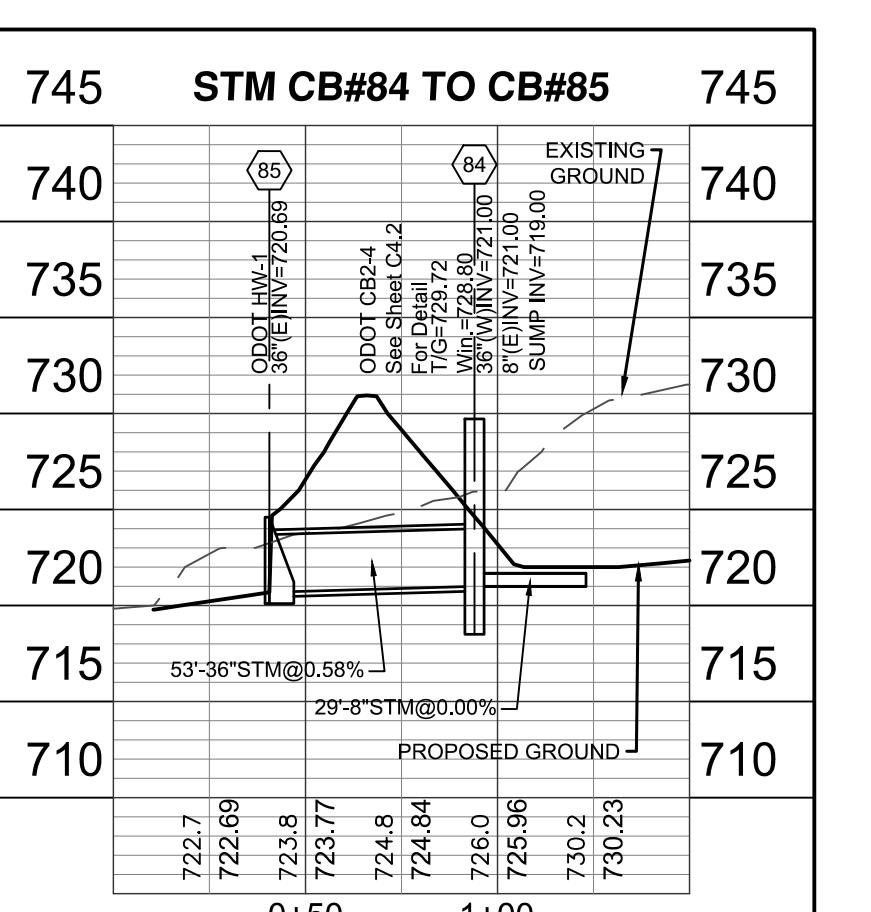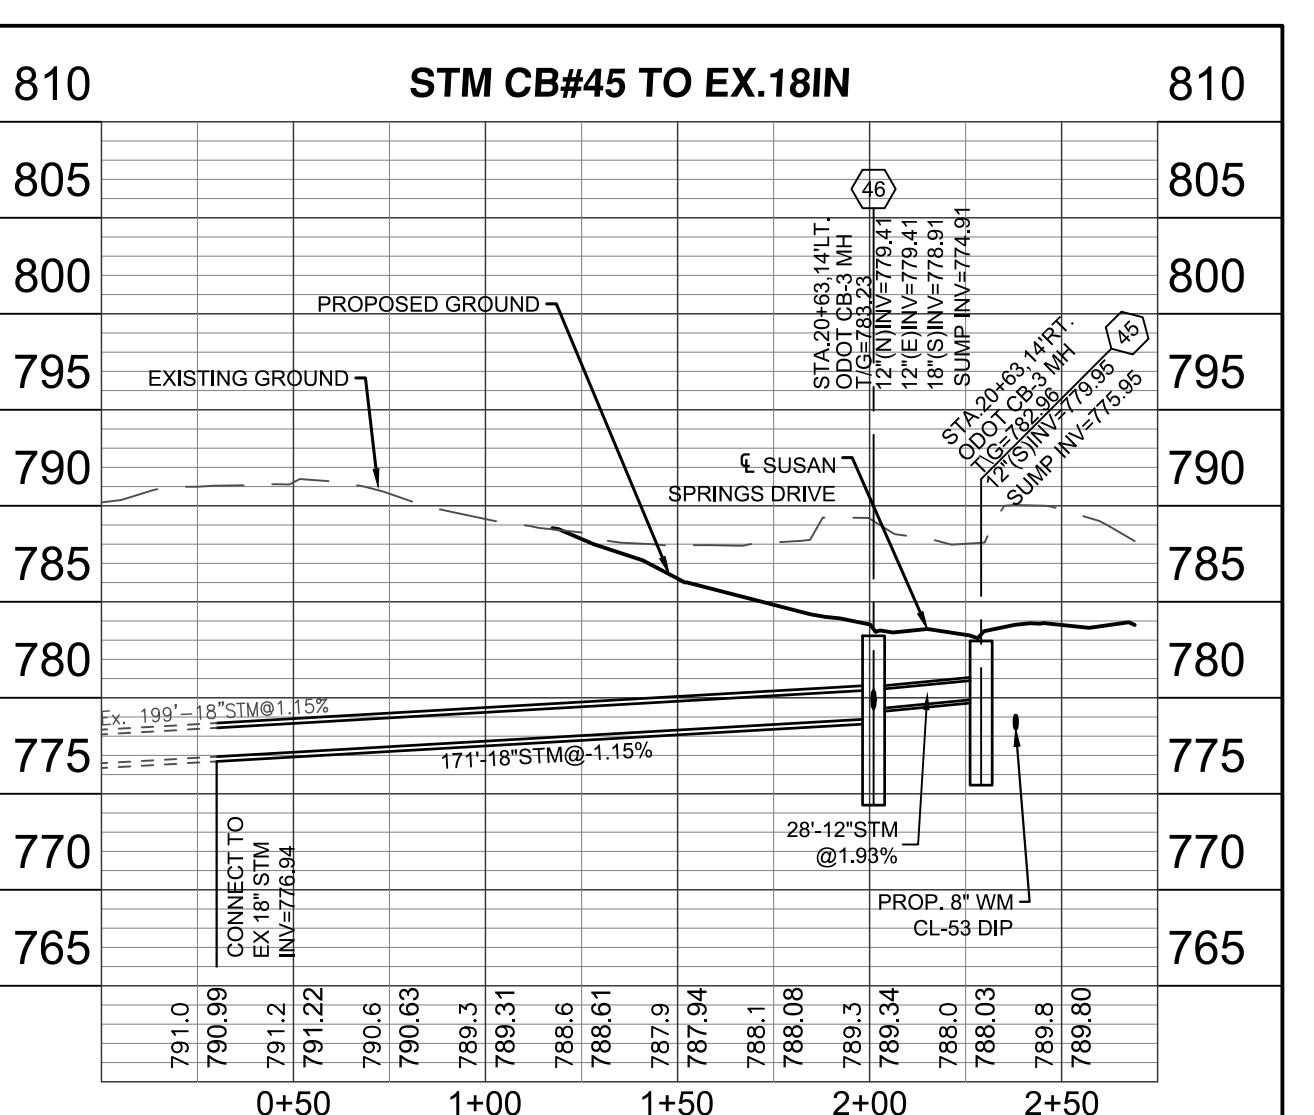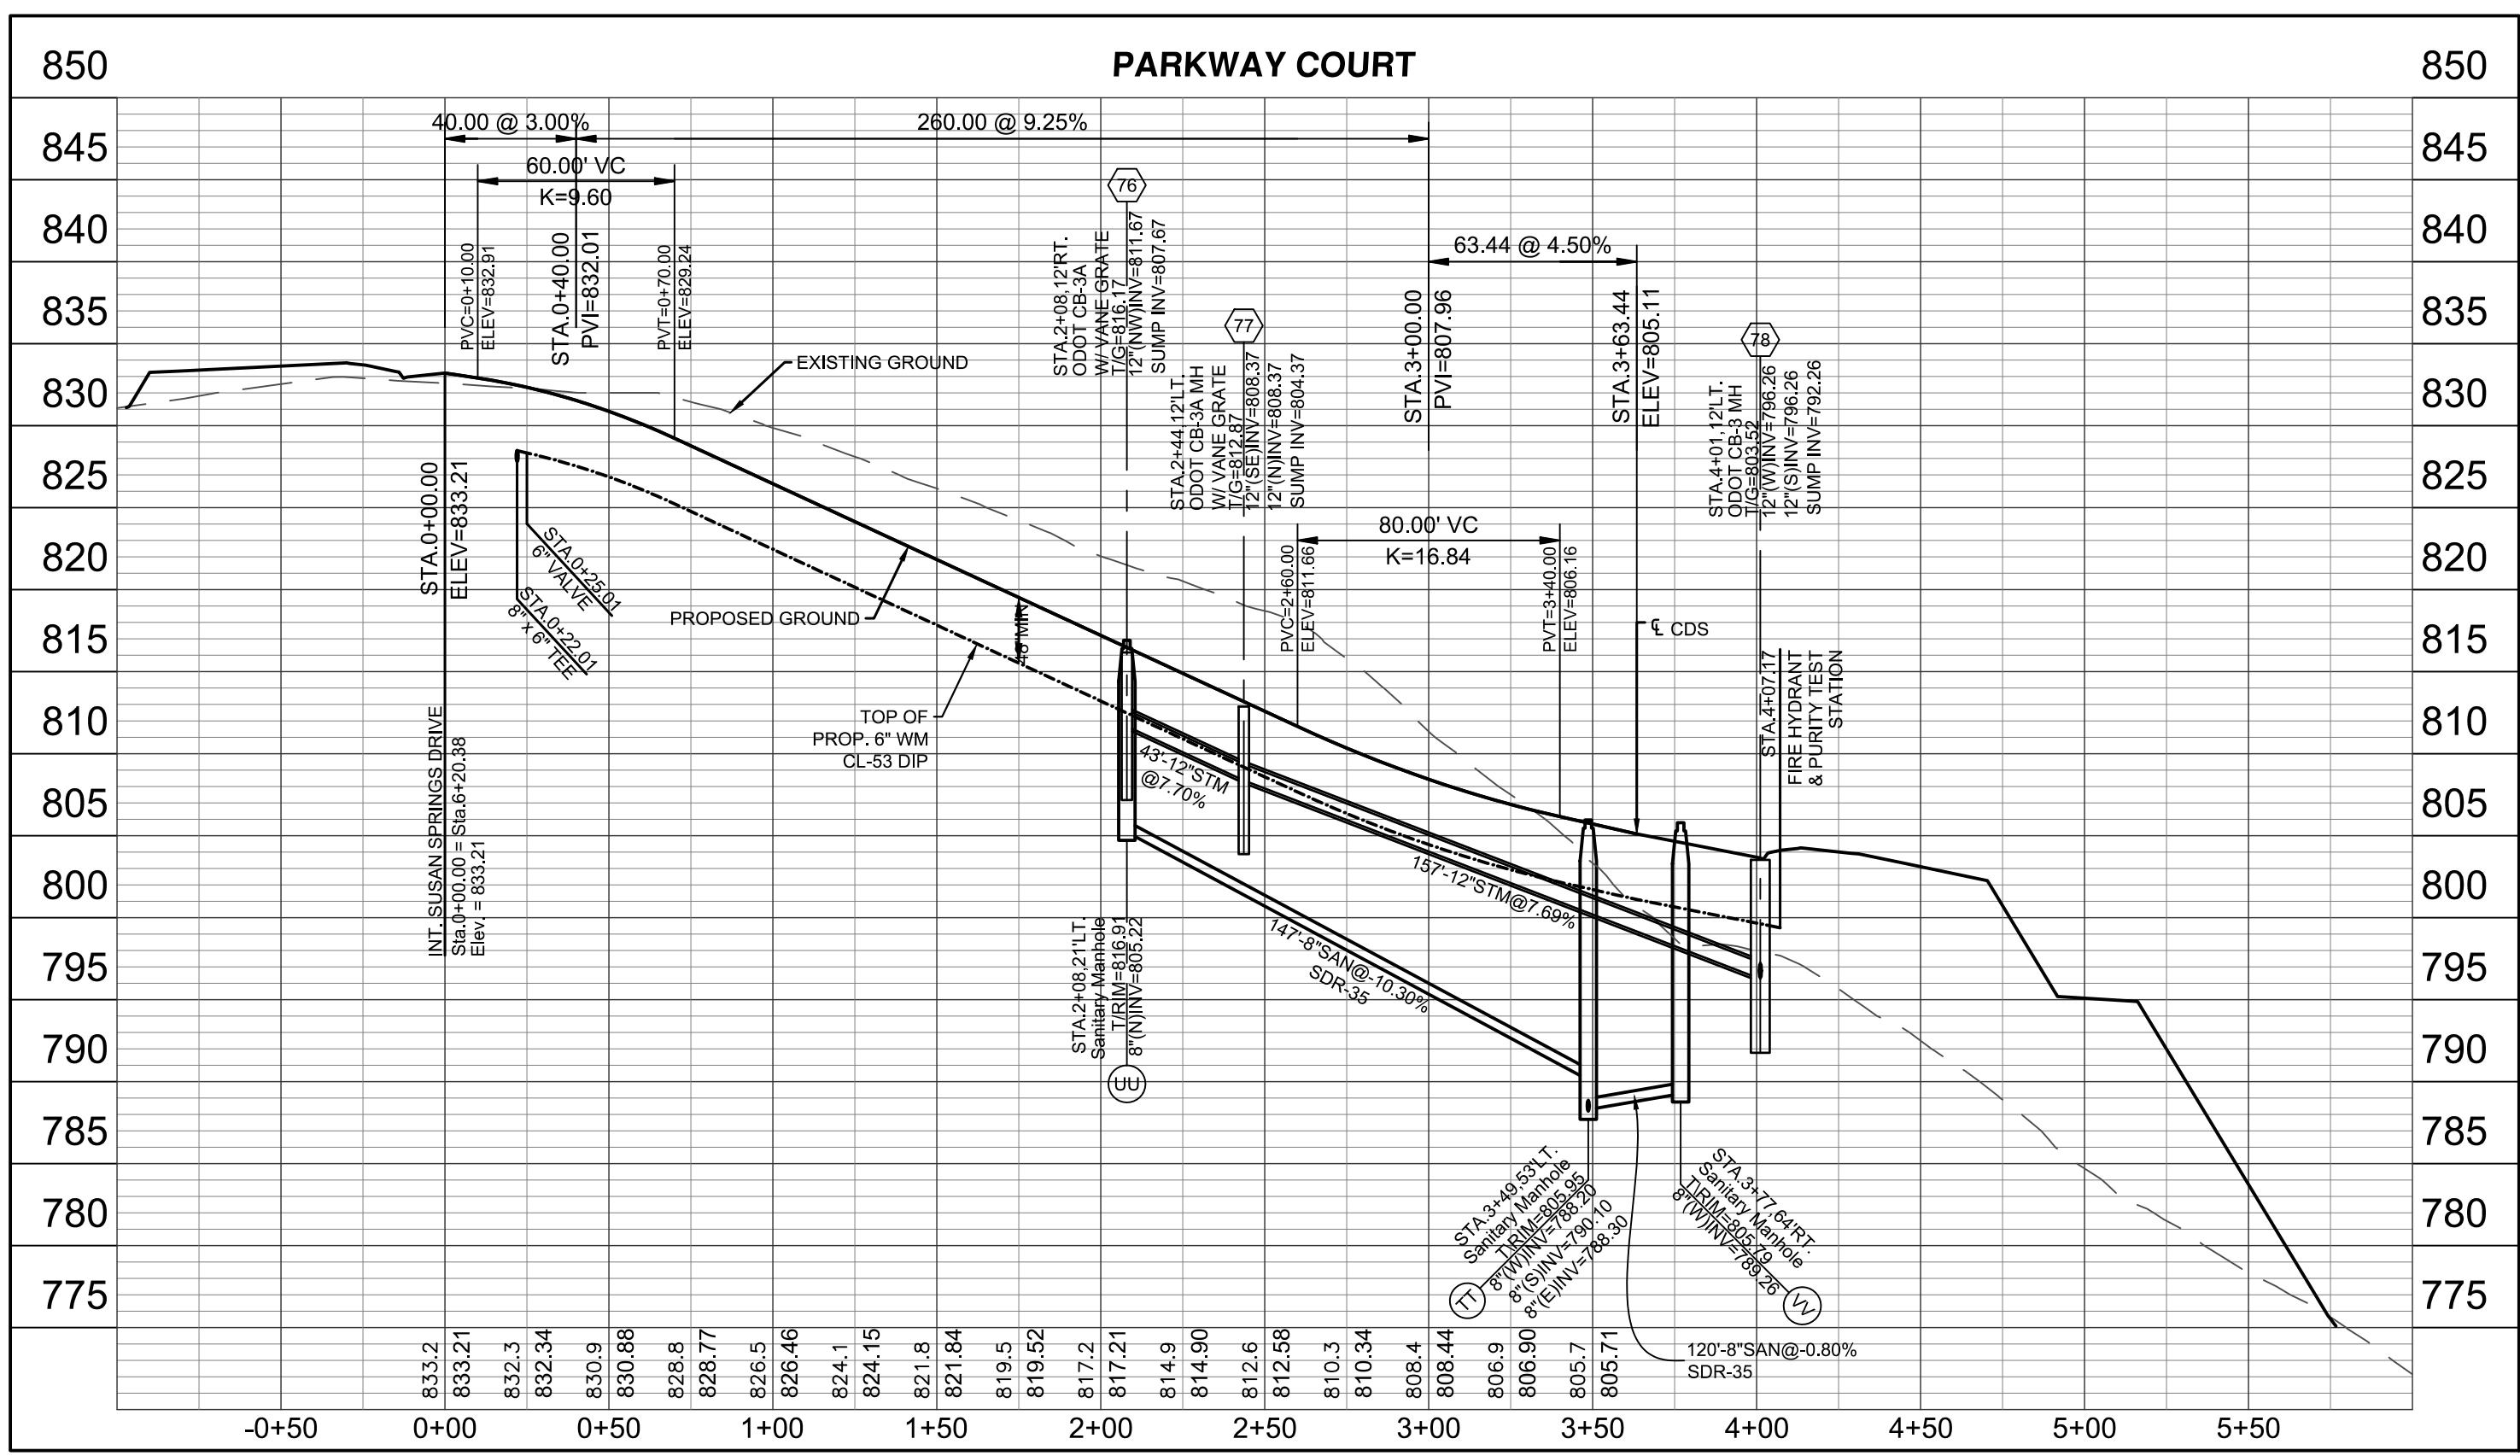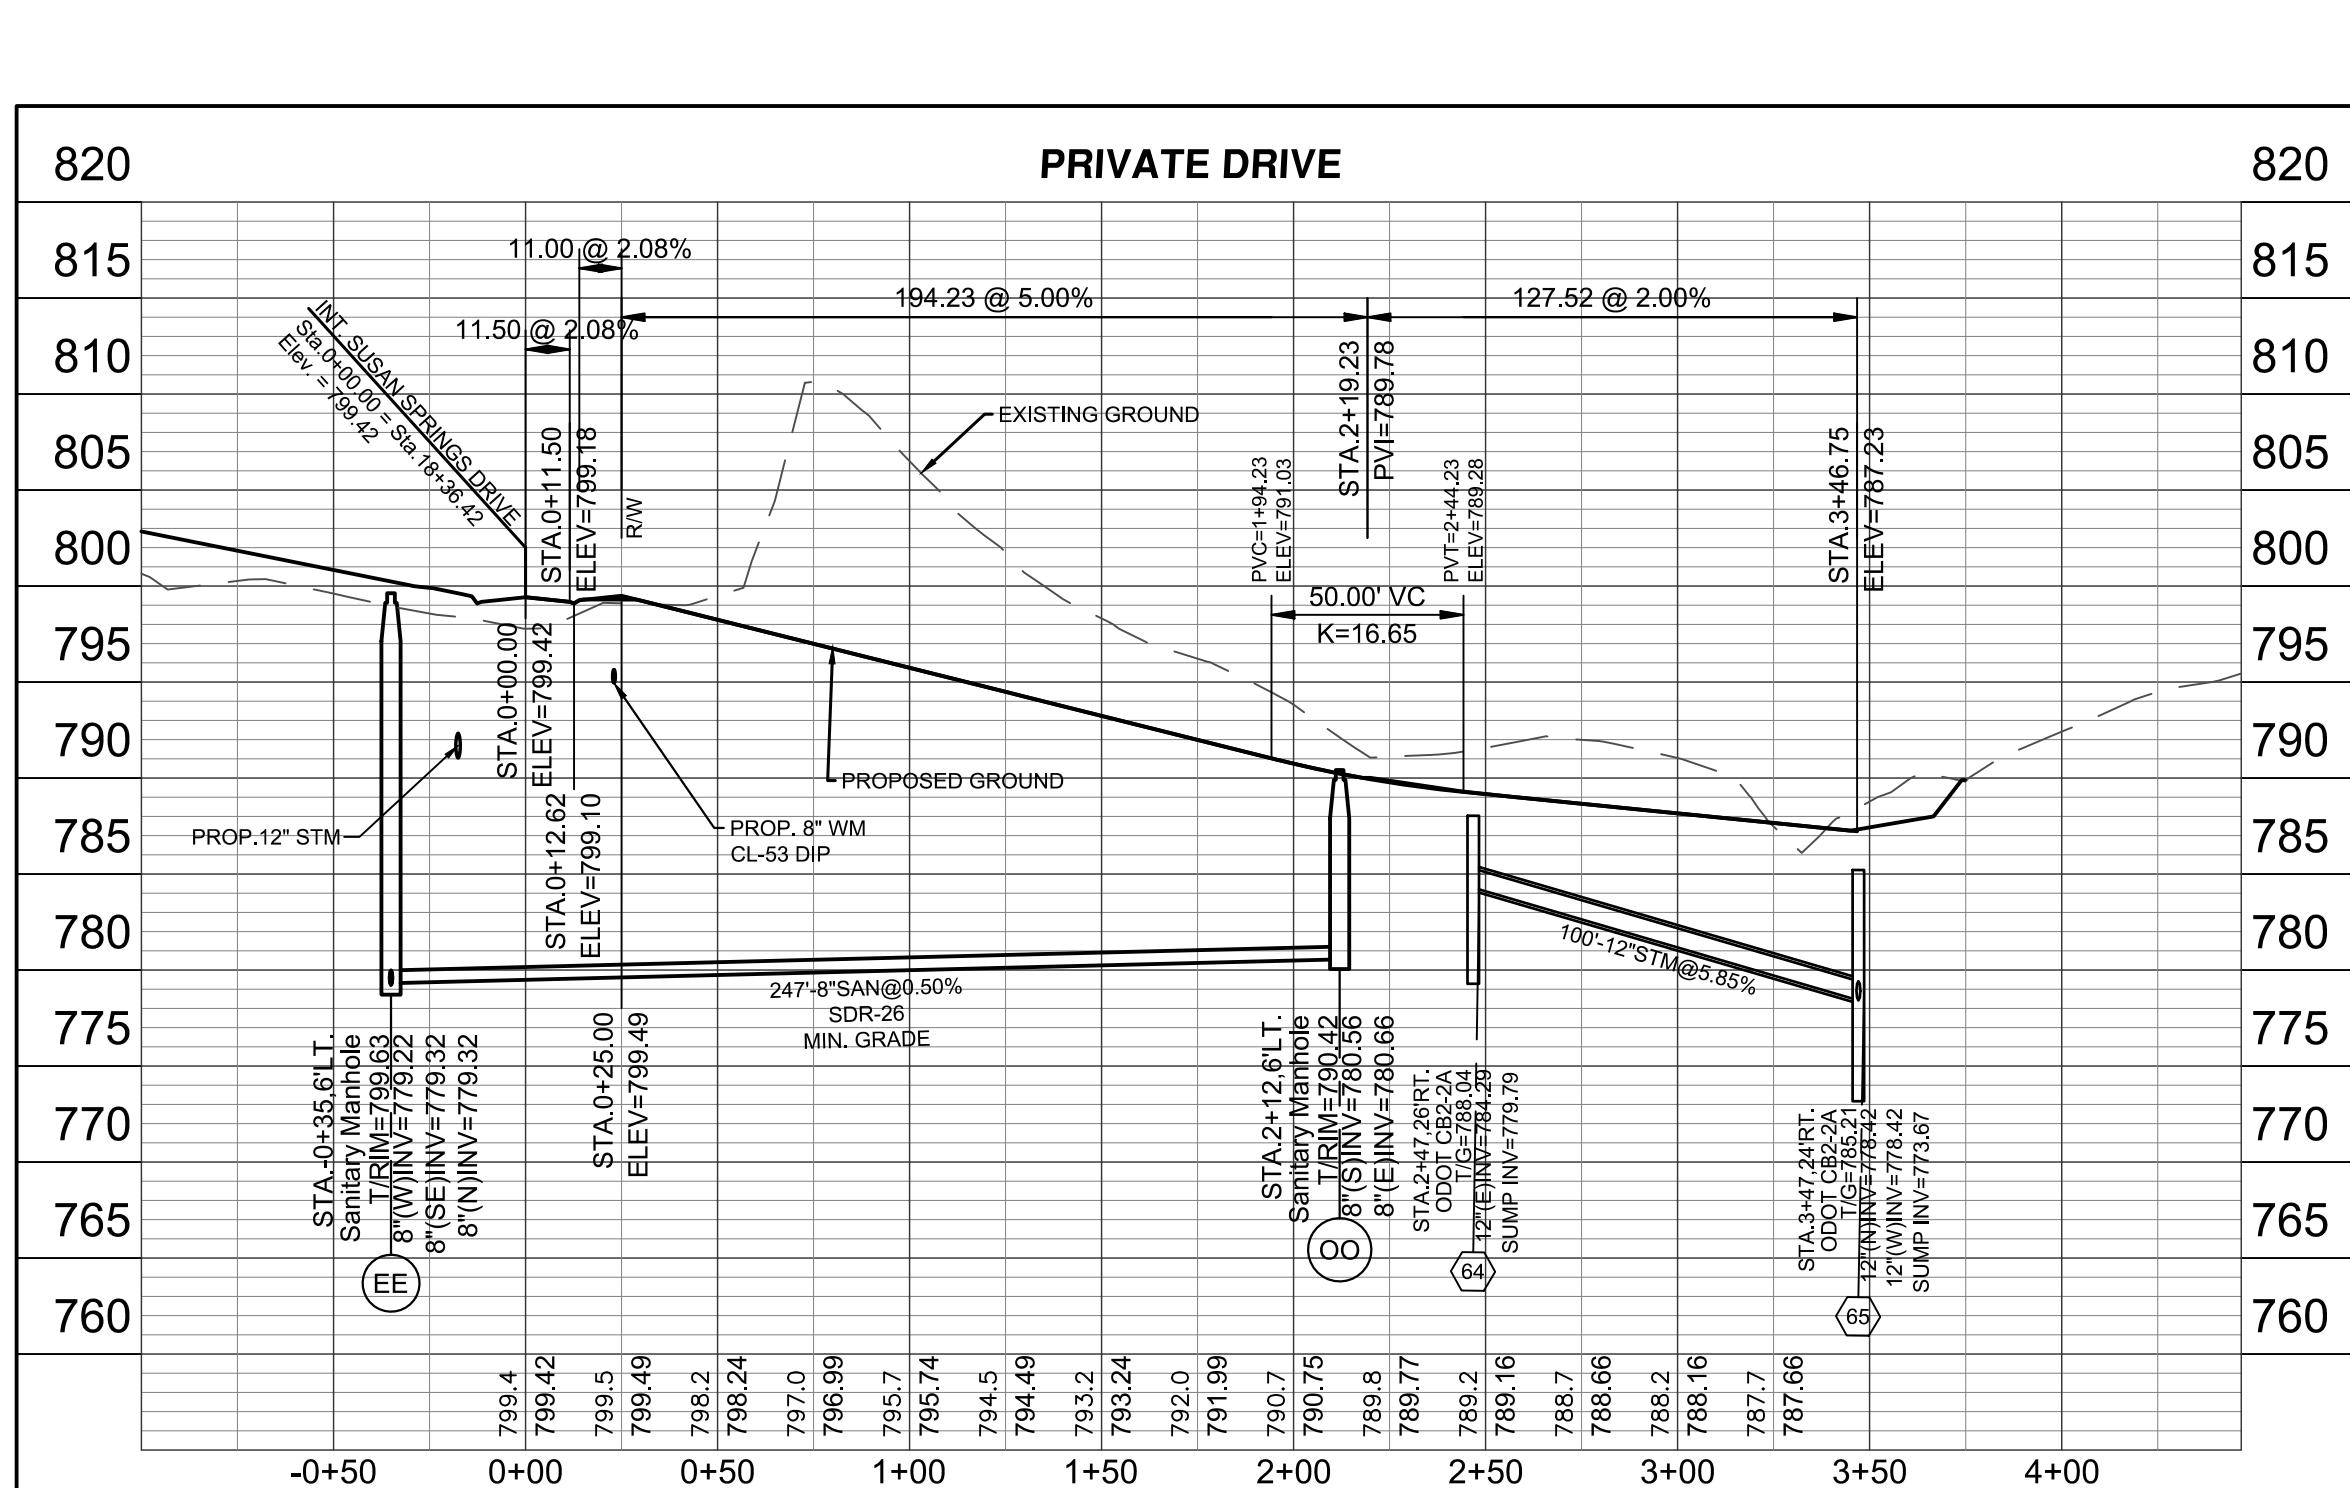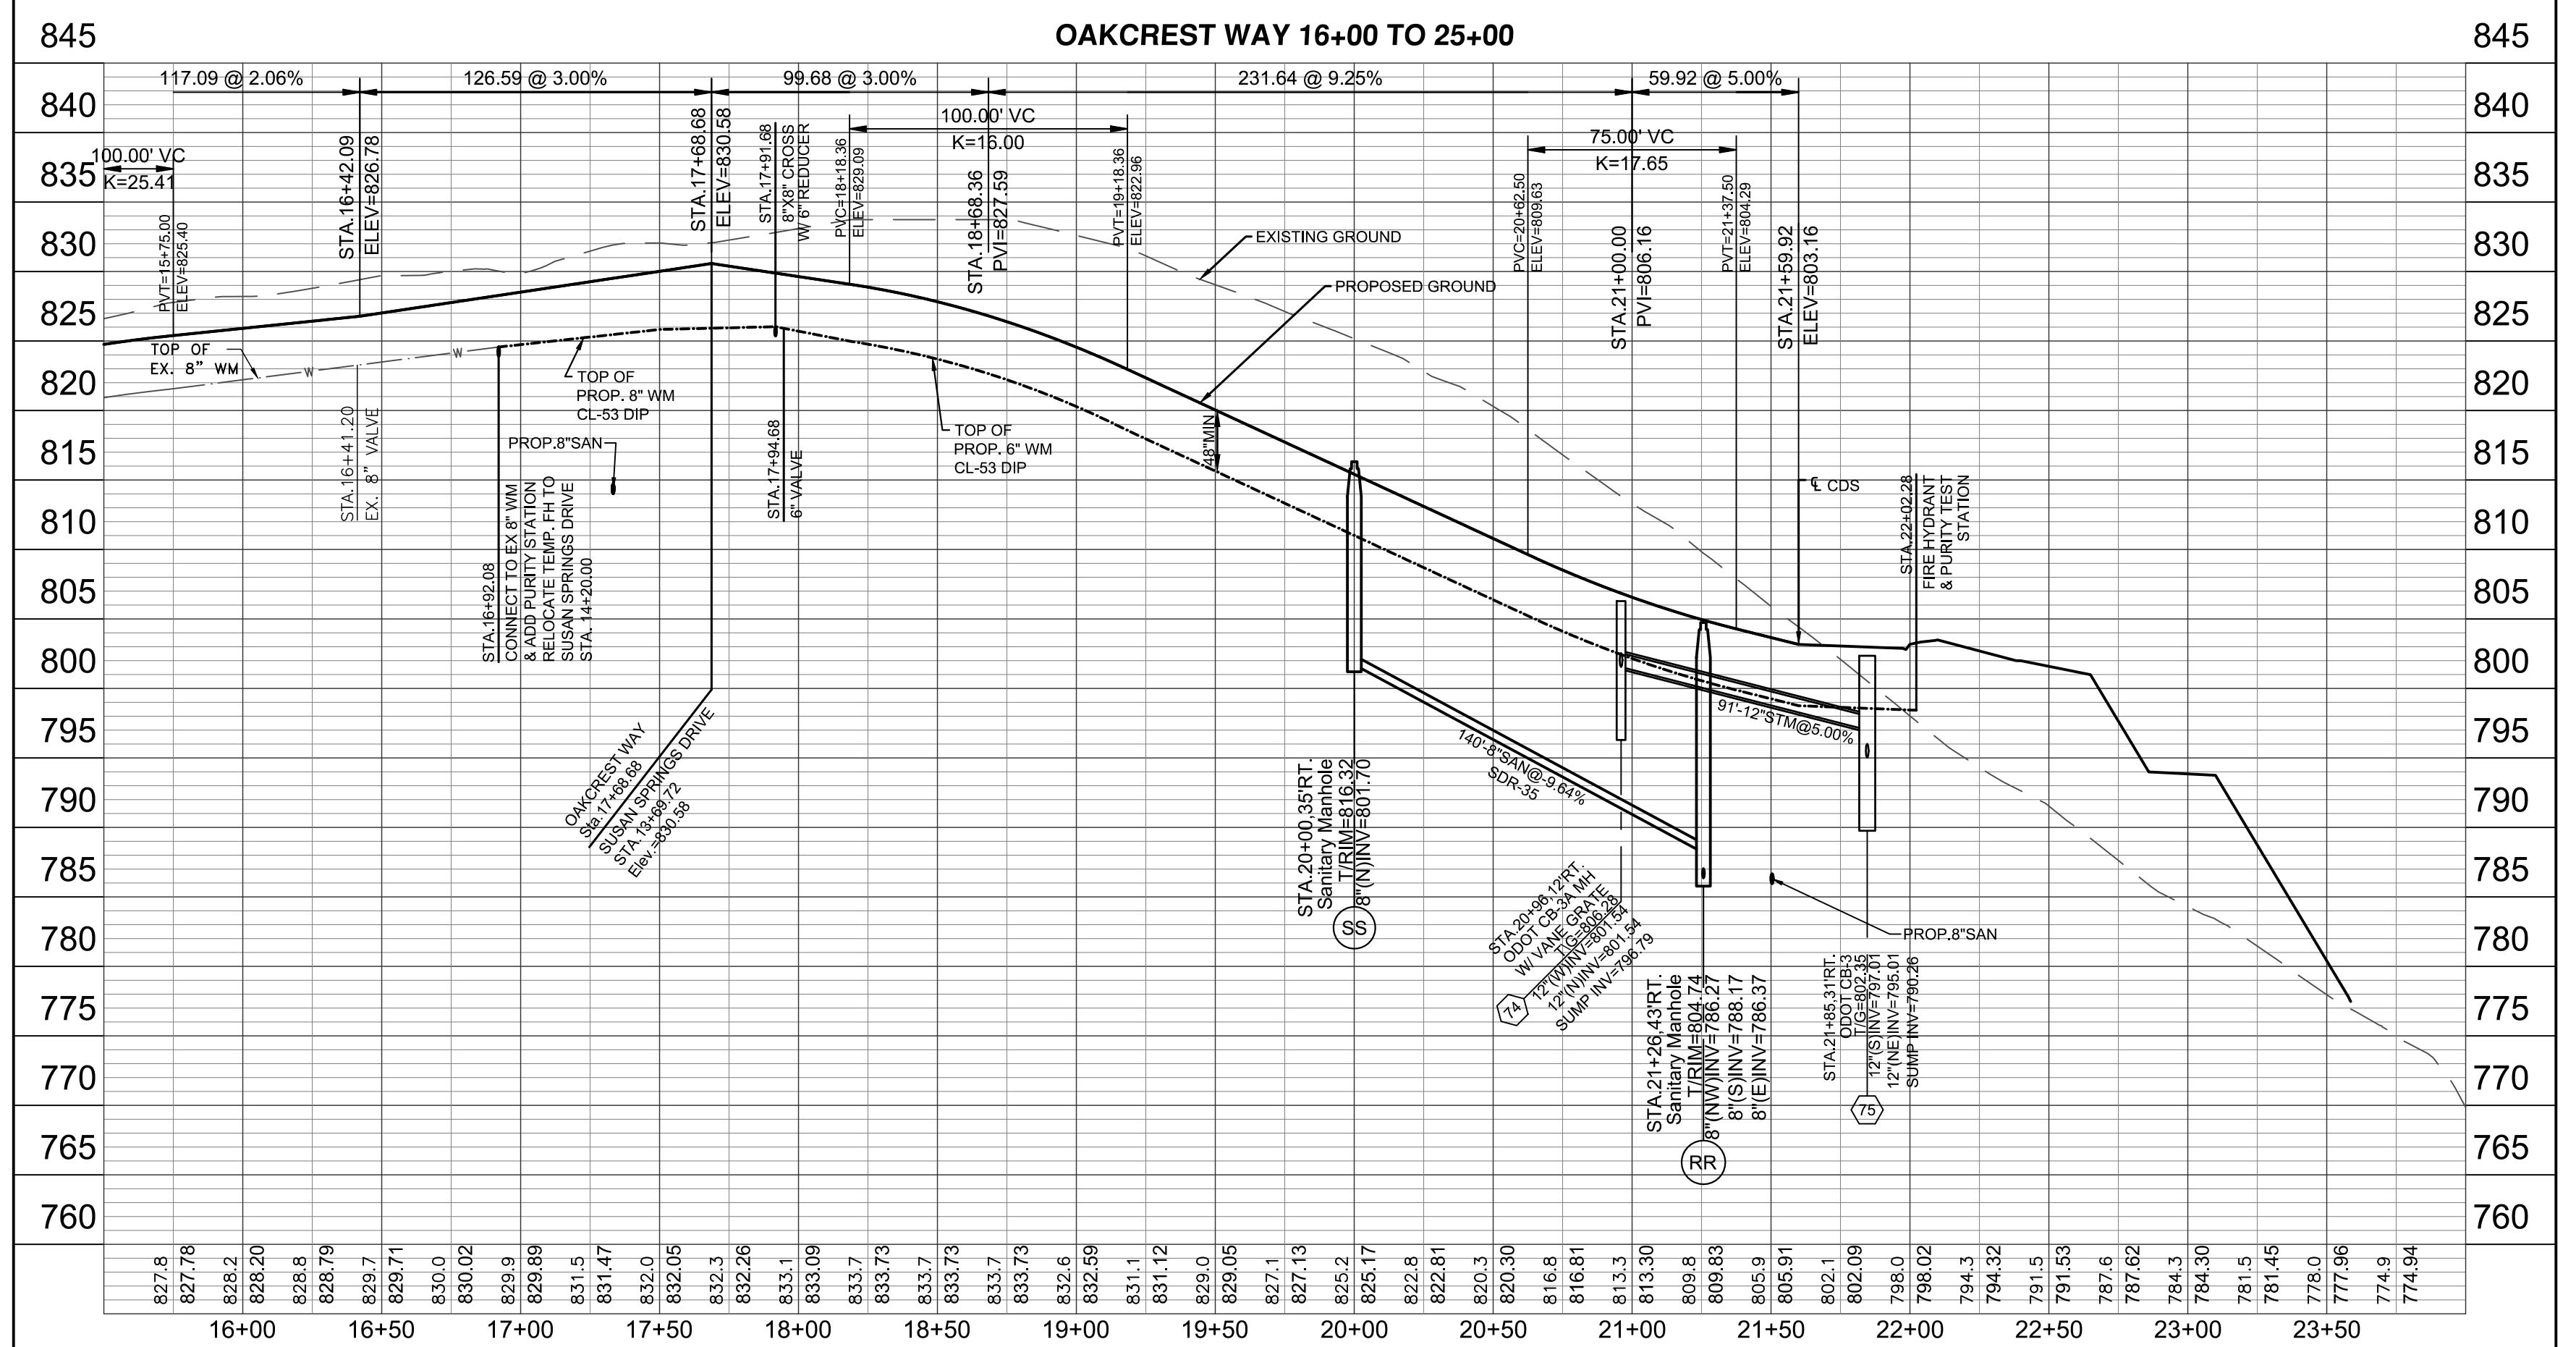

THE OAKS OF WEST CHESTER SECTION SIX (PHASES 5, 6, & 7)

SECTION 22 TOWN 3 RANGE 2
 WEST CHESTER TOWNSHIP,
 BUTLER COUNTY, OHIO

UTILITY PROFILES

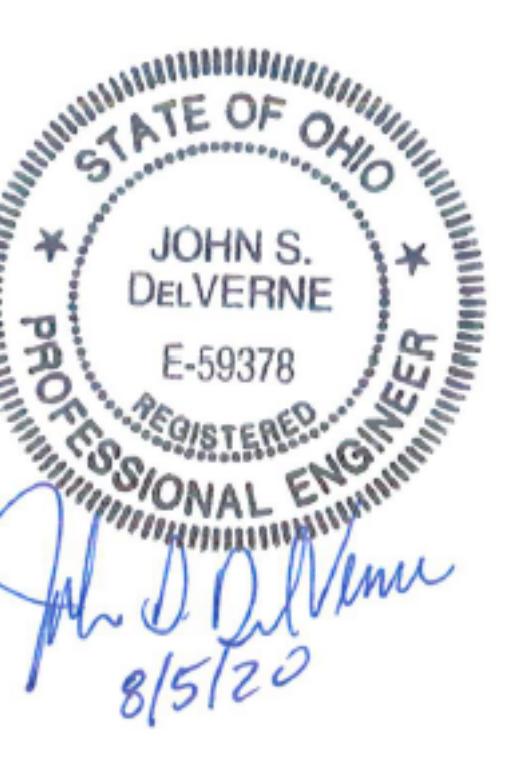

C4.1

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Drawn: 06F158-006 CD





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Issue Date: 06-15-20

Sheet: 1



BUTLER COUNTY COMMENTS

Date 08-05-20 Df JSB

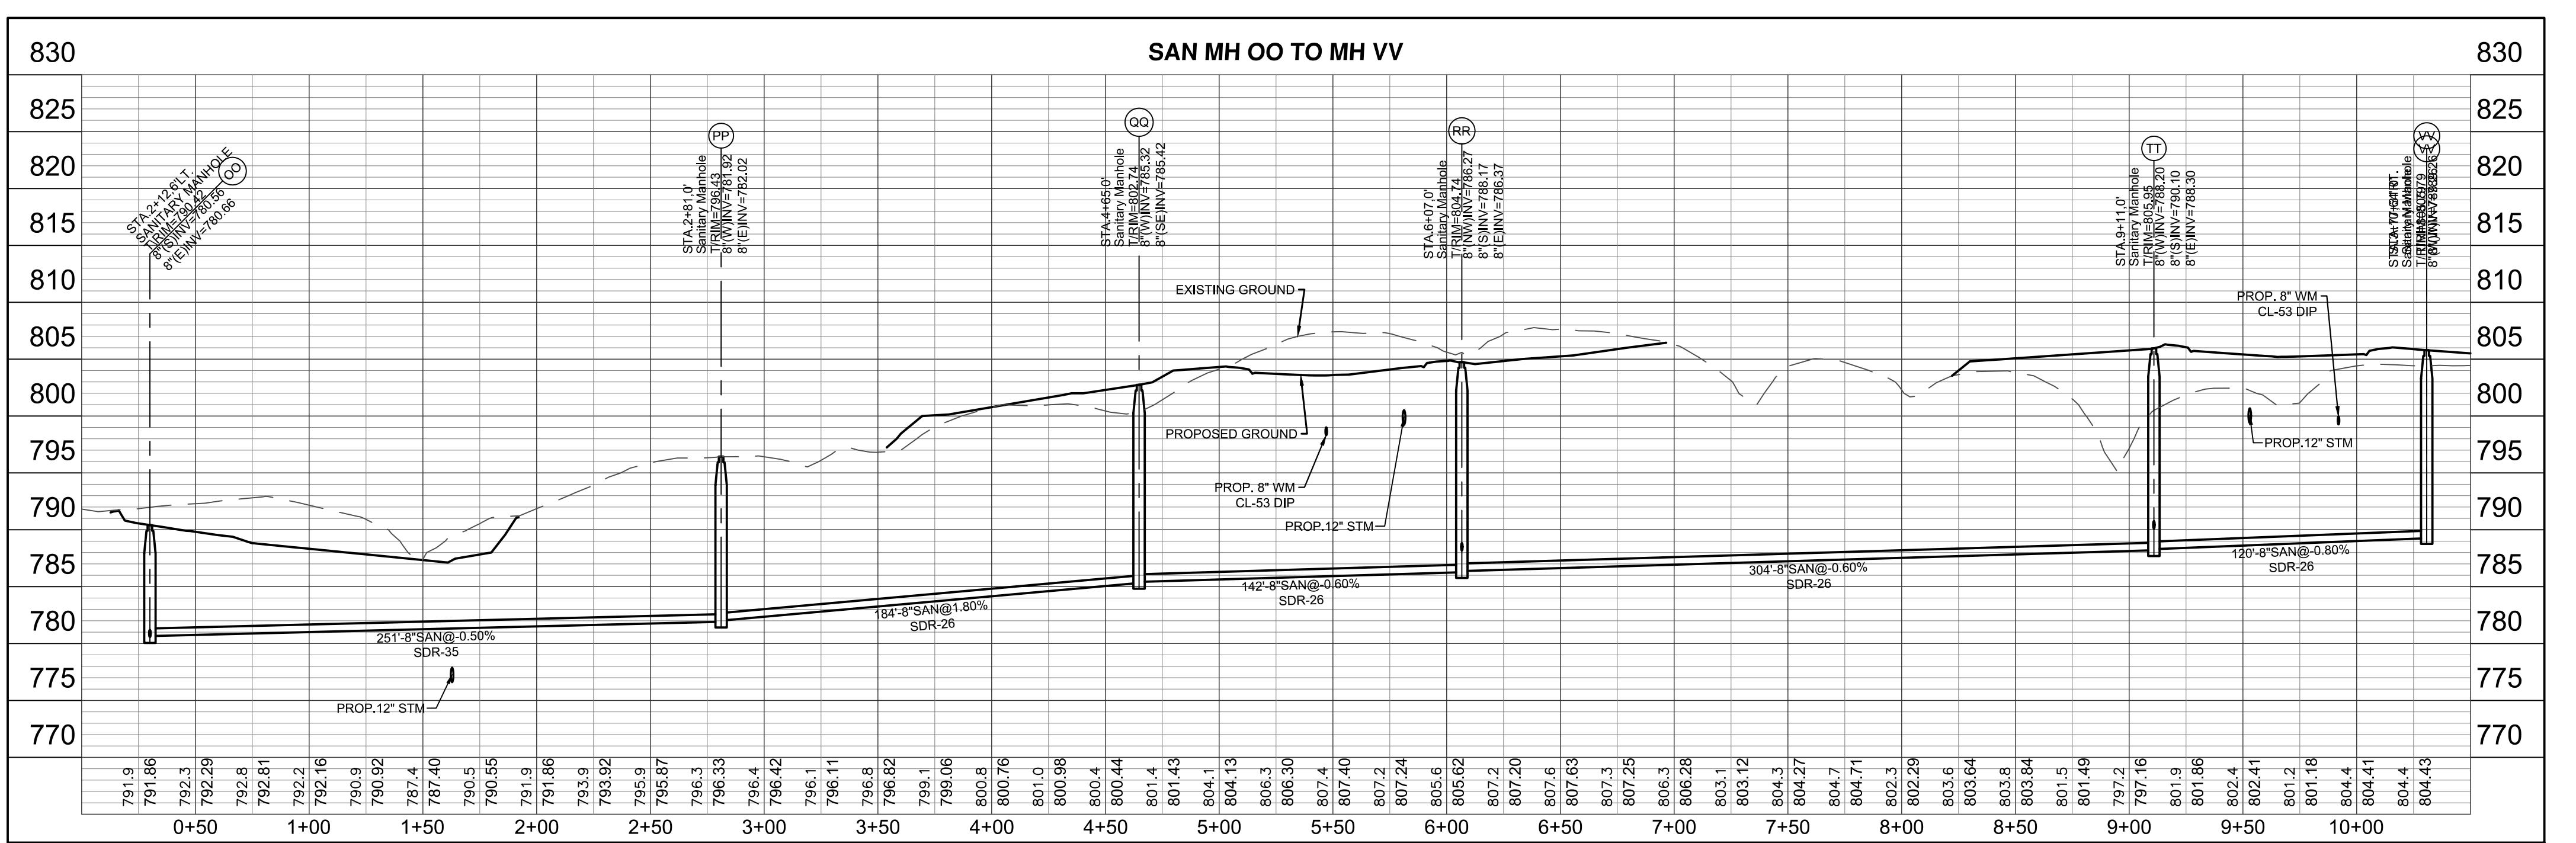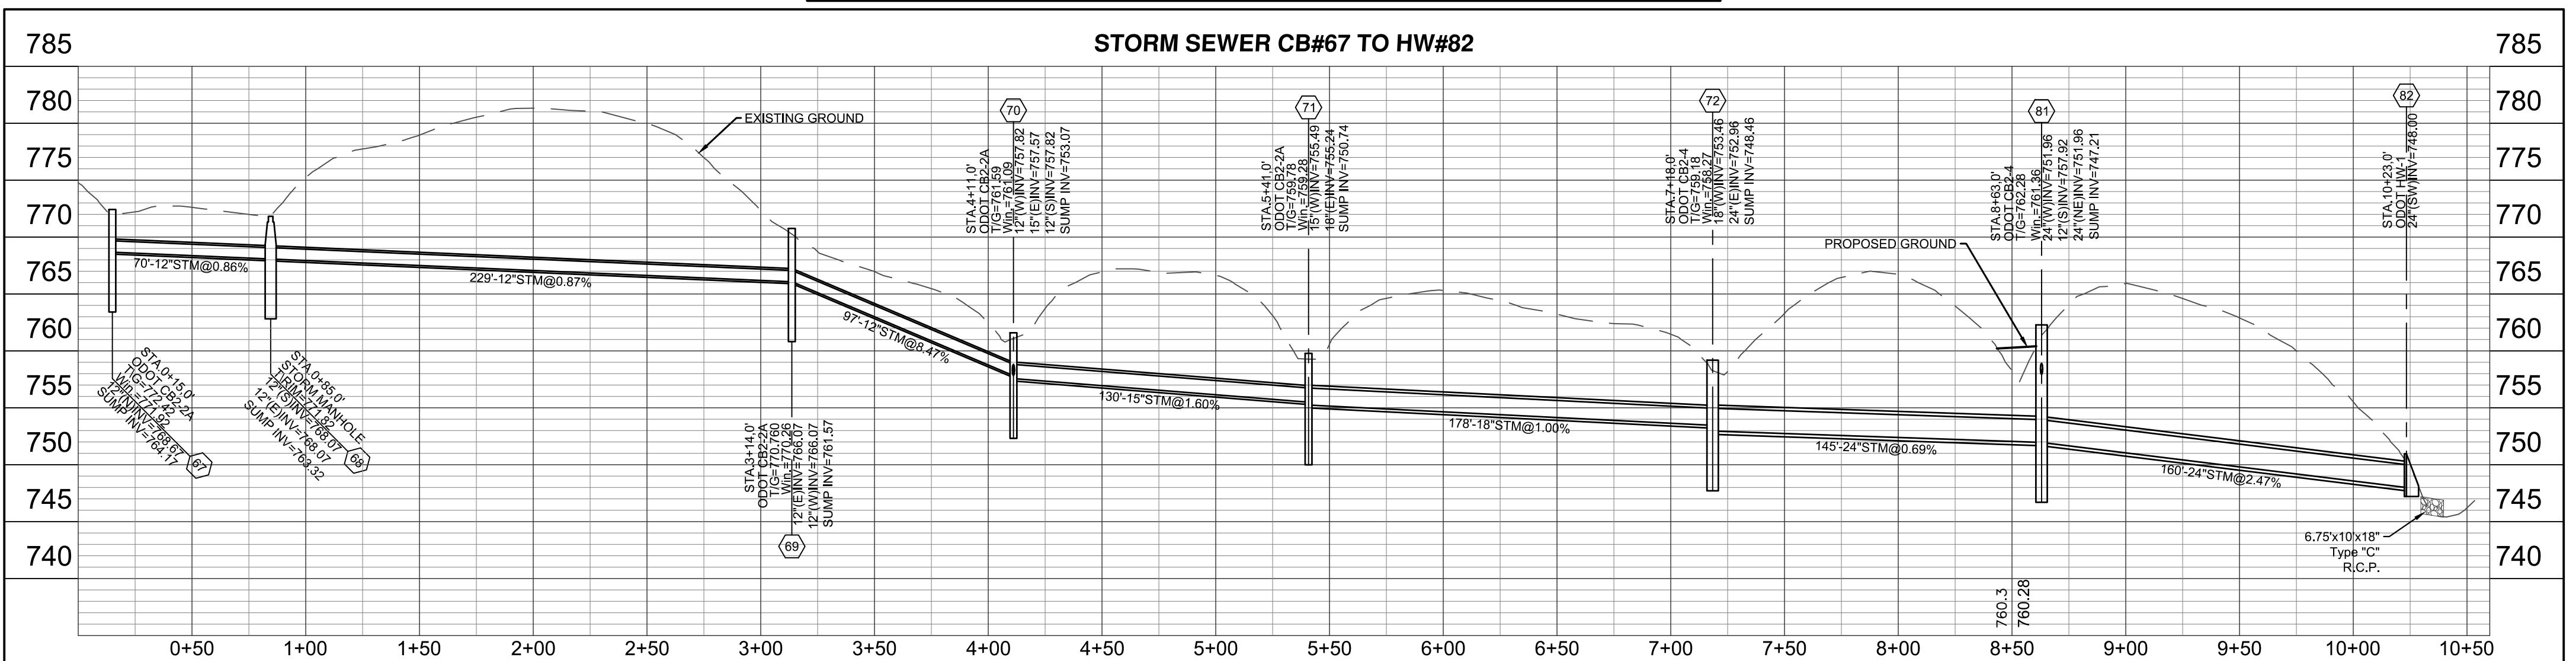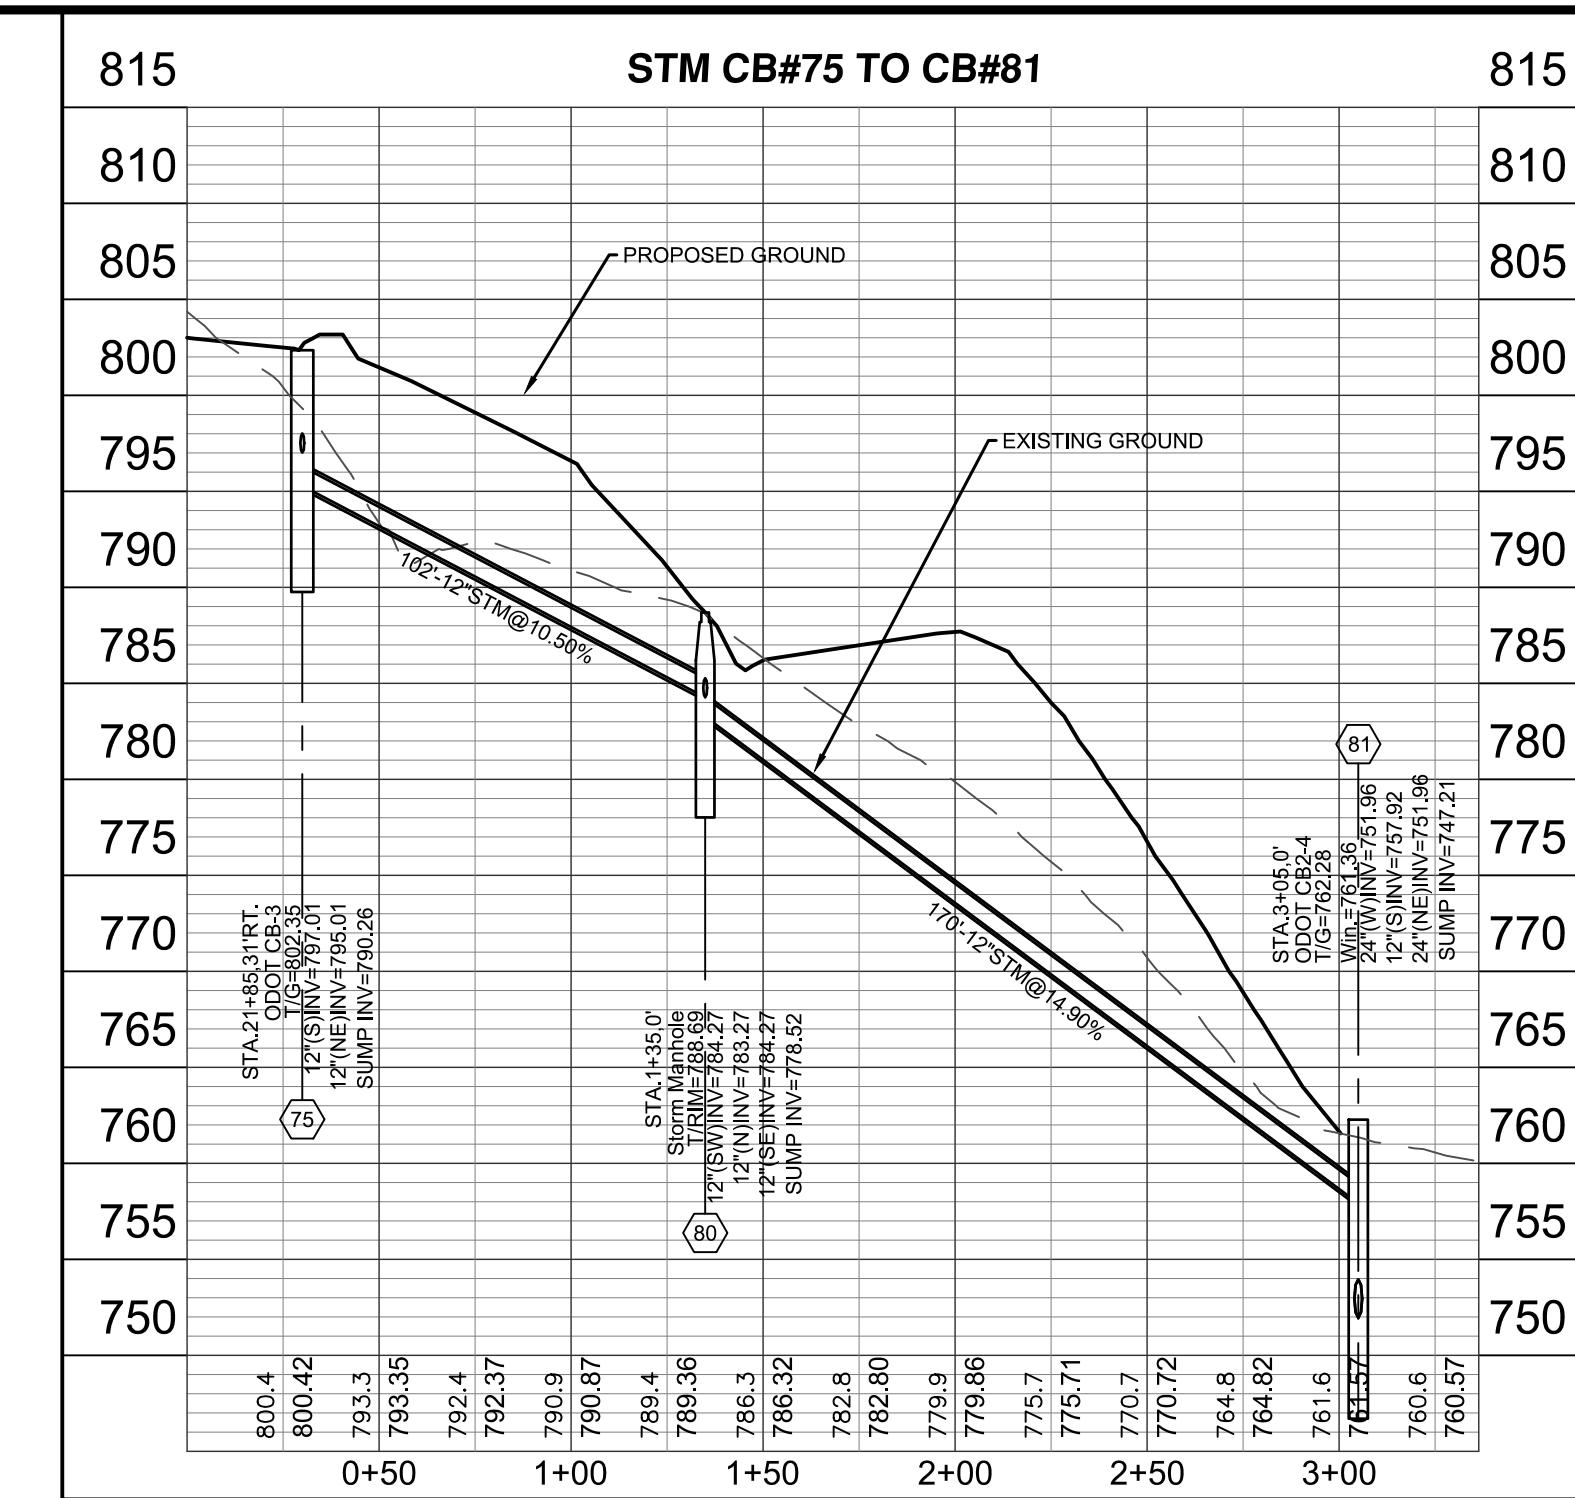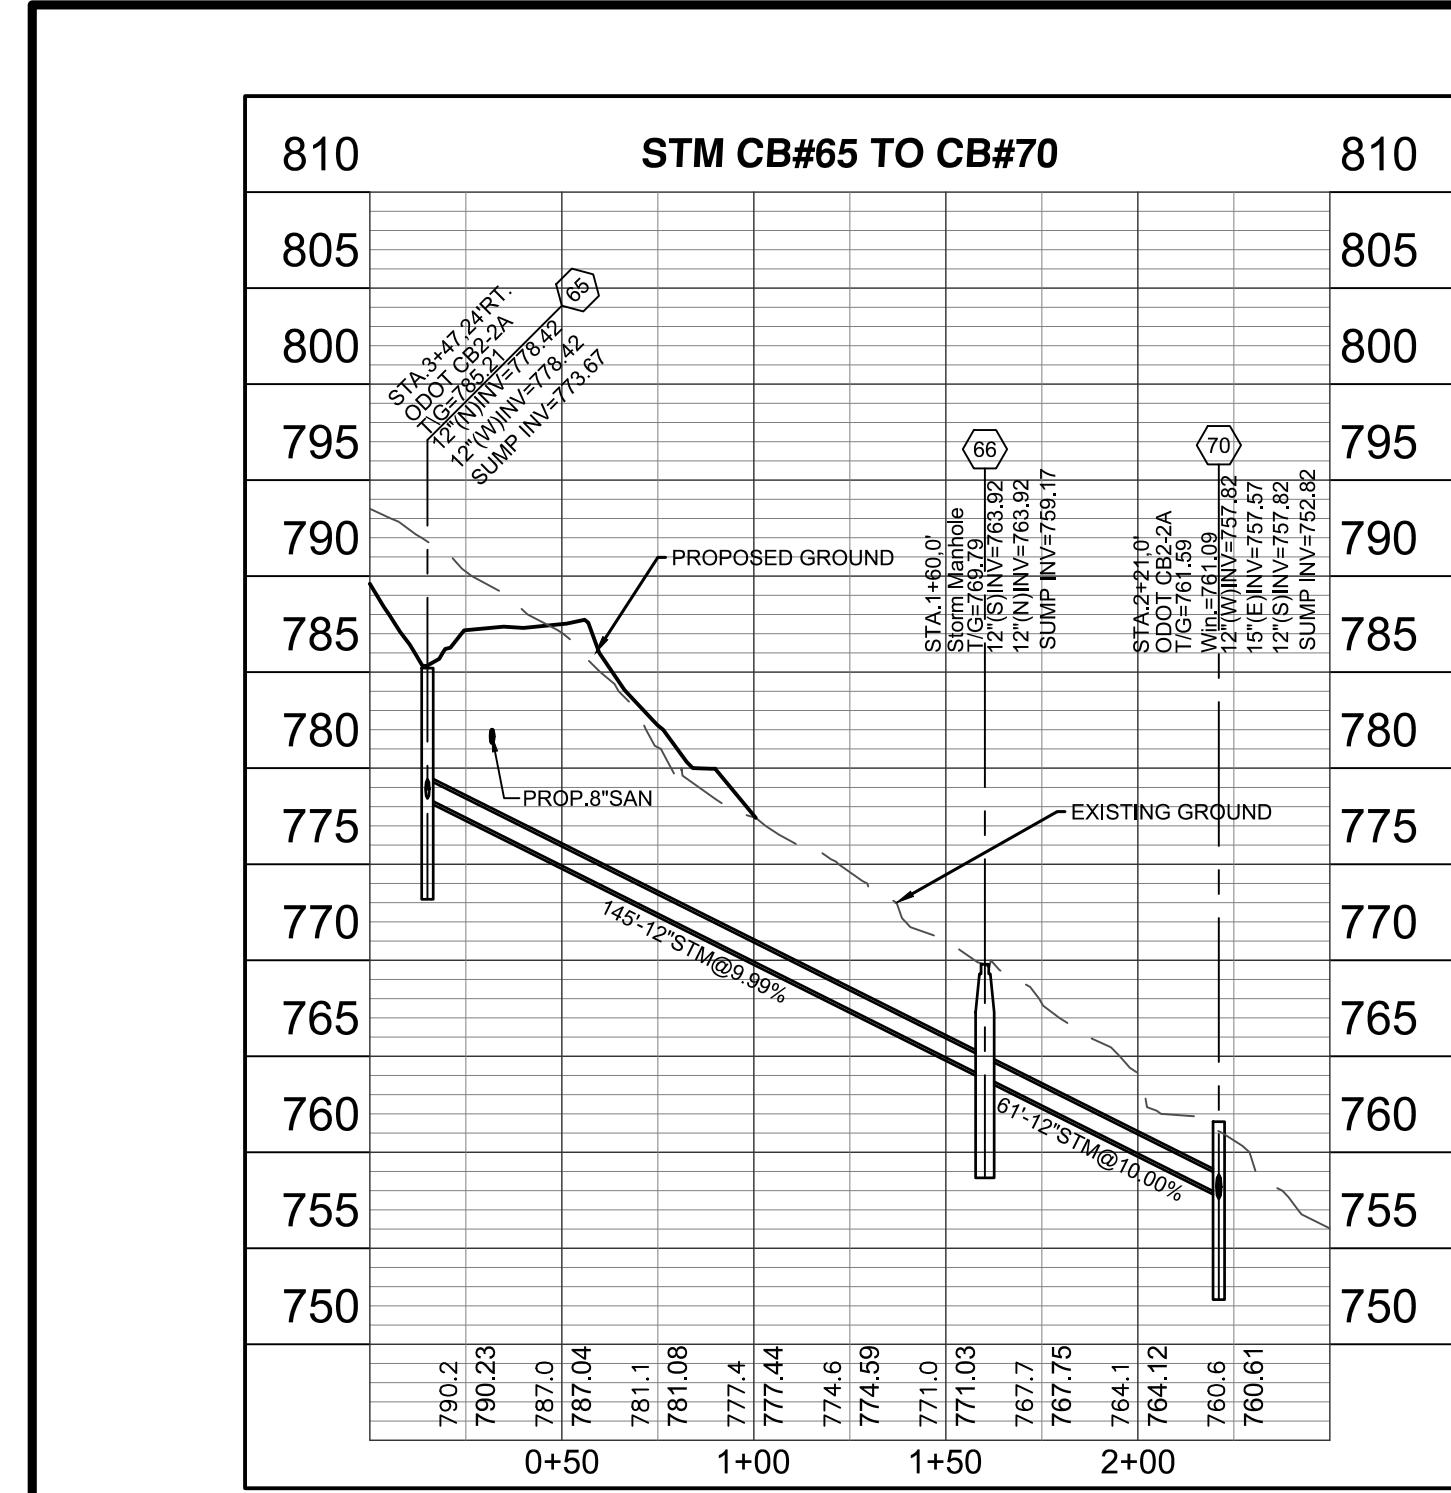

GRAPHIC SCALE
 (HORIZONTAL)
 1 inch = 50 ft.

TYPICAL SKIMMER DEWATERING DEVICE

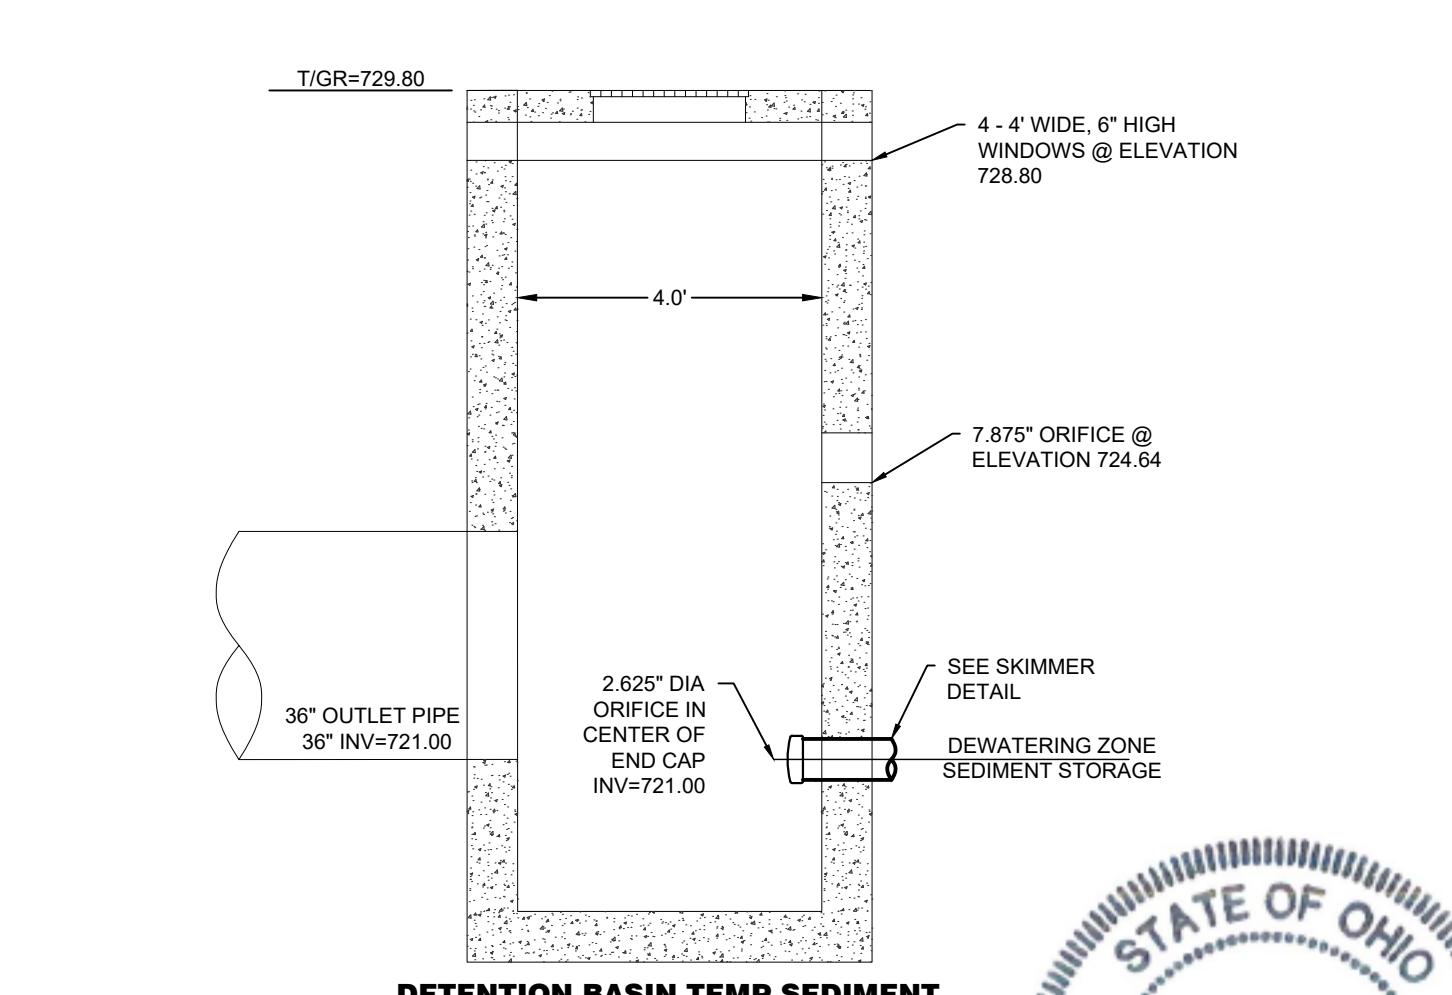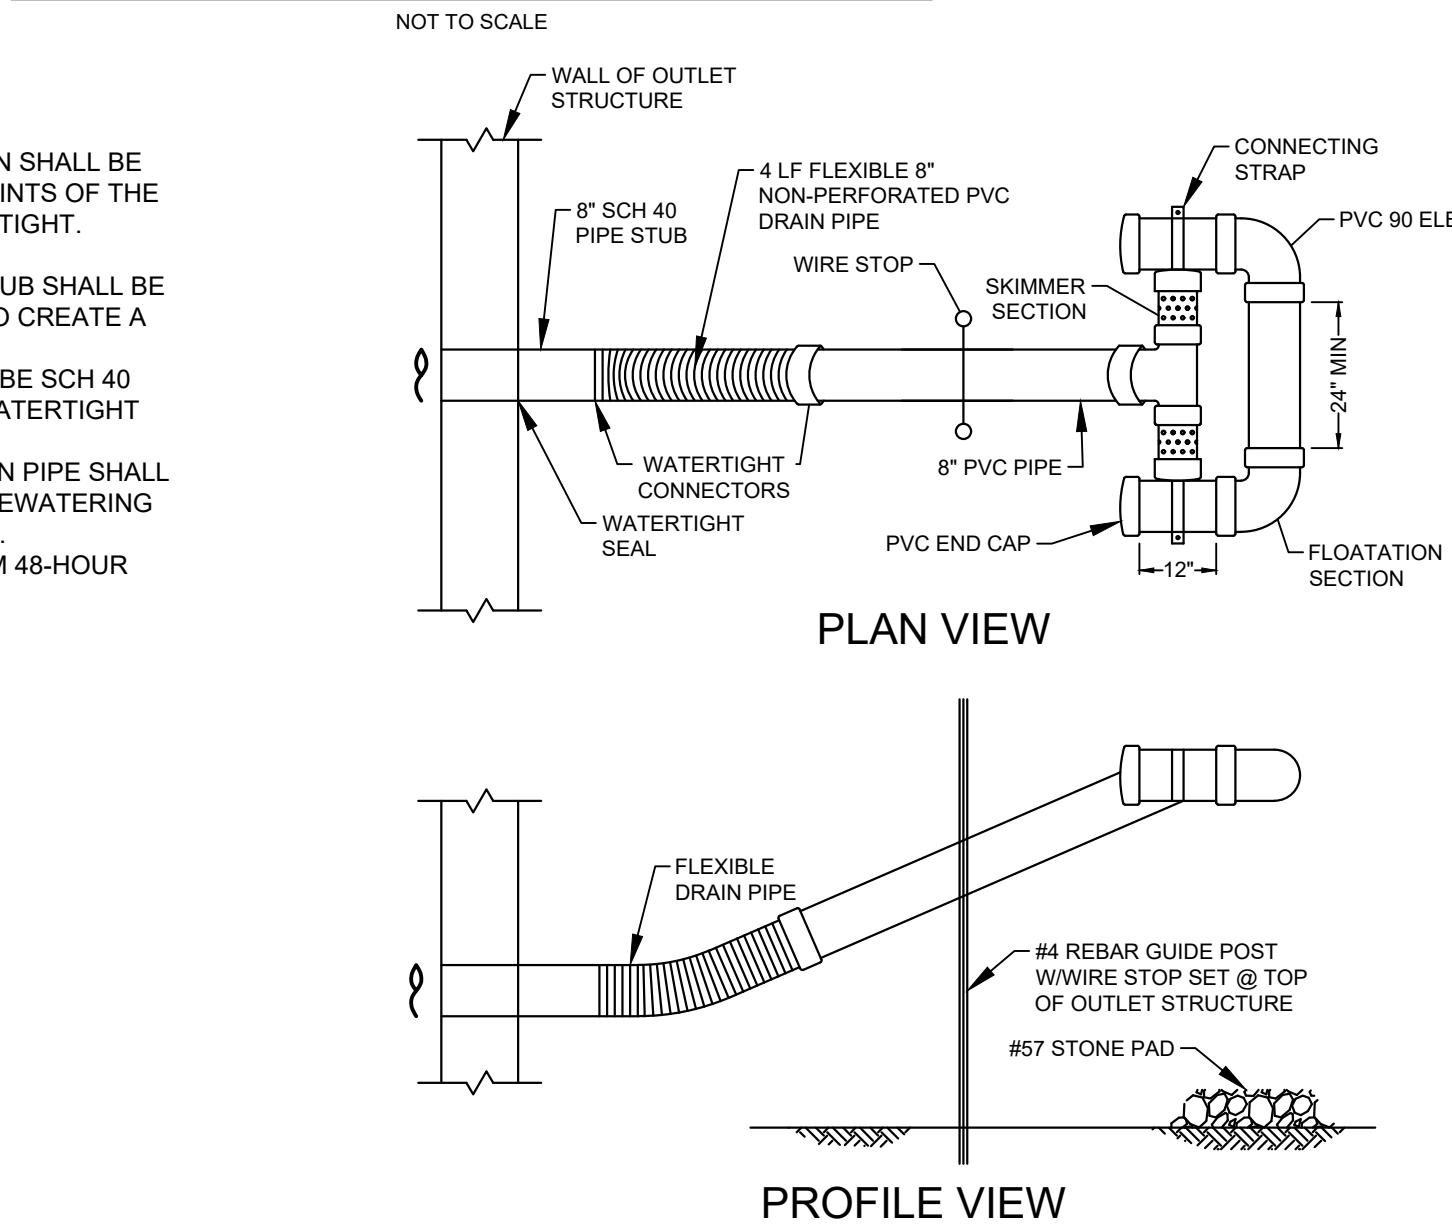

DETENTION BASIN TEMP SEDIMENT
RETROFIT (STR #84)

O.D.O.T.CB-2.4

Item 1 REVISED PER ZONING COMMENTS


2 BUTLER COUNTY COMMENTS

3



THE OAKS OF WEST CHESTER SECTION SIX (PHASES 5, 6, & 7)

UTILITY PROFILES

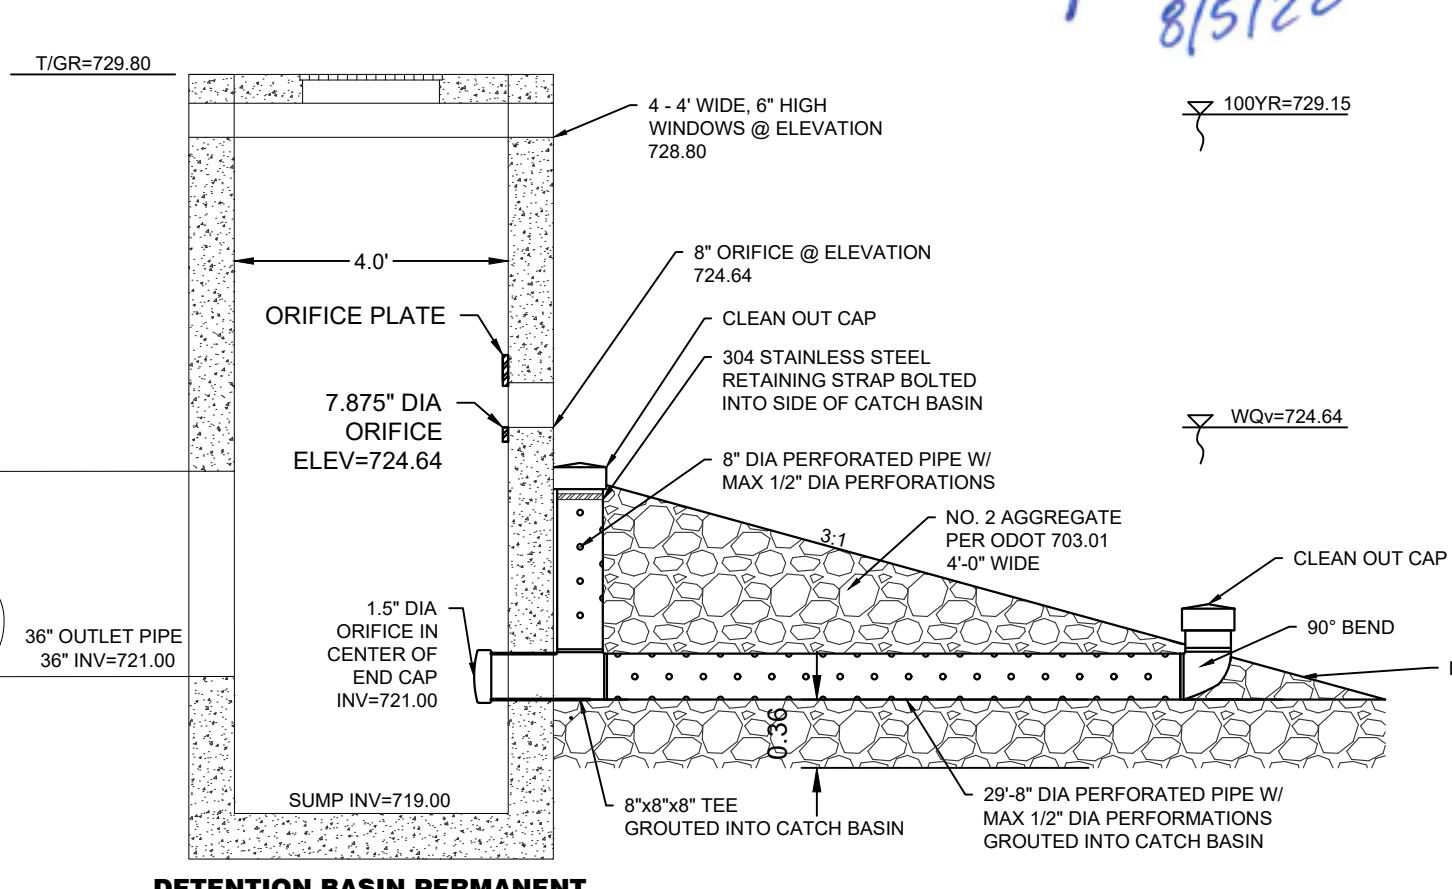

DETENTION BASIN PERMANENT
OUTLET STRUCTURE DETAIL (STR #84)

O.D.O.T.CB-2.4

Item 1 REVISED PER ZONING COMMENTS





2 BUTLER COUNTY COMMENTS

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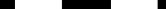
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 Drawn by: LDF
 Checked By: JSD
 Issue Date: 06-15-20
 Sheet: C4.2

Plot time: Aug 05, 2020 - 10:10am
Drawing name: J:\2006\06F158-006\CV\DWG\06F158-006 CD.dwg - Layout Tab: C4.3 PROFILE & INT DETAILS


DETAILS

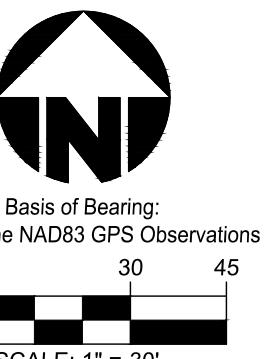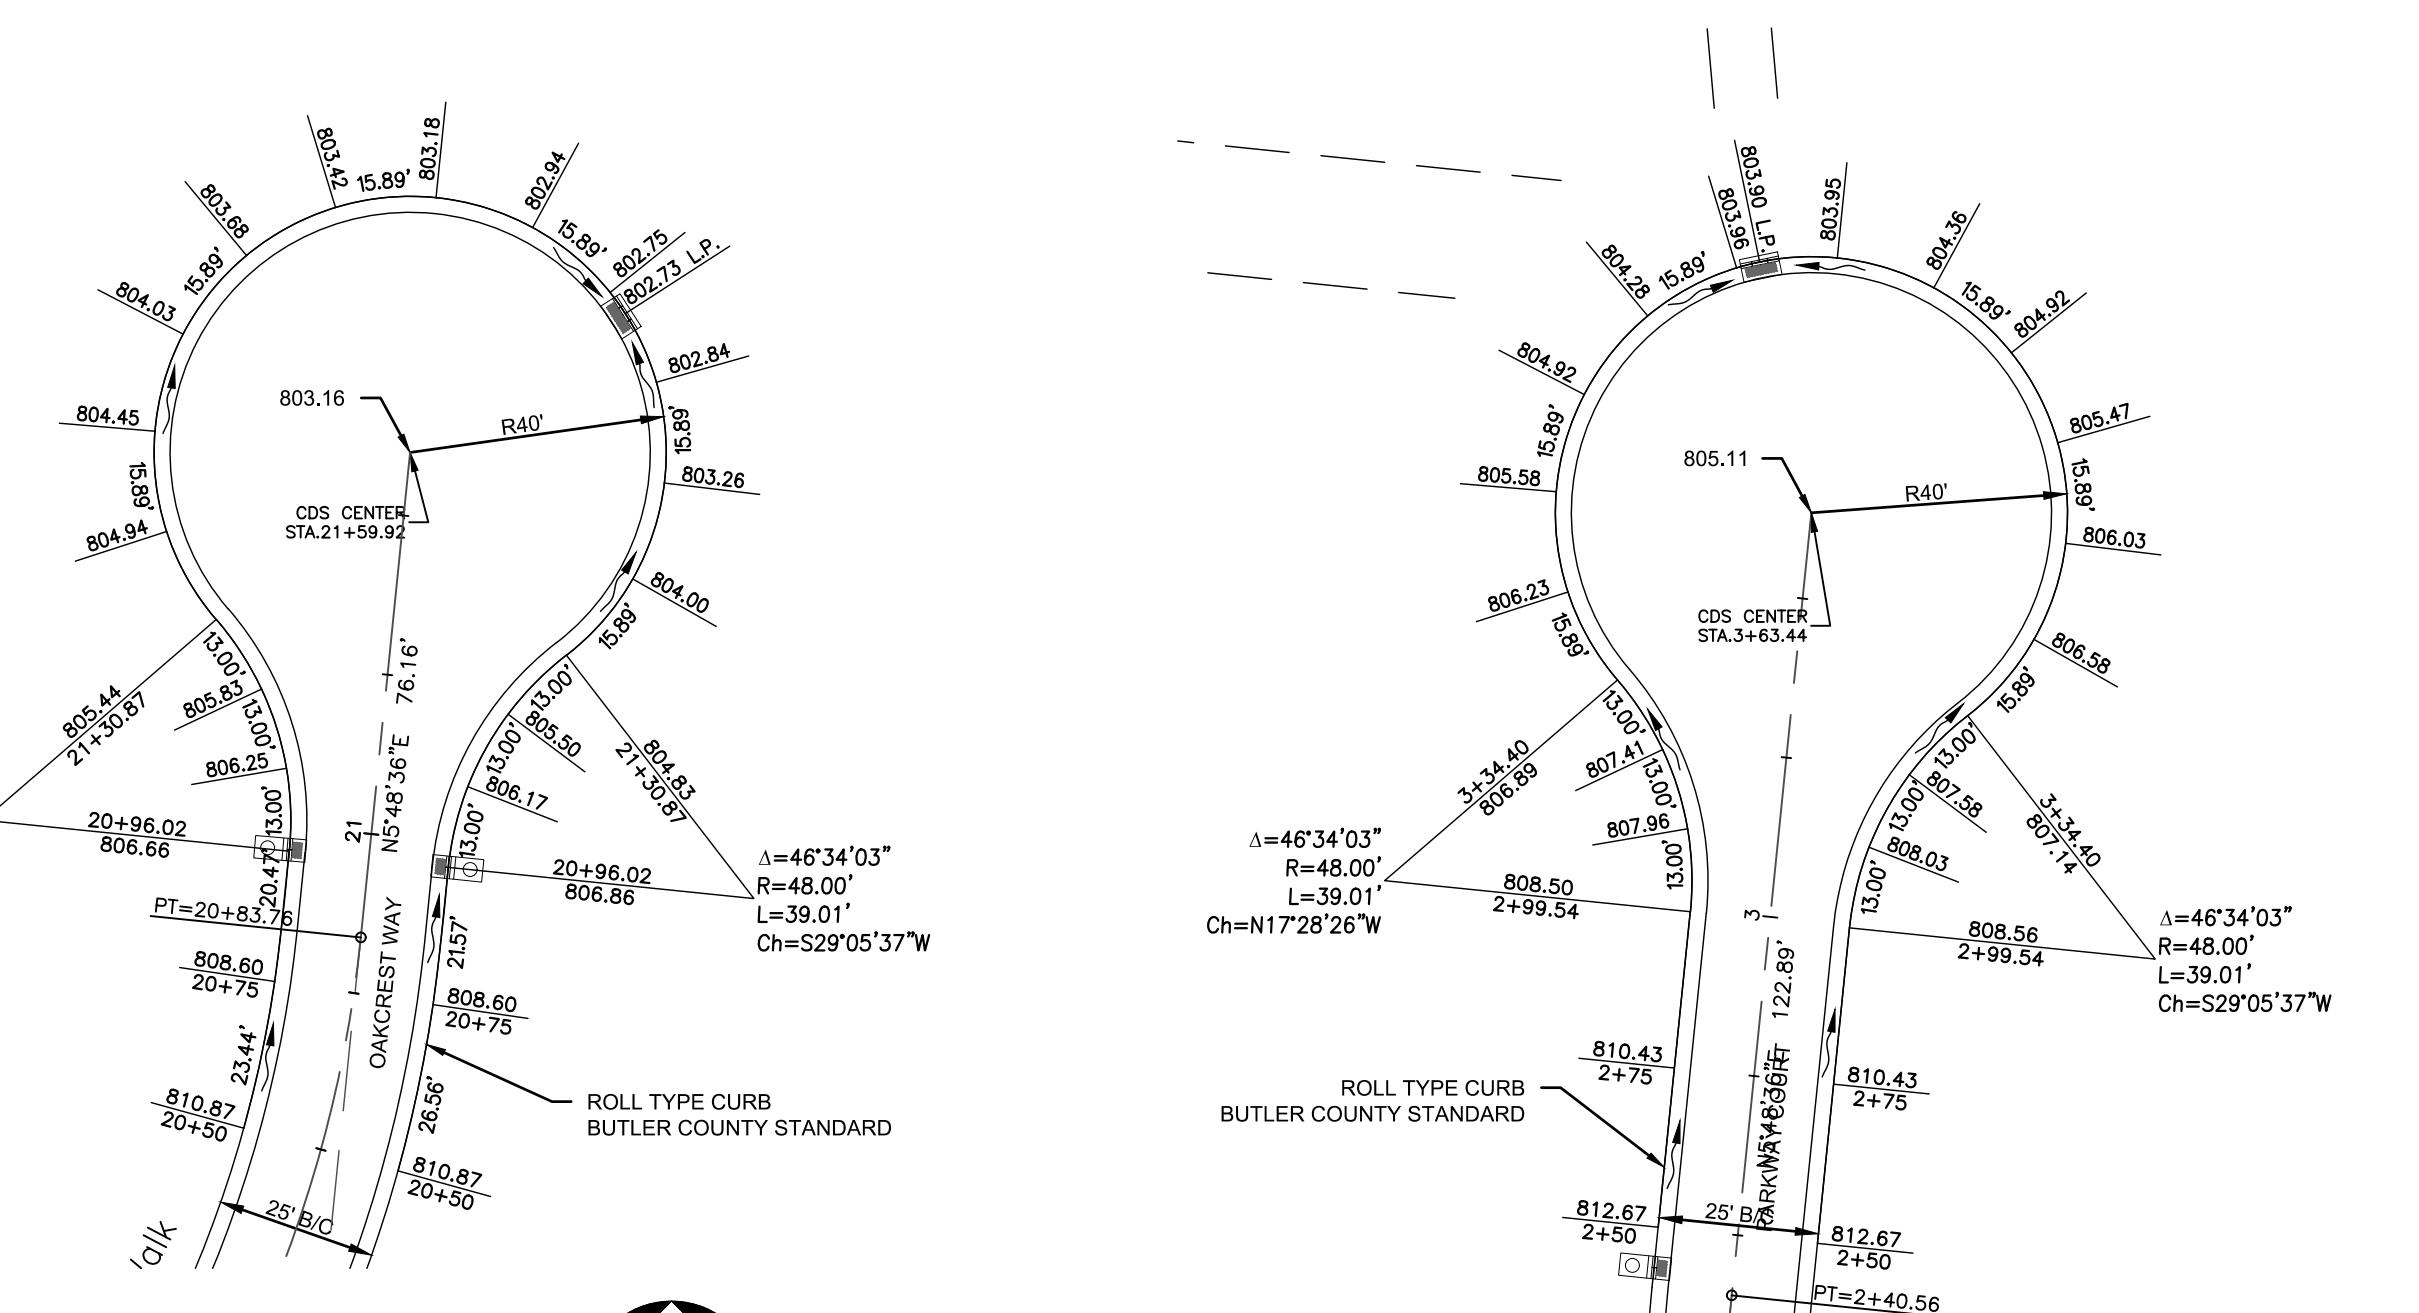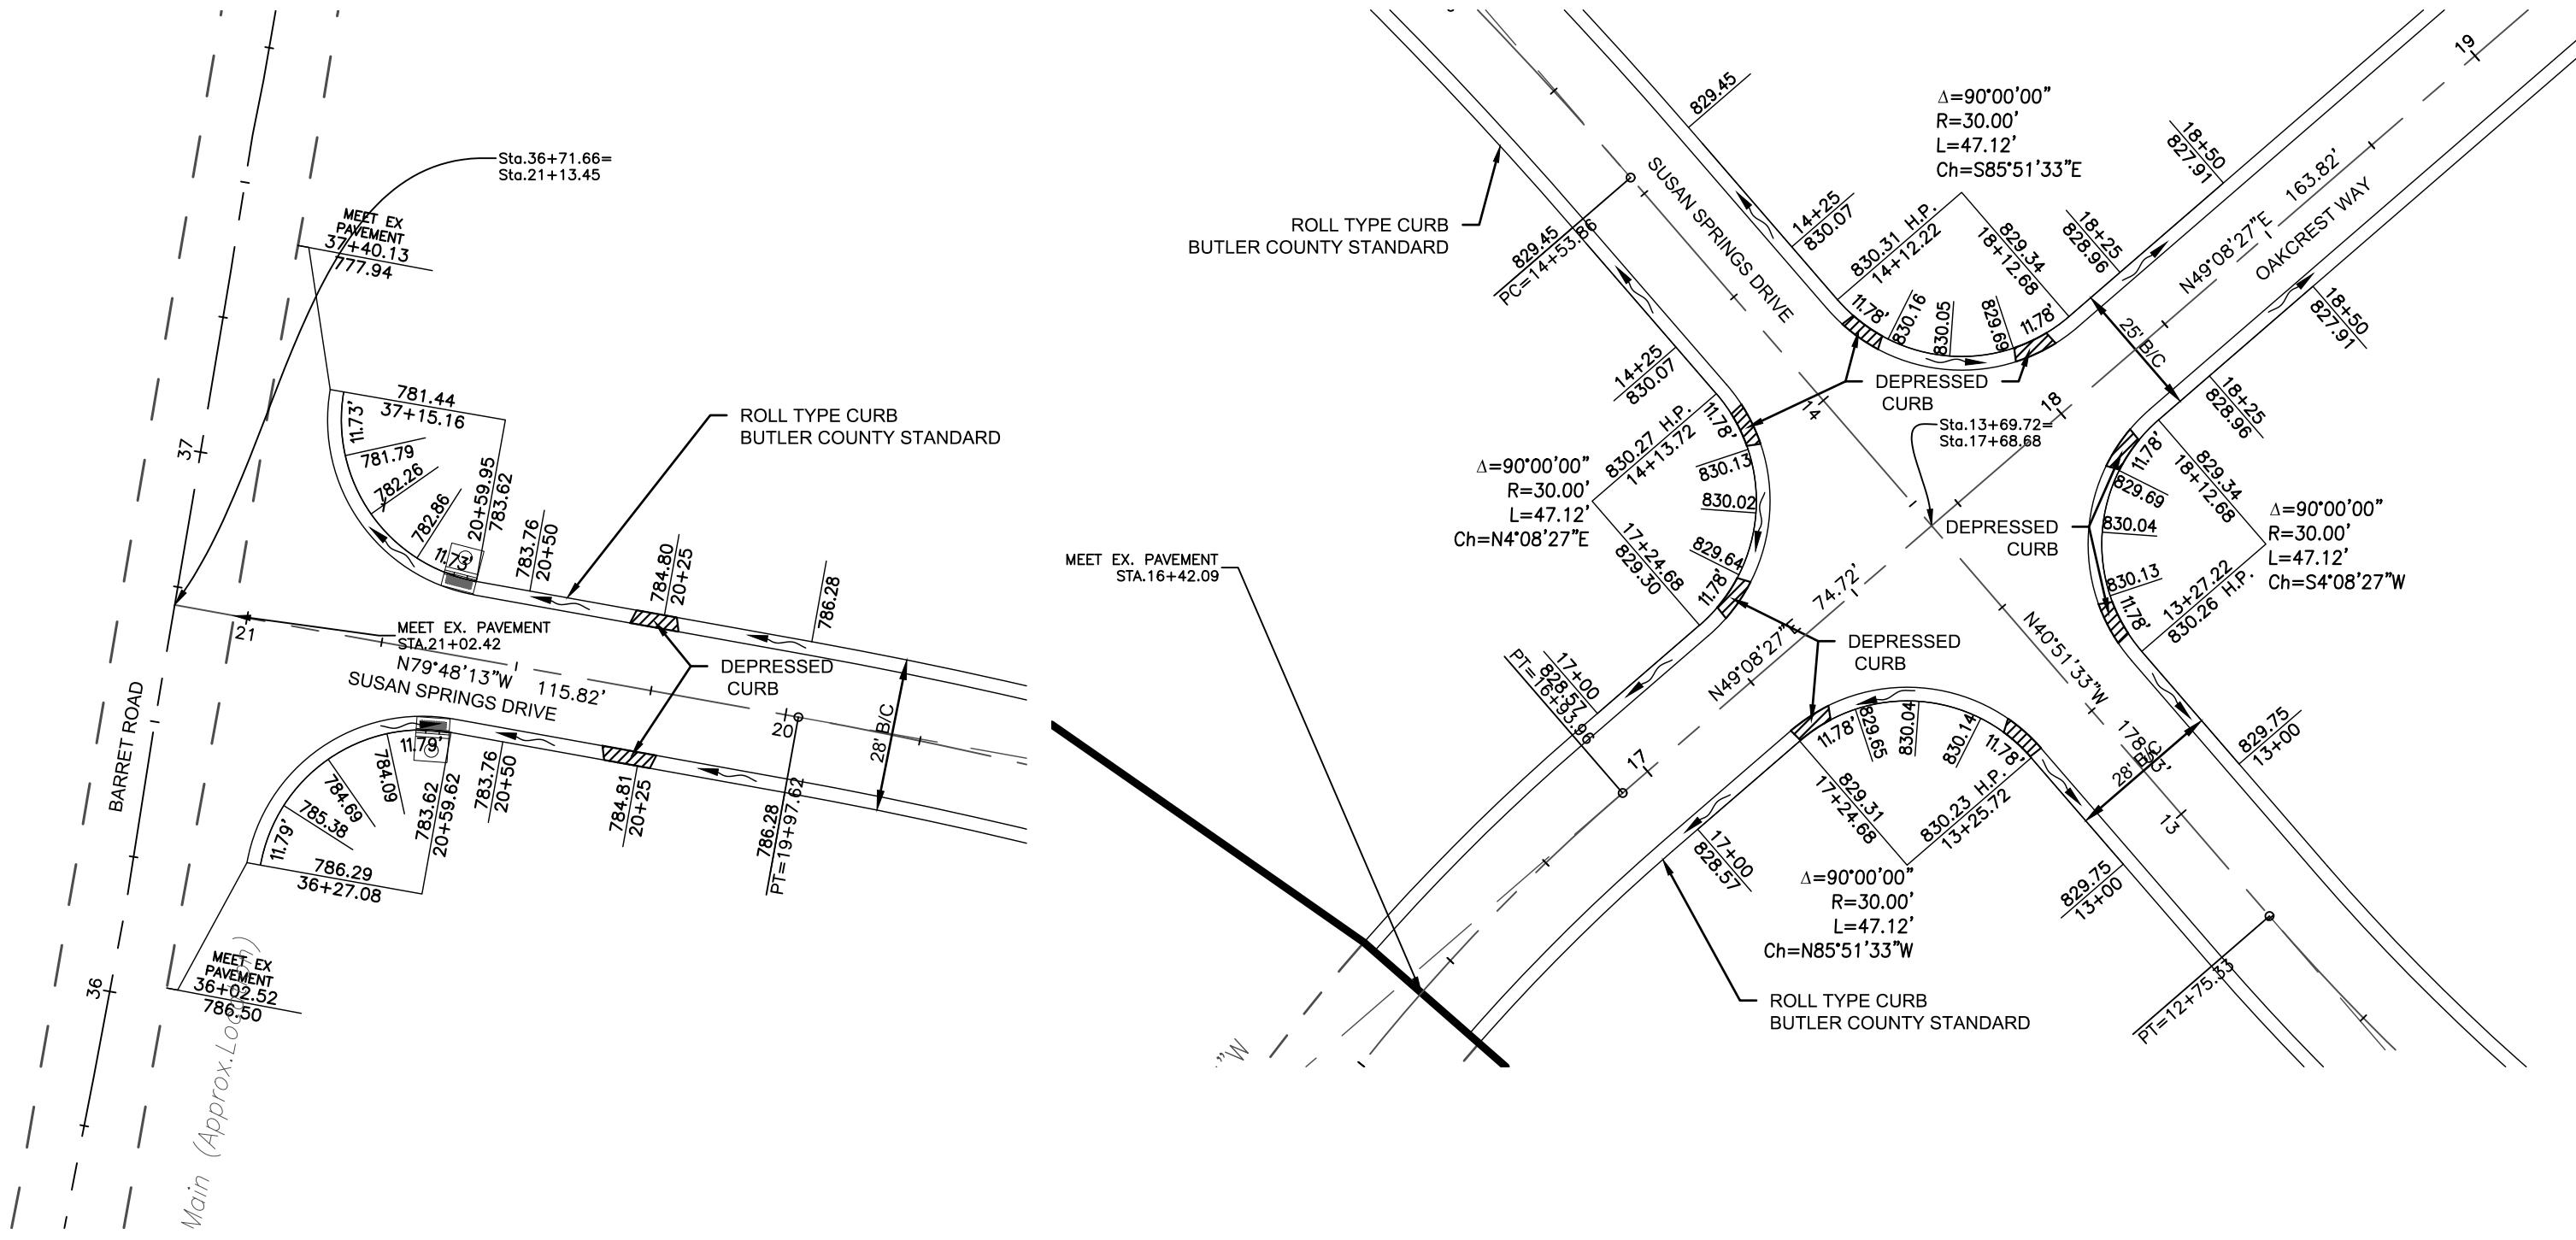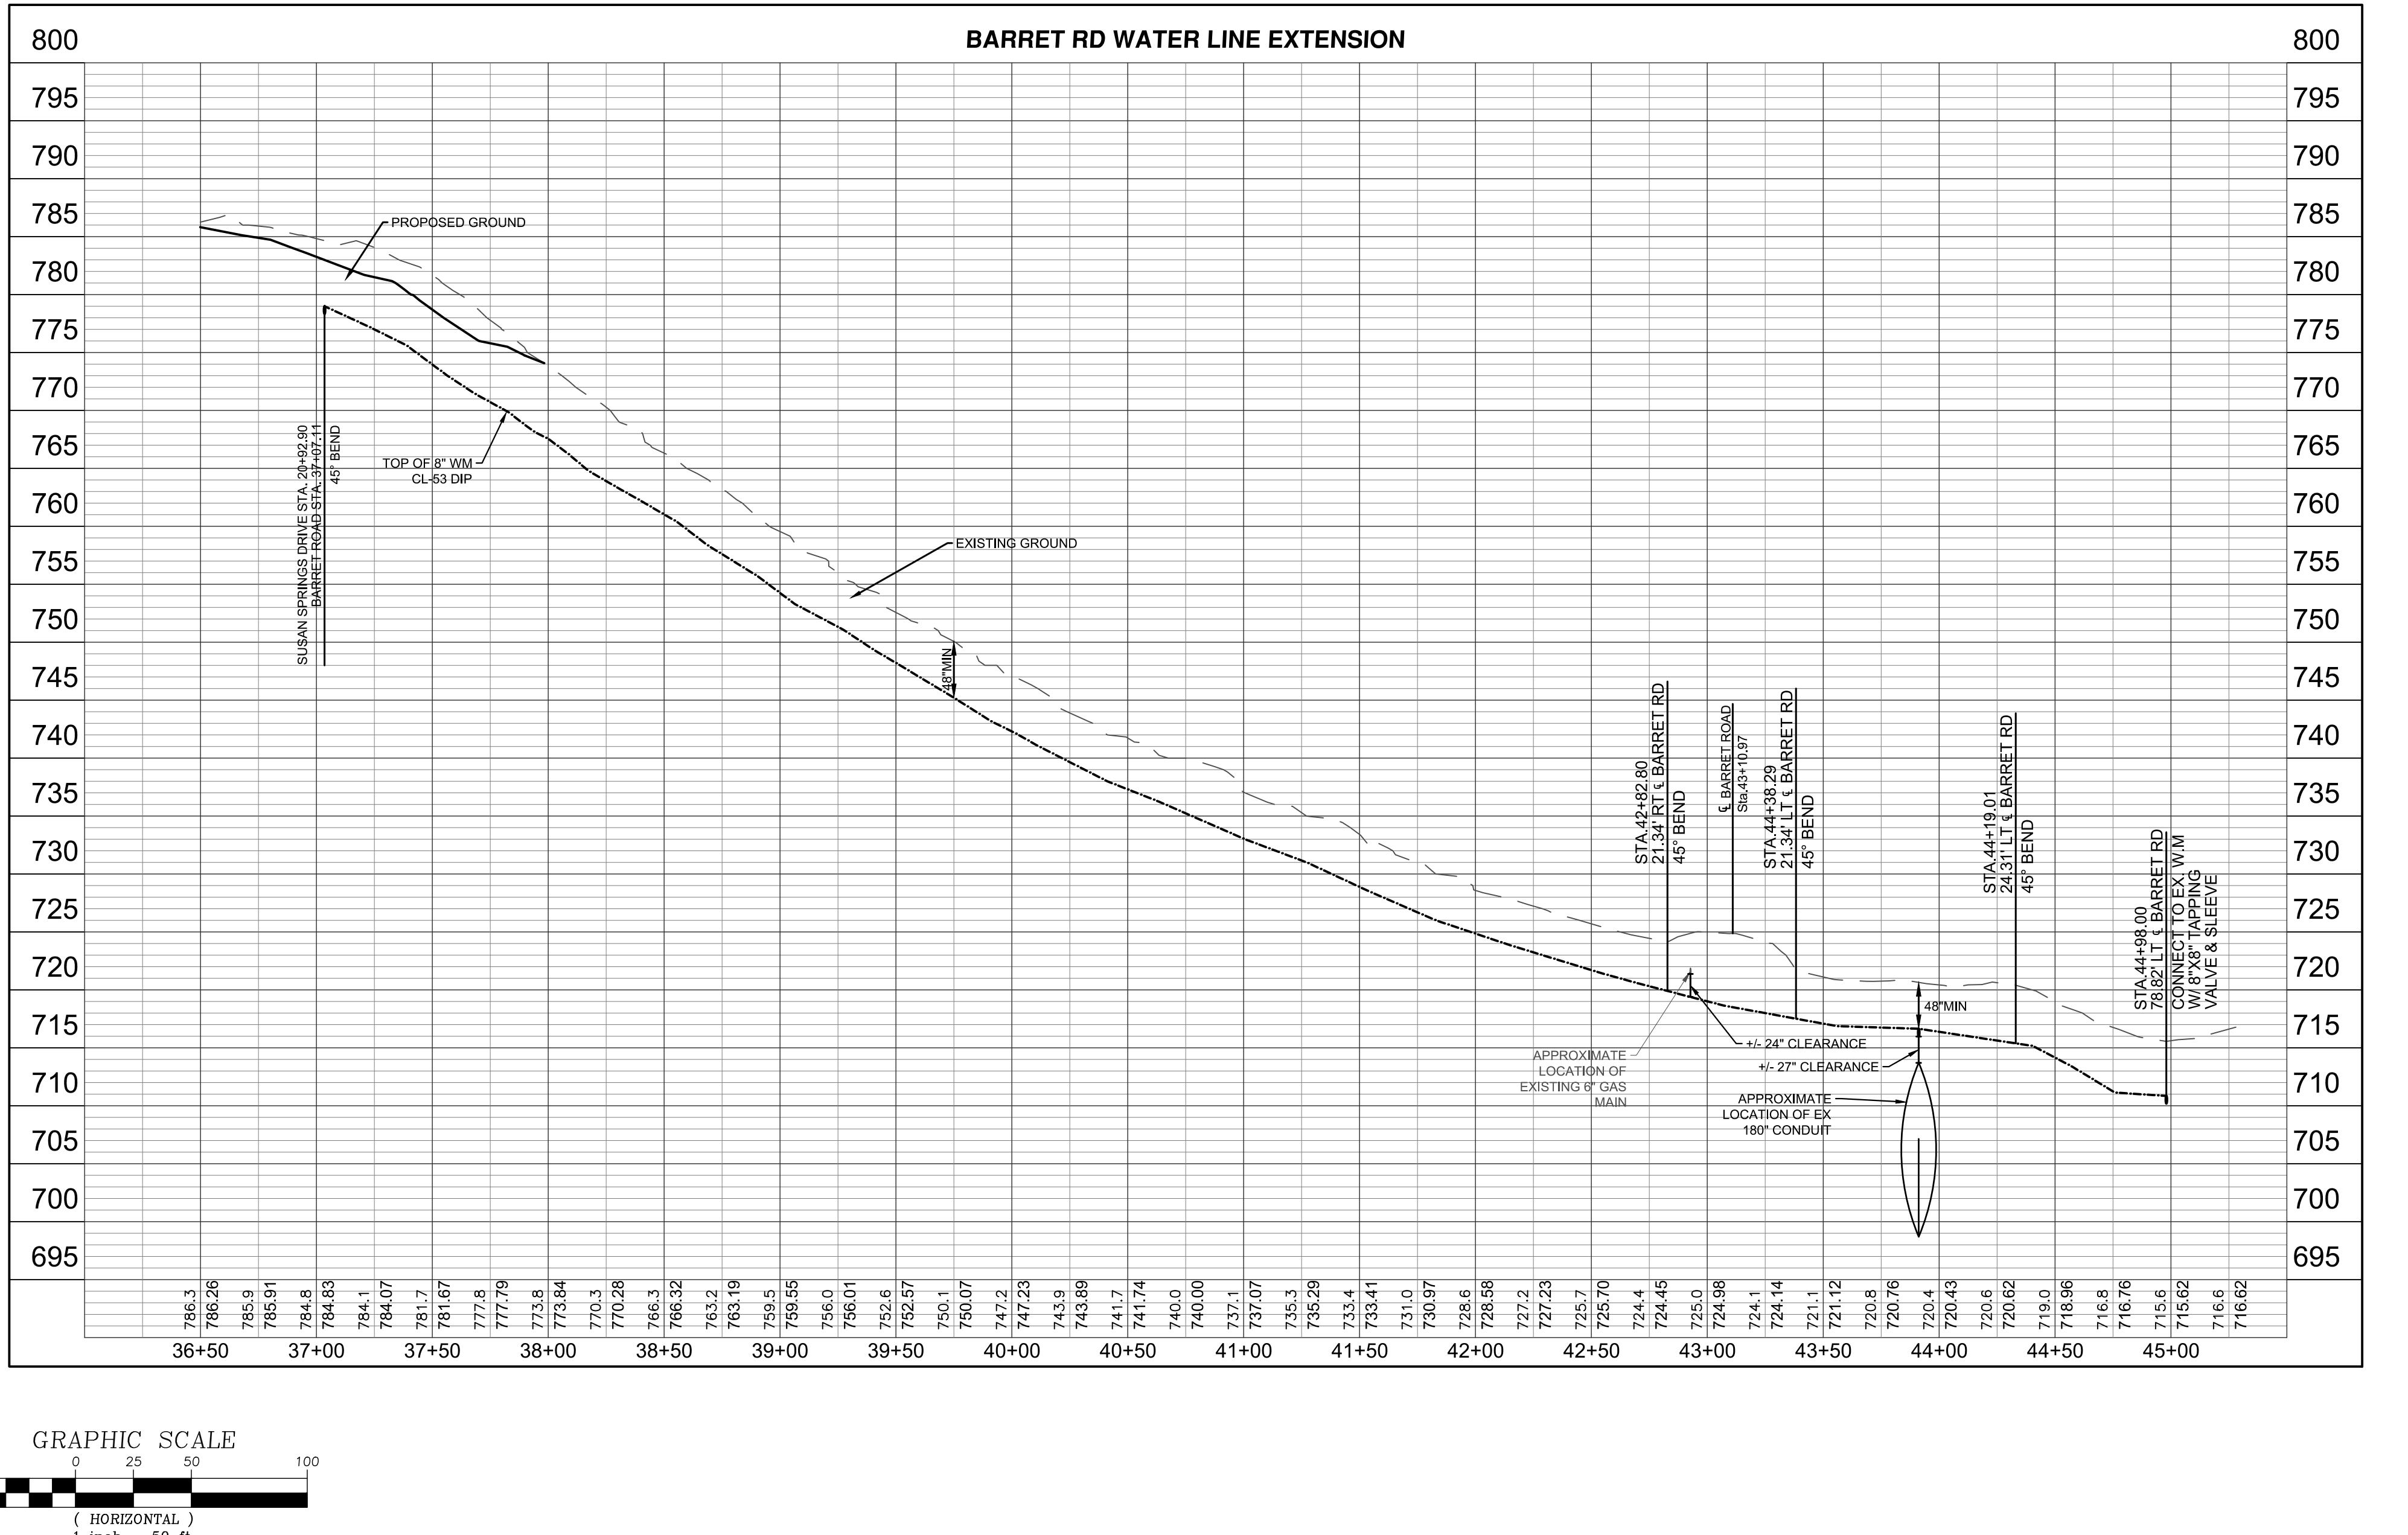

Basis of Bearing:
State Plane NAD83 GPS Observations



SCALE: 1" = 30'

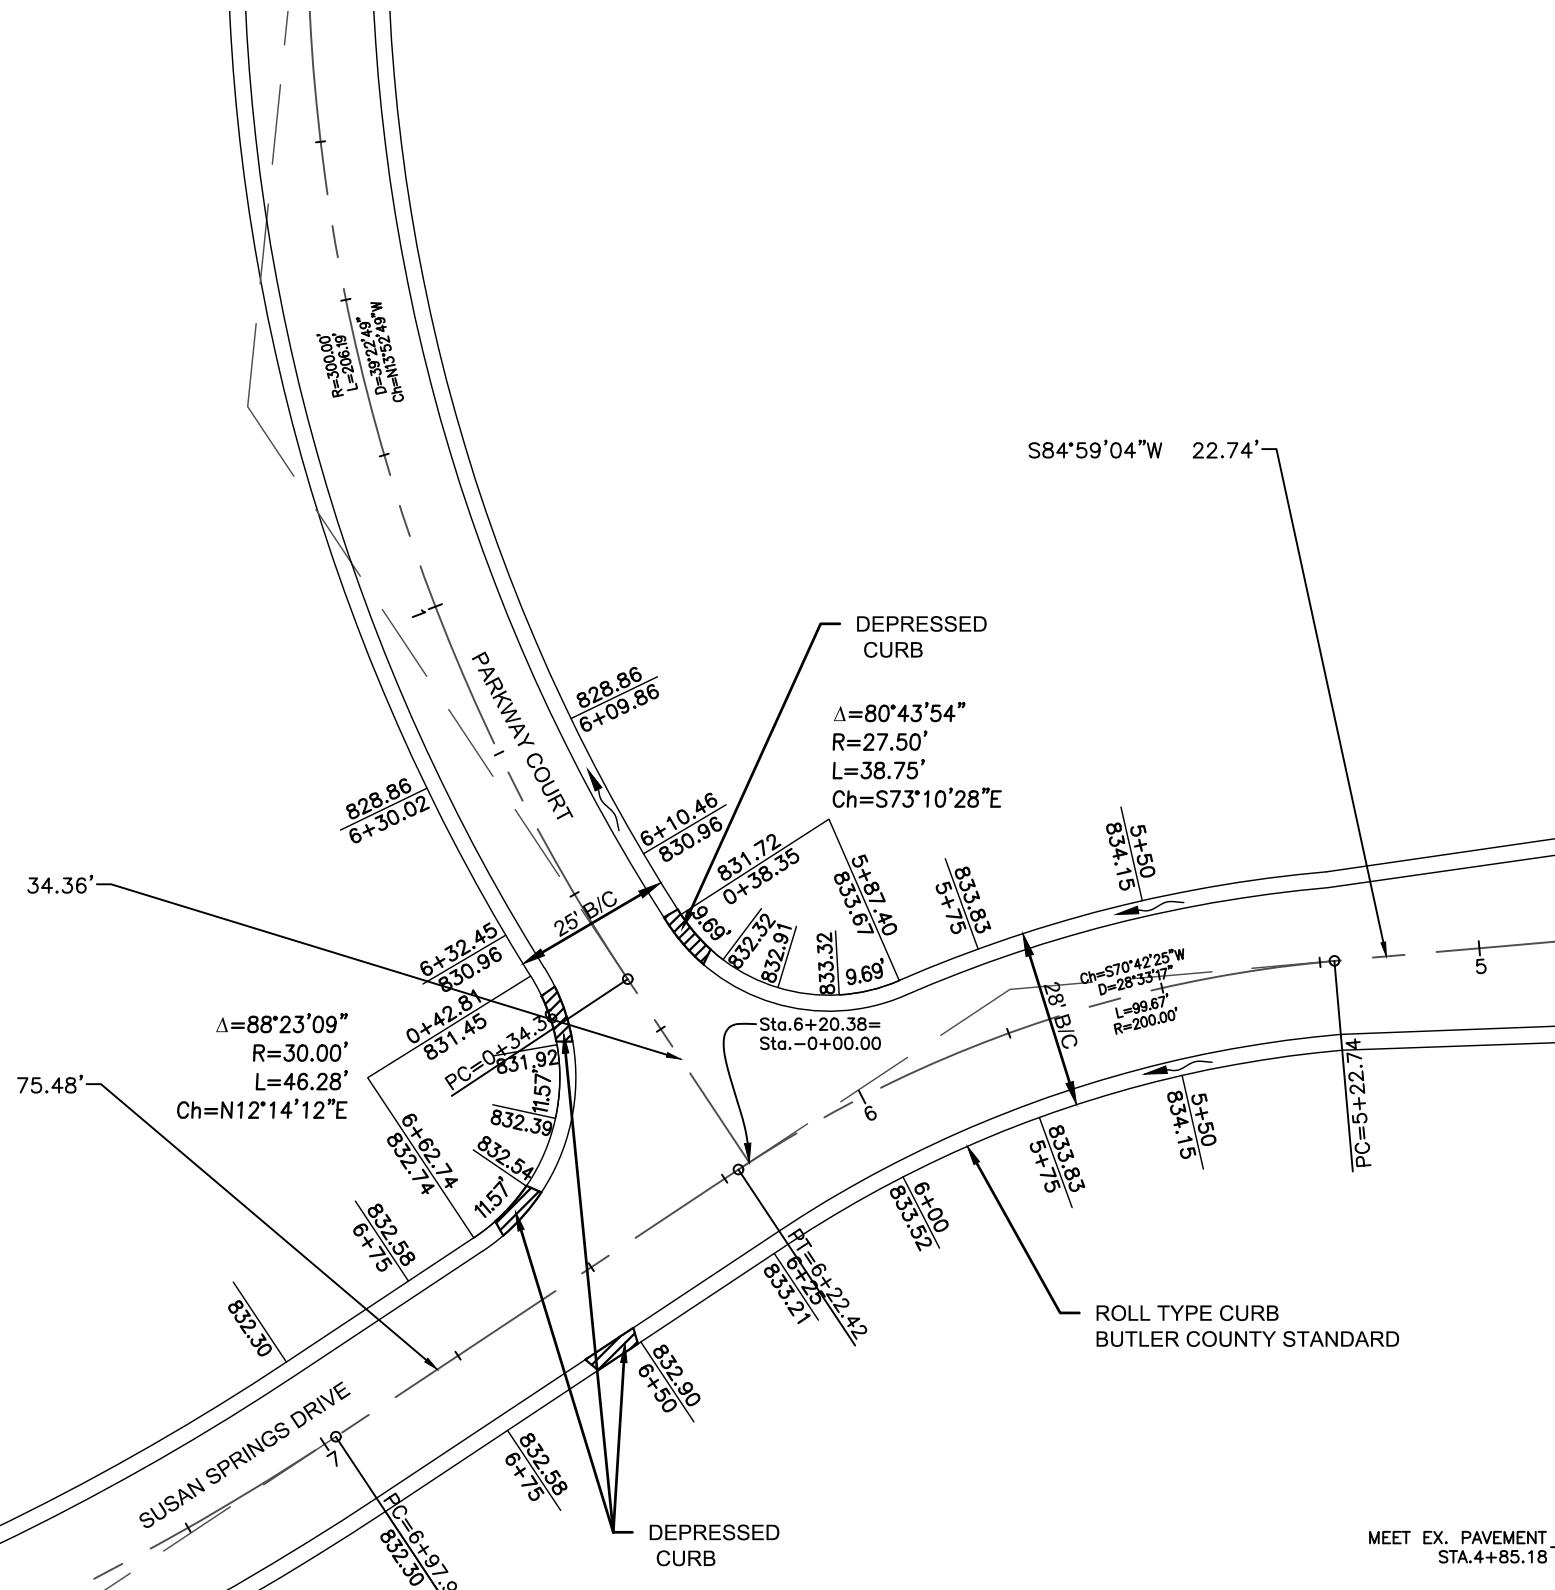

BARRET RD WATER LINE EXTENSION

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THE OAKS OF WEST CHESTER SECTION SIX (PHASES 5, 6, & 7)

SECTION 22 TOWN 2 RANGE 2

UTILITY PROFILES & INTERSECTION DETAILS



John D. Delaney
8/5/20


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Drawing:	06F158-006 CD
Drawn by:	LDF
Checked By:	JSD
Issue Date:	06-15-20
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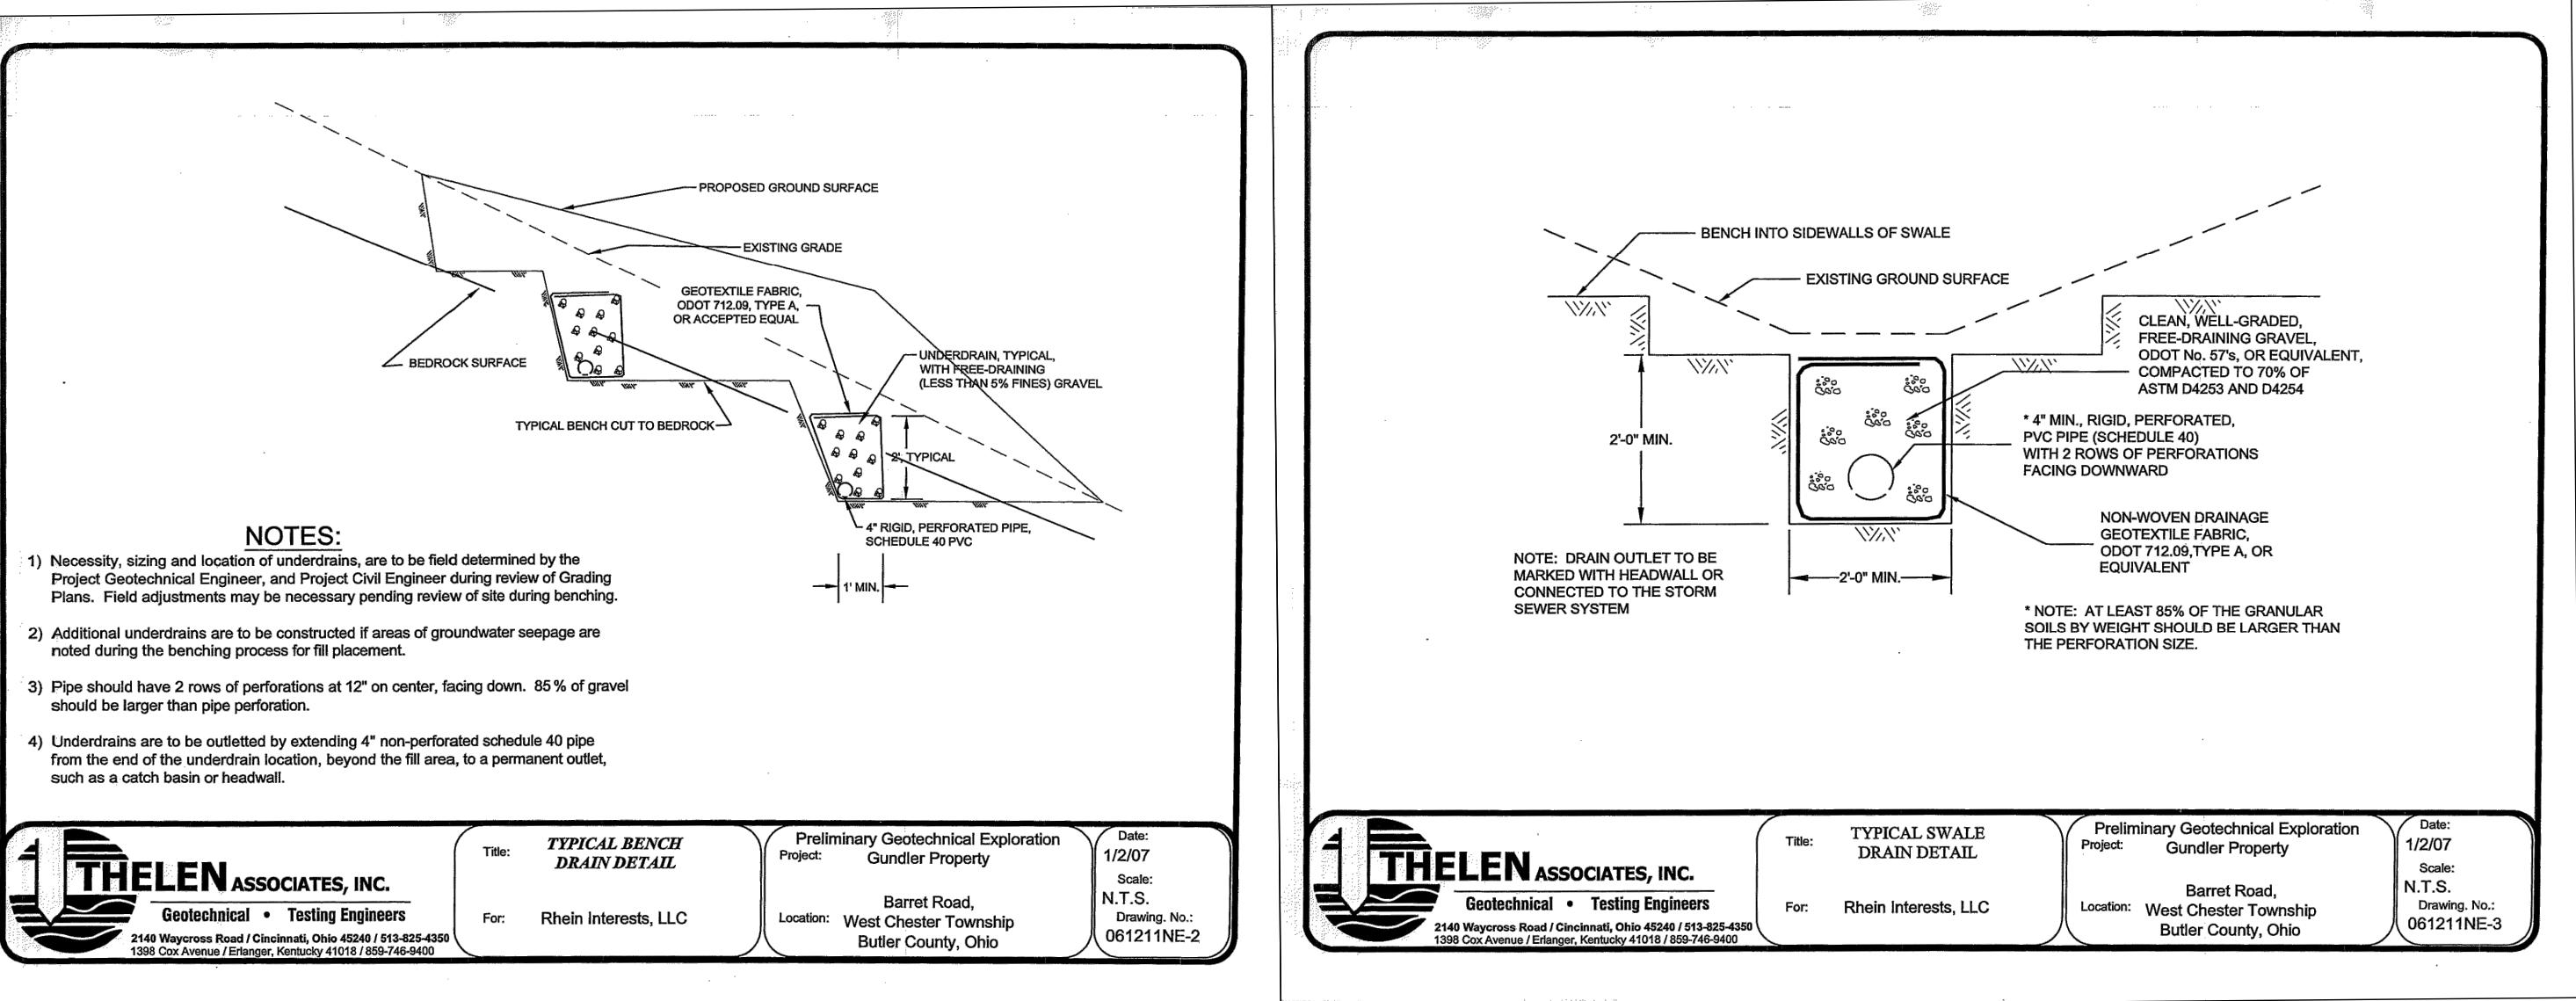


GRADING NOTES

- LOCATION OF EXISTING UTILITIES TO BE DETERMINED IN THE FIELD PRIOR TO BEGINNING WORK.
- THE GRADING PLAN IS TO BE USED FOR GRADING PURPOSES ONLY.
- CONTRACTOR SHALL OBTAIN A COPY OF THE COMPLETE GEOTECHNICAL REPORT PREPARED BY THELENE ASSOCIATES, INC. DATED JANUARY 3, 2007 AND ALL ADDENDUMS PRIOR TO BIDDING THE PROJECT.
- CONTRACTORS SHALL SET UP AN ON SITE PRE-CONSTRUCTION MEETING WITH THE DEVELOPER, PROJECT GEOTECHNICAL ENGINEER, EARTHWORK CONTRACTOR, AND SITE CIVIL ENGINEER PRIOR TO BEGINNING CONSTRUCTION.
- CONTRACTOR SHALL ASSUME THE TOP 8" OF EXISTING GROUND IS TOPSOIL. TOPSOIL REMOVED TO DEPTHS GREATER THAN 8" SHALL BE DONE ONLY AFTER CONSULTATION WITH THE PROJECT GEOTECHNICAL ENGINEER AND APPROVAL OF THE DEVELOPER.
- ALL EARTHWORK AND CONSTRUCTION ACTIVITY SHALL BE PERFORMED PER THE RECOMMENDATIONS OF THE PROJECT GEOTECHNICAL ENGINEER AS DESCRIBED IN THE GEOTECHNICAL EXPLANATION REPORT AND ALL ADDENDUMS.
- CONTRACTOR SHALL SELL ALL EARTHWORK QUANTITIES PRIOR TO AWARD OF CONTRACT. PAY QUANTITIES ARE FINAL EXCEPT FOR DOCUMENTED UNDERCUT APPROVED BY DEVELOPER PRIOR TO COMPLETION OF THE EXTRA WORK. UPON REQUEST, CONTRACTORS MAY HAVE ACCESS TO THE SITE TO FIELD CHECK TOPOGRAPHY.
- CONTRACTOR TO PROVIDE SILT FENCE AT STORM SEWER OUTLETS (ALONG WITH ROCK CHANNEL PROTECTION AS SPECIFIED IN UTILITY PLAN) TO PREVENT EROSION.
- CONTRACTOR SHALL INSTALL AND MAINTAIN A CONCRETE WASHOUT FACILITY PER BUTLER COUNTY STANDARDS.
- EROSION CONTROL MEASURES SHALL BE IMPLEMENTED PRIOR TO CONSTRUCTION AND MAINTAINED DURING CONSTRUCTION.
- BEST MANAGEMENT PRACTICES (BMPs) SHOWN ON PLANS SHALL BE REVISED OR IMPLEMENTED AS REQUIRED. CONTRACTOR SHALL MONITOR CONSTRUCTION BMPs AND PROVIDE ADDITIONAL BMPs AS REQUIRED TO PREVENT SEDIMENT RUNOFF FROM CONSTRUCTION SITE ONTO PAVEMENT AND NON-PAVED AREAS.
- AT A MINIMUM, ALL EROSION AND SEDIMENT CONTROLS ON THE SITE SHALL BE INSPECTED AT LEAST ONCE EVERY SEVEN CALENDAR DAYS AND WITHIN 24 HOURS AFTER ANY STORM EVENT GREATER THAN ONE-HALF INCH OF RAIN PER 24 HOUR PERIOD. QUALIFIED INSPECTION PERSONNEL (THOSE WITH KNOWLEDGE AND EXPERIENCE IN THE INSTALLATION AND MAINTENANCE OF SEDIMENT AND EROSION CONTROLS) SHALL CONDUCT THESE INSPECTIONS TO ENSURE THAT THE CONTROL PRACTICES ARE FUNCTIONAL AND TO EVALUATE WHETHER THE EROSION CONTROL IS ADEQUATE AND PROPERLY IMPLEMENTED OR WHETHER ADDITIONAL CONTROL MEASURES ARE REQUIRED. DISTURBED AREAS AND AREAS USED FOR STORAGE OF MATERIALS THAT ARE EXPOSED TO PRECIPITATION SHALL BE INSPECTED FOR EVIDENCE OF OR THE POTENTIAL FOR, POLLUTANTS ENTERING THE DRAINAGE SYSTEM. EROSION AND SEDIMENT CONTROL MEASURES SHALL BE OBSERVED TO ENSURE THAT THEY ARE OPERATING CORRECTLY. DISCHARGE LOCATIONS SHALL BE INSPECTED TO ASCERTAIN WHETHER EROSION AND SEDIMENT CONTROL MEASURES ARE EFFECTIVE IN PREVENTING SIGNIFICANT IMPACTS TO THE RECEIVING WATERS. LOCATIONS WHERE VEHICLES ENTER OR EXIT THE SITE SHALL BE INSPECTED FOR EVIDENCE OF OFF-SITE VEHICLE TRACKING.
- SITE STABILIZATION SHALL BEGIN WITHIN 7 DAYS ON AREAS OF THE SITE WHERE CONSTRUCTION ACTIVITIES HAVE PERMANENTLY OR TEMPORARILY CEASED FOR 14 DAYS.
- ALL MUD OR DEBRIS TRACKED ON EXISTING STREETS SHALL BE CLEANED AT THE END OF EACH DAY OR AS DIRECTED BY BUTLER COUNTY OR THE OWNER. PERIODIC STREET SWEEPING MAY BE REQUIRED.
- IN ADDITION TO ANY TEMPORARY EROSION, MUD, AND DEBRIS CONTROL DETAILS AND NOTES SHOWN ON THE PLANS, THE CONTRACTOR SHOULD PLACE TEMPORARY OR PERMANENT SEEDING, MULCHING AND/OR MULCH NETTING OR ANY OTHER GENERALLY ACCEPTED METHODS TO PREVENT EROSION, MUD, AND DEBRIS FROM BEING DEPOSITED ON OTHER PROPERTY, ON NEWLY CONSTRUCTED OR EXISTING ROADS, OR INTO EXISTING SEWERS OR NEW SEWERS WITHIN THE DEVELOPMENT. THE CONTRACTOR SHOULD CONTINUALLY MONITOR THE CONSTRUCTION PROGRESS AND MAKE ANY NECESSARY TEMPORARY ADJUSTMENTS TO MAINTAIN THIS CONTROL.
- AFTER THE VEGETATION HAS BECOME WELL ESTABLISHED, TEMPORARY EROSION AND SEDIMENT CONTROLS CAN BE REMOVED.
- TOPSOIL WASTING AREAS ARE DESIGNATED ON THE PLAN IN 12' AND 18' DEPTHS IN FILL AREAS.
- A PRECONSTRUCTION GEOTECHNICAL REVIEW OF PROPOSED GRADING SHALL BE REQUIRED FOR LOTS 83-85, 92-94, AND 104-107 TO ASSESS THE IMPACT OF THE GRADING ON THE STABILITY OF THE SLOPES ALONG THE NORTH PROPERTY LINE.
- LOTS 92-94, AND 104-107 WILL HAVE MORE THAN FIVE (5) OF FILL AND WILL REQUIRE A COMPACTION TEST, WHICH MUST BE APPROVED BY THE BUTLER SWCD OFFICE PRIOR TO FINAL PLAT APPROVAL.
- SIDE SLOPE FILLS FOR LOTS 83-85, 92-94, AND 104-107 SHALL REQUIRE HORIZONTAL, LEVEL BENCHING INTO BEDROCK, INTERBEDDED SHALE AND LIMESTONE TO PROVIDE LONG TERM STABILIZATION DRAINS (12"-24" DEPTH) BEING PLACED IN THE SIDE SLOPES IN ON THE LOT.
- PERMANENT UNDERRAINS SHALL BE REQUIRED TO RELIEVE THE WATER BUILDUP OF HYDROSTATIC PRESSURES BEHIND THE FILL ZONES FOR LOTS 83-85, 92-94, AND 104-107. OUTLETS FOR THE UNDERRAINS SHOULD BE WELL MARKED IN THE FIELD AND SHOULD BE PLOTTED AS DRAINAGE EASEMENTS TO ASSURE THEIR LONG-TERM FUNCTIONALITY. THE UNDERRAINS MAY ALSO BE CONNECTED DIRECTLY TO THE STORM SEWER SYSTEM.




SWPPP NOTES

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- AFTER THE VEGETATION HAS BECOME WELL ESTABLISHED, TEMPORARY EROSION AND SEDIMENT CONTROLS CAN BE REMOVED.

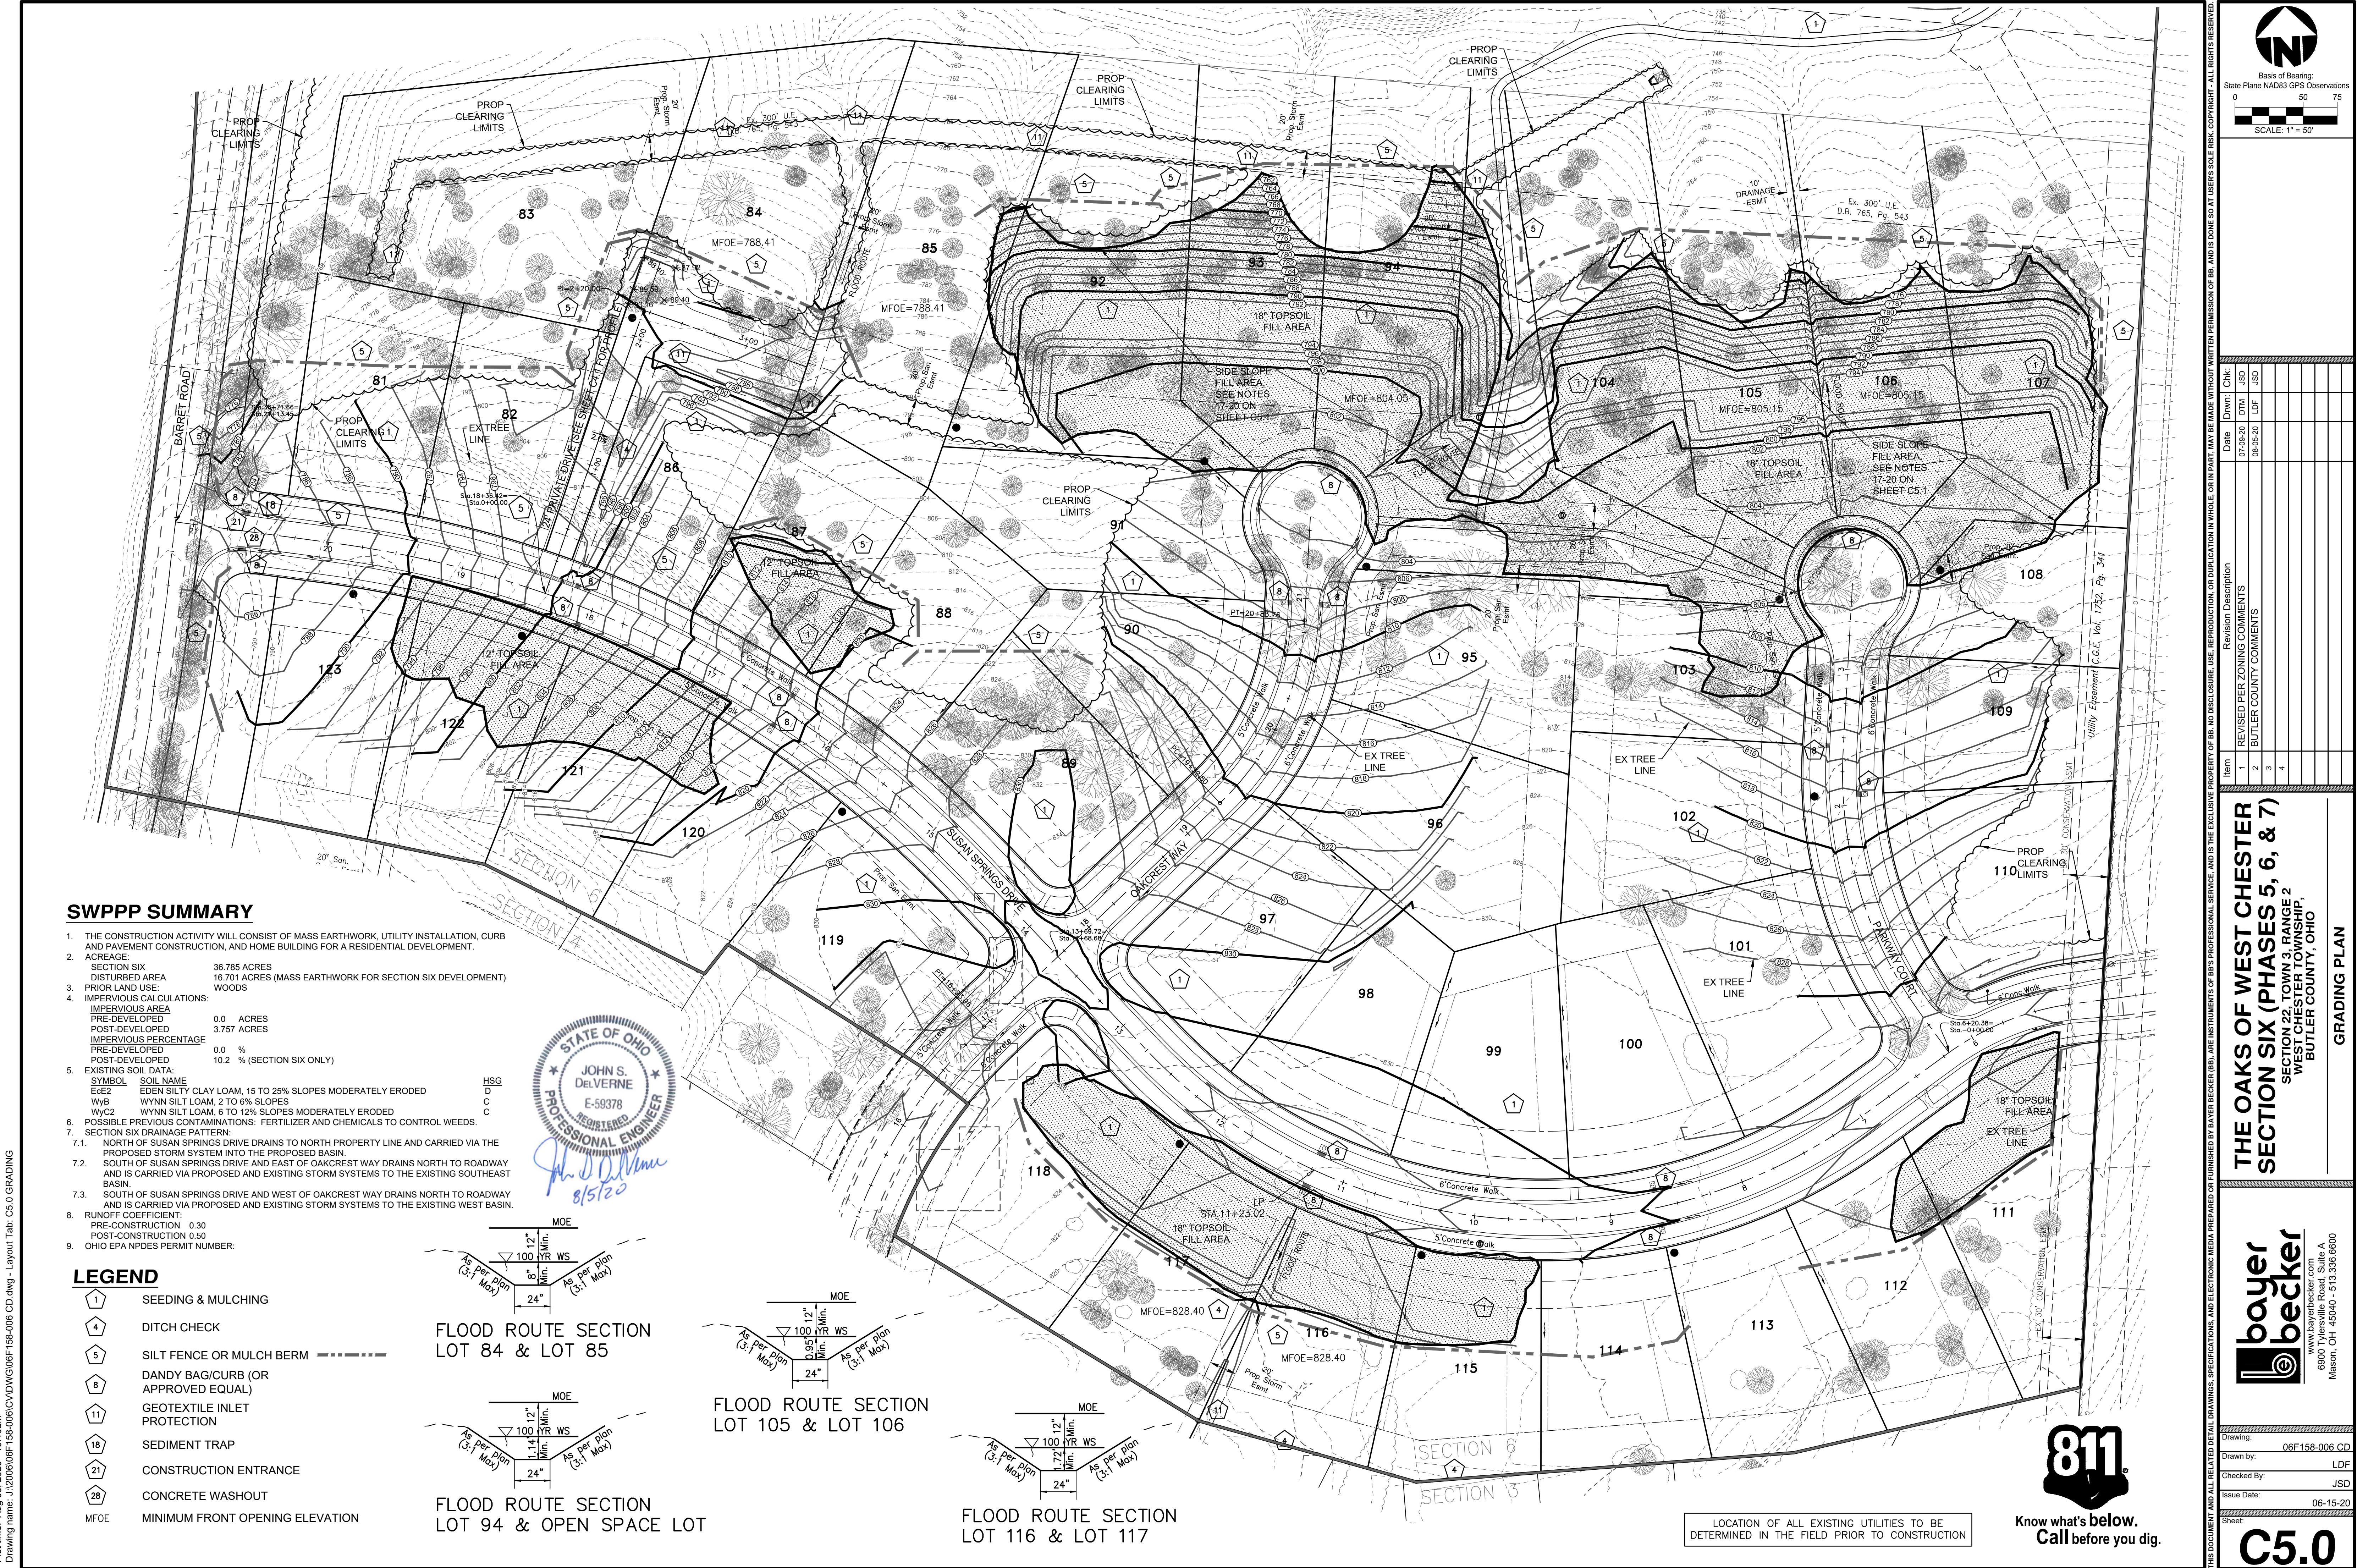

SWPPP SUMMARY

- THE CONSTRUCTION ACTIVITY WILL CONSIST OF MASS EARTHWORK, UTILITY INSTALLATION, CURB AND PAVEMENT CONSTRUCTION, AND HOME BUILDING FOR A RESIDENTIAL DEVELOPMENT.
- ACREAGE:
SECTION SIX 36.785 ACRES
DISTURBED AREA 16.701 ACRES (MASS EARTHWORK FOR SECTION SIX DEVELOPMENT)
PRIOR LAND USE WOODS
- IMPERVIOUS SURFACE:
PRE-DEVELOPED 0.0 ACRES
POST-DEVELOPED 3.757 ACRES
- IMPERVIOUS PERCENTAGE:
PRE-DEVELOPED 0.0 %
POST-DEVELOPED 10.2 % (SECTION SIX ONLY)
- EXISTING SOIL DATA:
SYMBOL SOIL NAME HSG
Ee2 EDEN SILTY CLAY LOAM, 15 TO 25 SLOPES MODERATELY ERODED
Wy2 WYNN SILT LOAM, 2 TO 6% SLOPES
Wc2 WYNN SILT LOAM, 6 TO 12% SLOPES MODERATELY ERODED C
- Possible Previous Contaminants: Fertilizer and chemicals to control weeds.
- SECTION SIX DRAINAGE PATTERN:
7.1. NORTH OF SUSAN SPRINGS DRIVE DRAINS TO NORTH PROPERTY LINE AND CARRIED VIA THE PROPOSED STORM SYSTEM INTO THE PROPOSED BASIN.
7.2. SOUTH OF SUSAN SPRINGS DRIVE DRAINS SOUTH AND IS CARRIED VIA PROPOSED AND EXISTING STREAMS DOWN TO THE EXISTING WEST BASIN.
- RUNOFF COEFFICIENT:
PRE-CONSTRUCTION 0.30
POST-CONSTRUCTION 0.50
- OHIO EPA NPDES PERMIT NUMBER: 061211NE-2

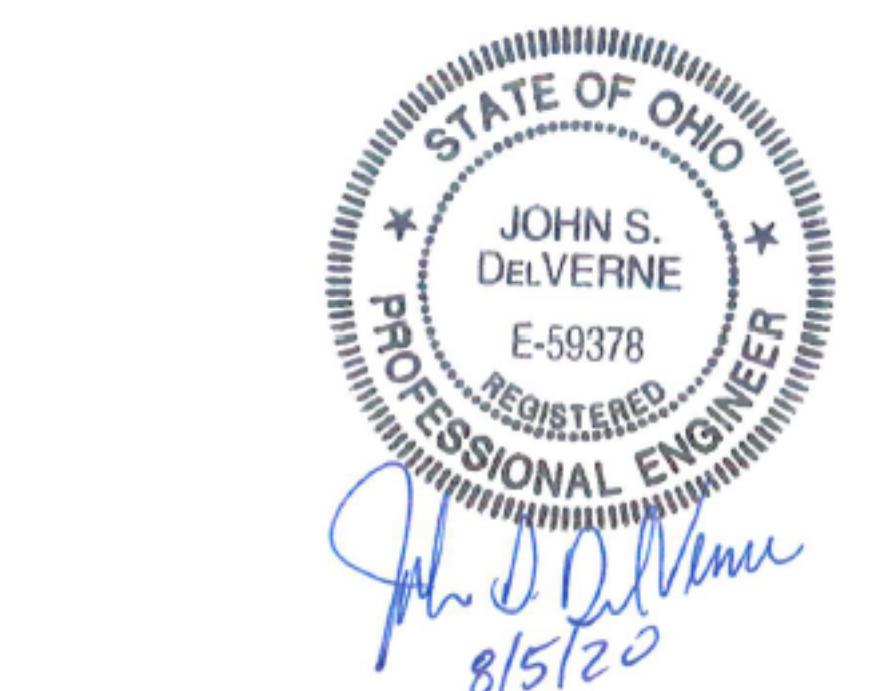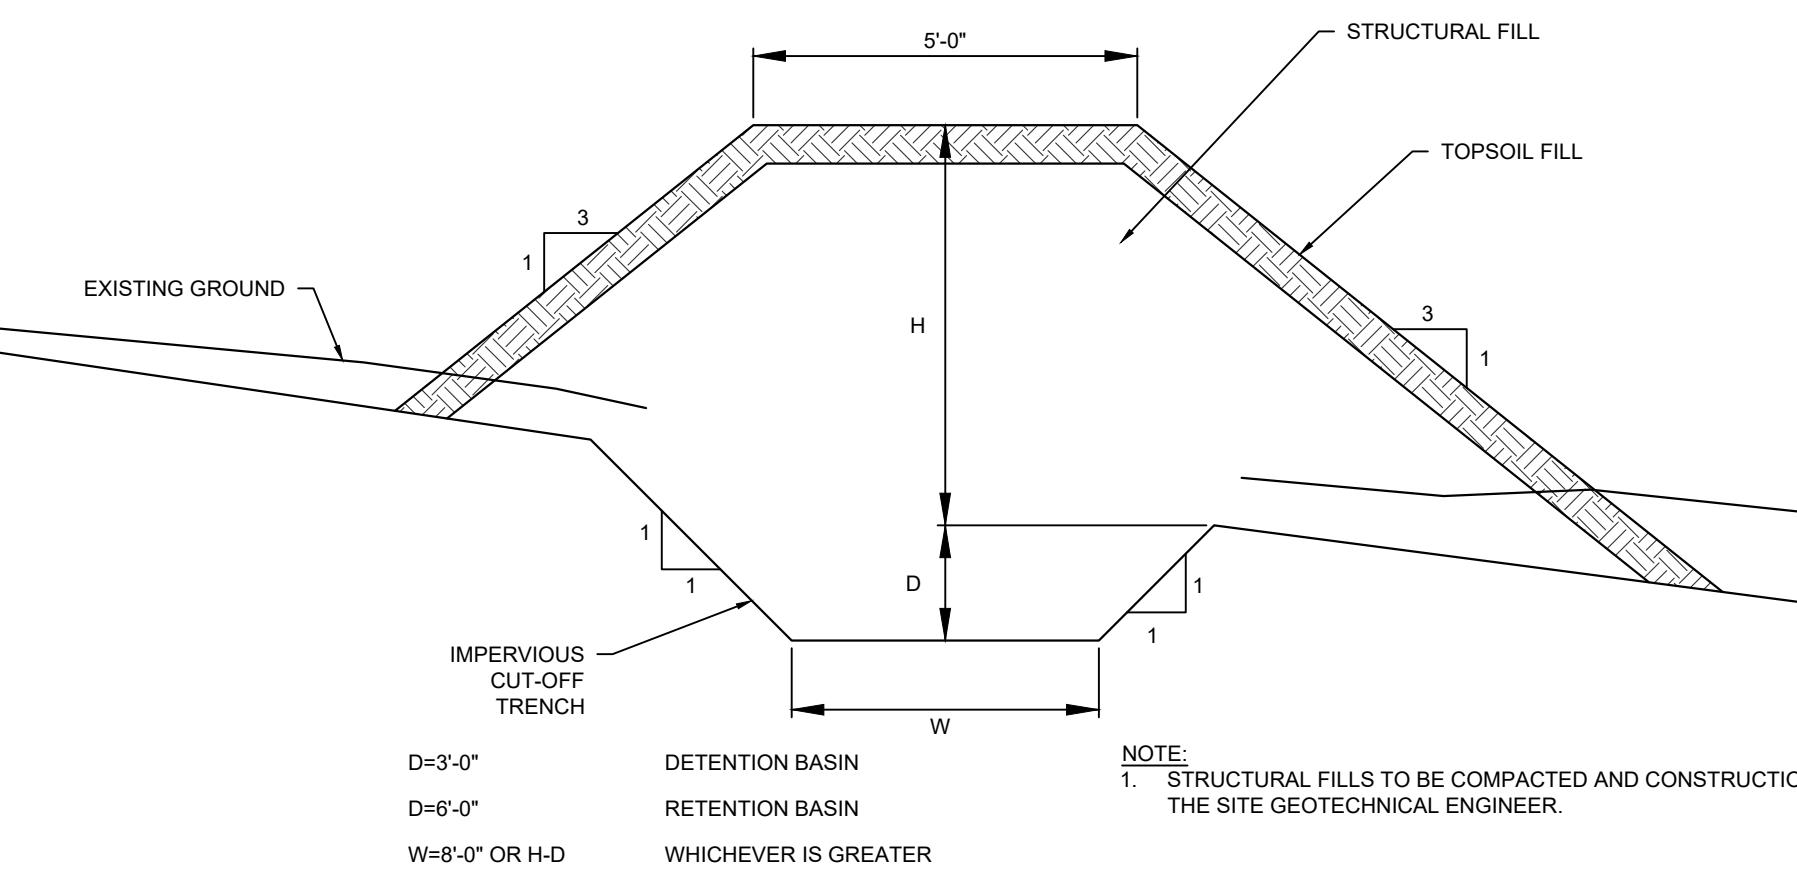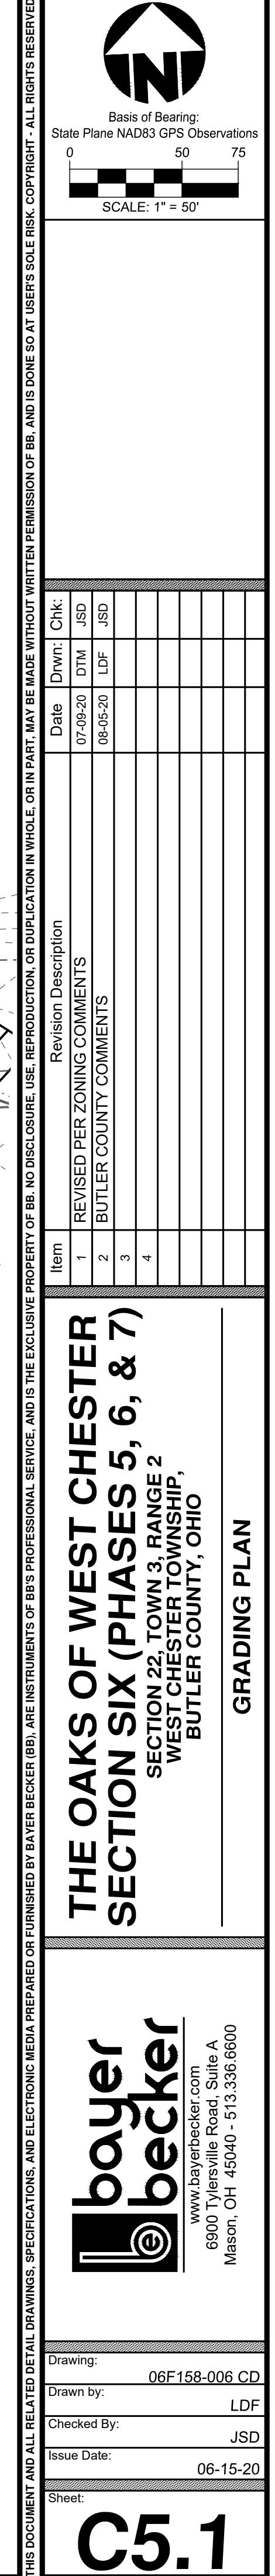

LEGEND

- 1 SEEDING & MULCHING
- 4 DITCH CHECK
- 5 SILT FENCE OR MULCH BERM -----
- 8 DANDY BAG/CURB (OR APPROVED EQUAL)
- 11 GEOTEXTILE INLET PROTECTION
- 18 SEDIMENT TRAP
- 21 CONSTRUCTION ENTRANCE
- 28 CONCRETE WASHOUT
- MFOE MINIMUM FRONT OPENING ELEVATION



Know what's below.
Call before you dig.

LOCATION OF ALL EXISTING UTILITIES TO BE DETERMINED IN THE FIELD PRIOR TO CONSTRUCTION

GENERAL NOTES

EROSION AND SEDIMENT CONTROLS

Vegetative practices

Such practices may include: temporary seeding, permanent seeding, mulching, matting, soil stabilization, vegetative buffer strips, phasing and protection of trees. The contractor shall initiate appropriate vegetative practices on all disturbed areas within seven (7) days if they are to remain dormant (undisturbed) for more than fourteen (14) days. Permanent or temporary soil stabilization shall be applied to disturbed areas within seven (7) days after final grade is reached on any portion of the site.

Structural Practices

Structural practices shall be used to control erosion and trap sediment from all sites remaining disturbed for more than fourteen (14) days.

Timing

Sediment control structures shall be functional throughout earth disturbing activity. Sediment ponds and perimeter sediment barriers shall be implemented as the first step of grading and within seven days from the start of grubbing. They shall continue to function until the upslope development area is restabilized.

Sediment Barriers


Sheet flow runoff from denuded areas shall be intercepted by sediment barriers. Sediment barriers, such as sediment fences or diversions direction runoff to settling facilities, shall protect adjacent properties and water resources from sediment transported by sheet flow.

Erosion and sediment control practices used to satisfy the conditions of this plan shall meet the standards and specifications in the current edition of Water Management and Sediment Control in Urbanized Areas (Soil Conservation Service.)


Waste Disposal
No solid or liquid waste, including building materials, shall be discharged in storm water runoff. Off-site vehicle tracking of sediments shall be minimized. The plan shall ensure and demonstrate compliance and applicable State of local waste disposal, sanitary sewer or septic system regulations.

Maintenance

All temporary and permanent control practices shall be maintained and repaired as needed to assure continued performance of their intended function. The contractor shall be responsible for the maintenance described above.

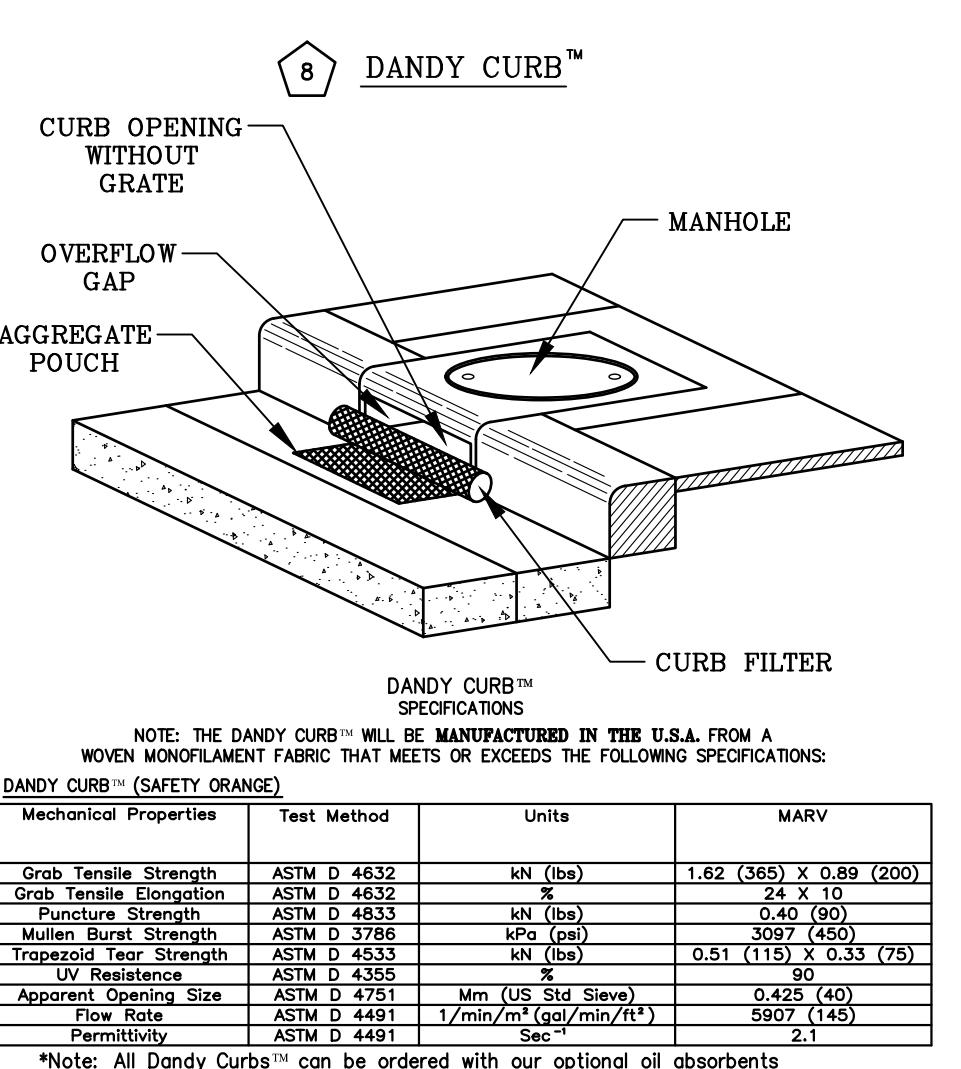

*Note: All Dandy Curbs™ can be ordered with our optional oil absorbents

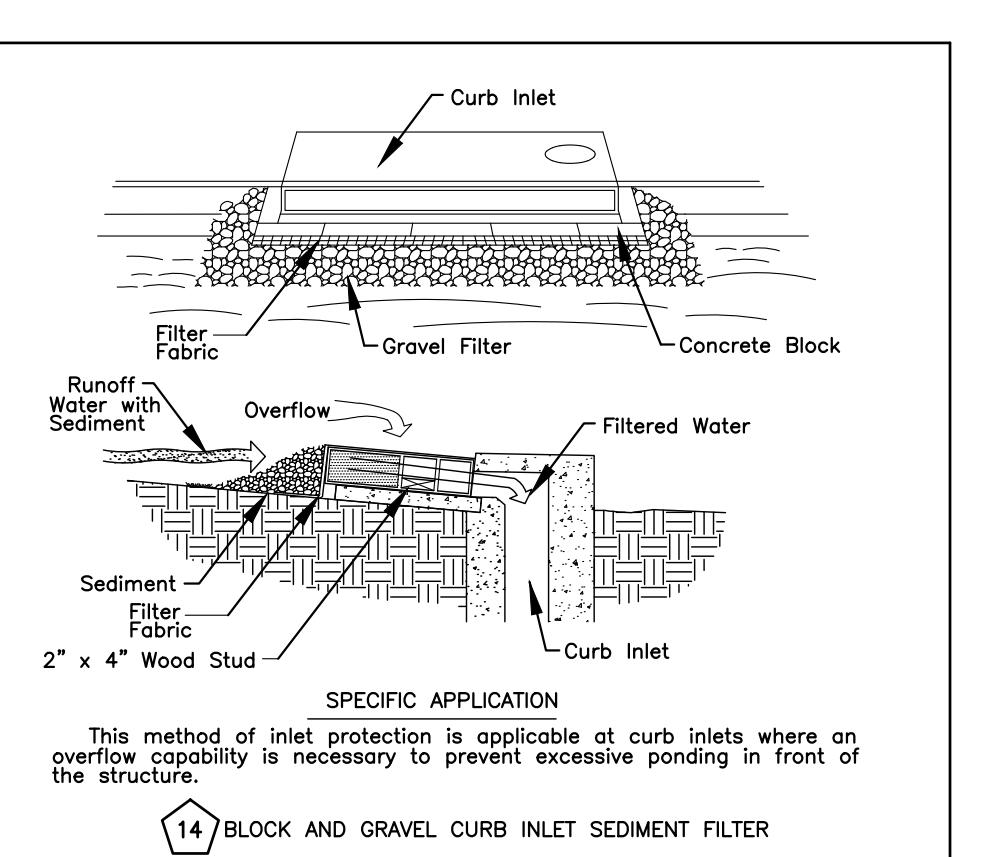

This method of inlet protection is applicable where heavy flows are expected and where an overflow capacity is necessary to prevent excessive ponding around the structure.

14 BLOCK AND GRAVEL CURB INLET SEDIMENT FILTER



8 DANDY BAG®

Installation and Maintenance Guidelines


Installation: The empty Dandy Bag® should be placed over the grate as the grate stands on end. If using optional oil absorbents; place absorbent pillow in pouch, on the bottom (below-grade side) of the unit. Attach absorbent pillow to tether loop. Tuck the enclosure flap inside to completely enclose the grate. Holding the lifting devices (do not rely on lifting devices to support the entire weight of the grate), place the grate into its frame.

Maintenance: Remove all accumulated sediment and debris from surface and vicinity of unit after each storm event. Remove sediment that has accumulated within the containment area of the Dandy Bag® as needed. If using optional oil absorbents; remove and replace absorbent pillow when near saturation.

DANDY BAG®

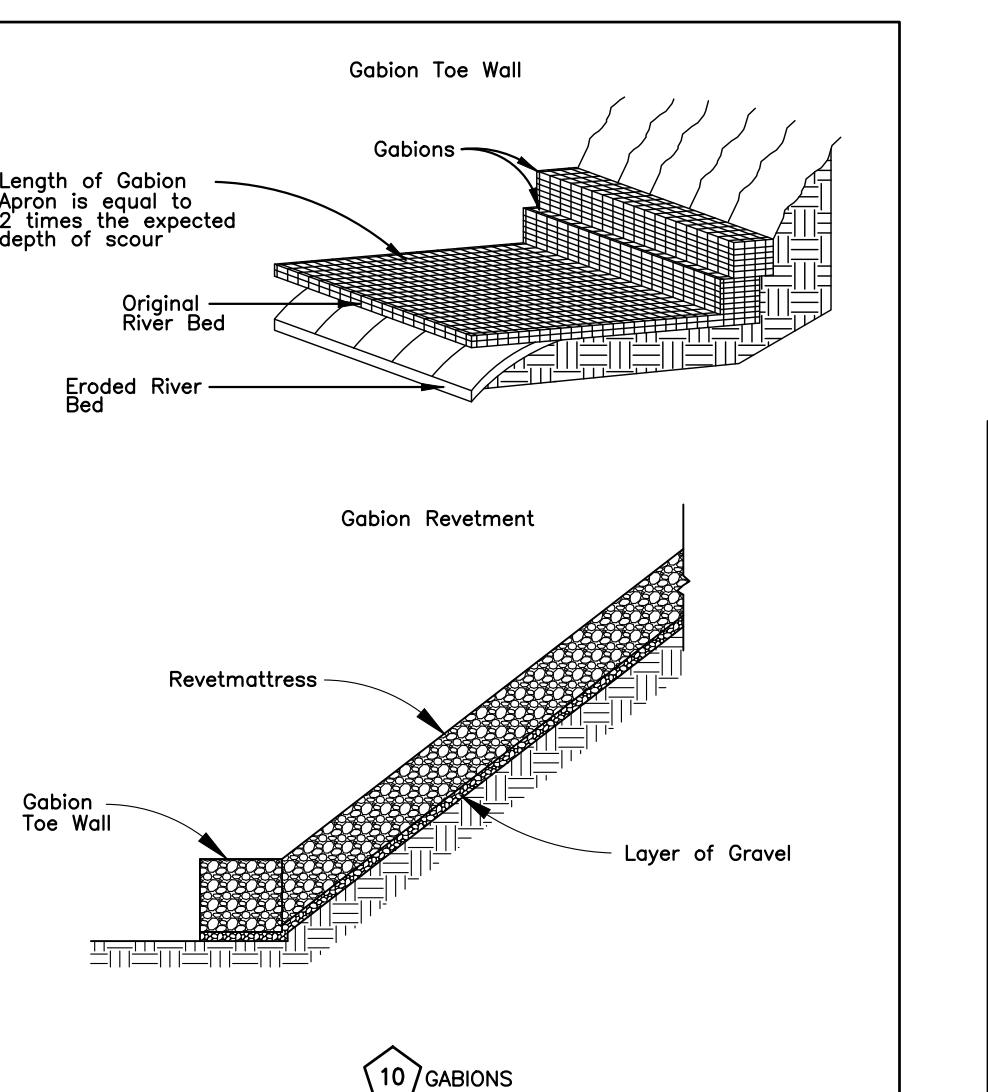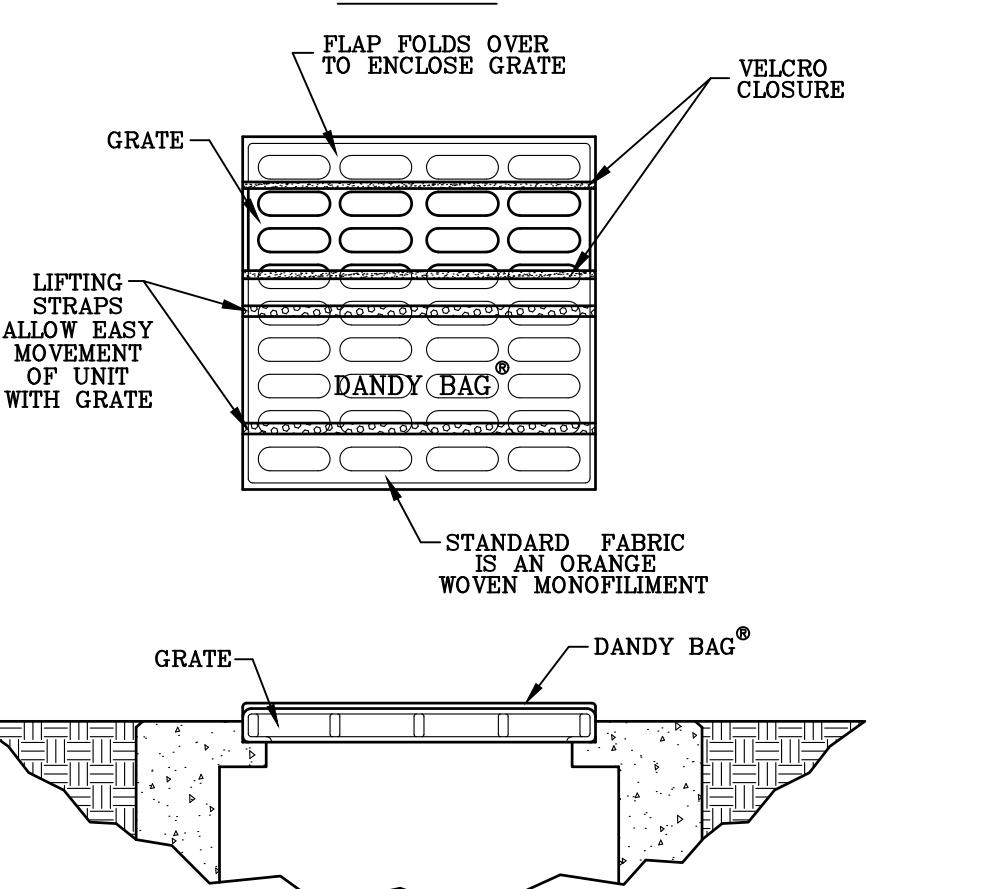


Source: Adapted from product literature of Bekert Gabions.

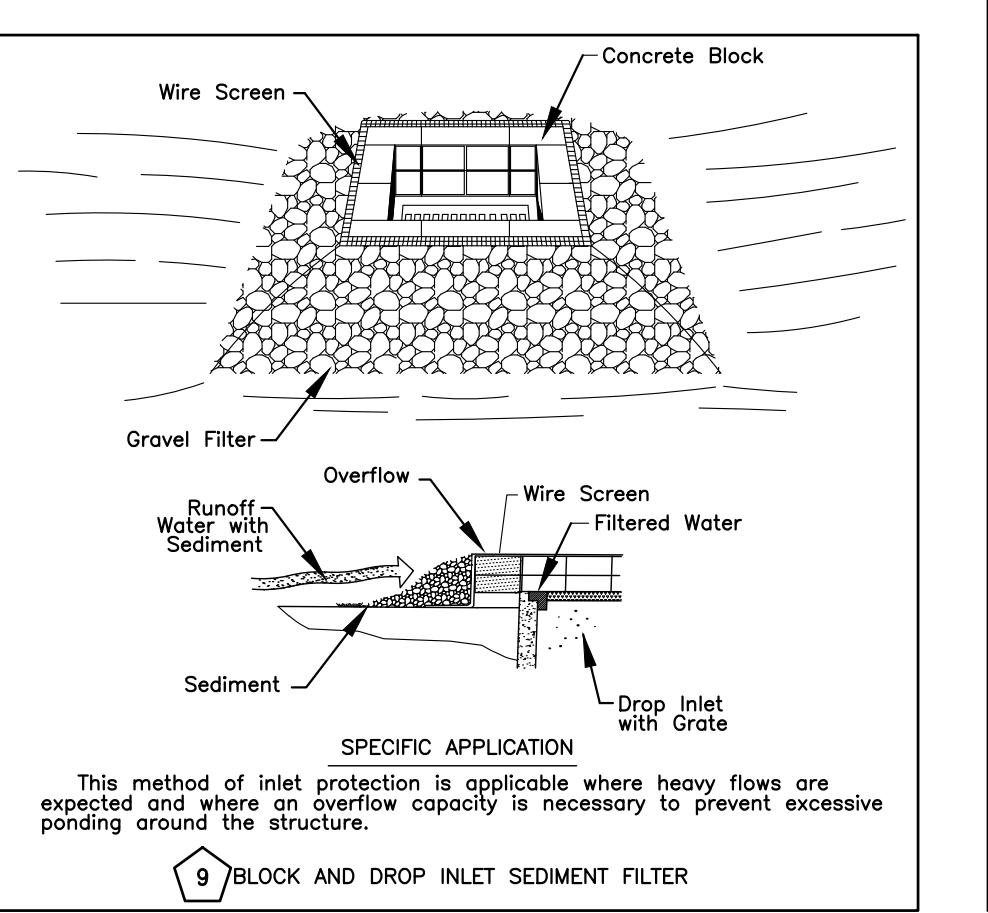

This method of inlet protection is applicable where heavy flows are expected and where an overflow capacity is necessary to prevent excessive ponding around the structure.

9 BLOCK AND GRAVEL CURB INLET SEDIMENT FILTER


DIKES AND SLOPE PROTECTION

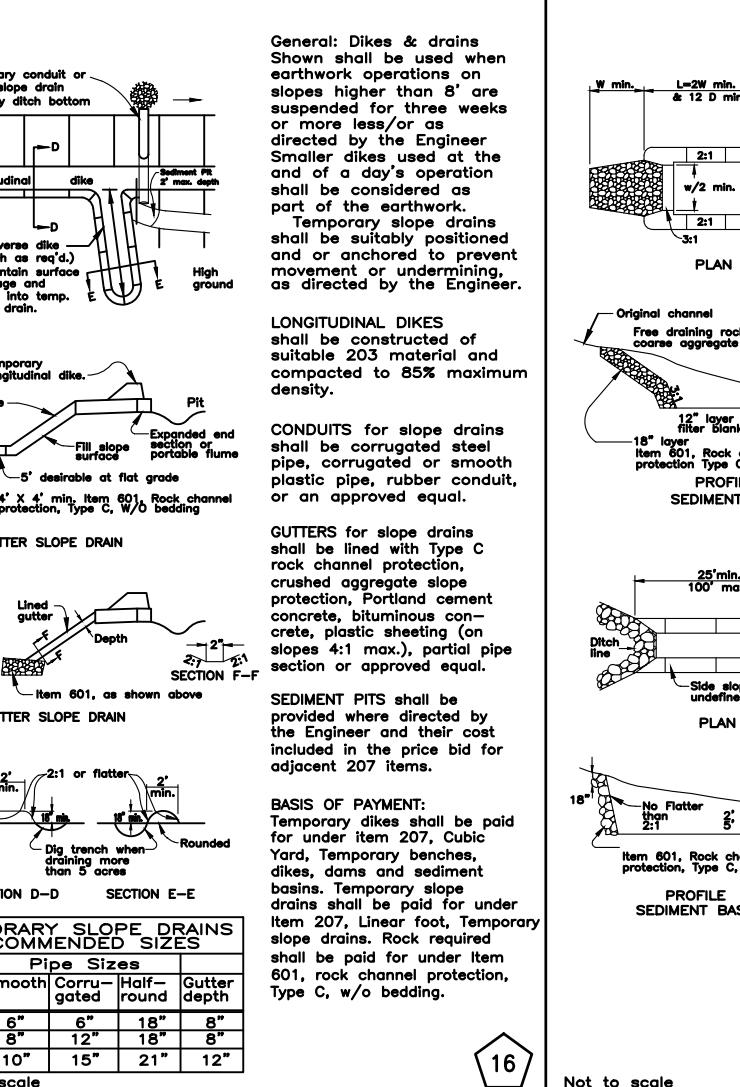

16 Not to scale

BUREAU OF LOCATION AND DESIGN
OHIO DEPARTMENT OF TRANSPORTATION
TEMPORARY
EROSION CONTROL
STANDARD CONSTRUCTION DRAWING MC-11


SEDIMENT BASINS & DAMS

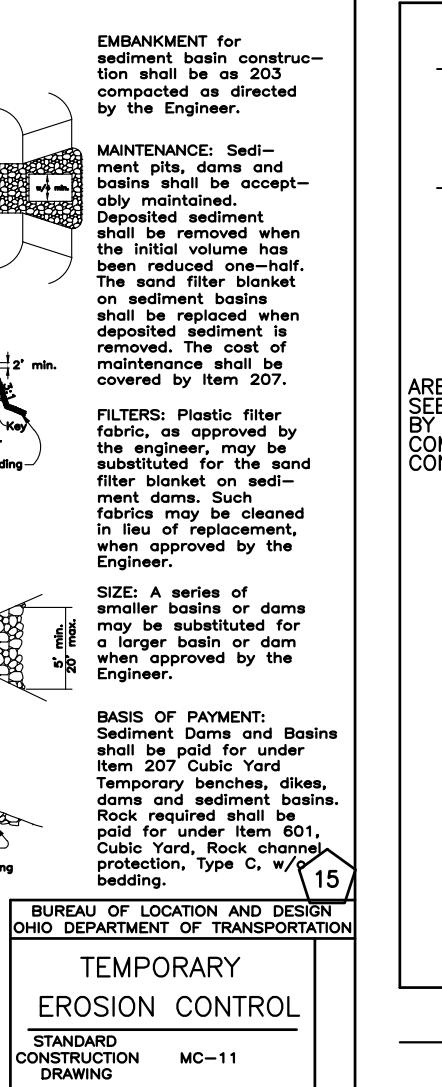

16 Not to scale

BUREAU OF LOCATION AND DESIGN
OHIO DEPARTMENT OF TRANSPORTATION
TEMPORARY
EROSION CONTROL
STANDARD CONSTRUCTION DRAWING MC-11



EROSION CONTROL FOR SMALL SITES

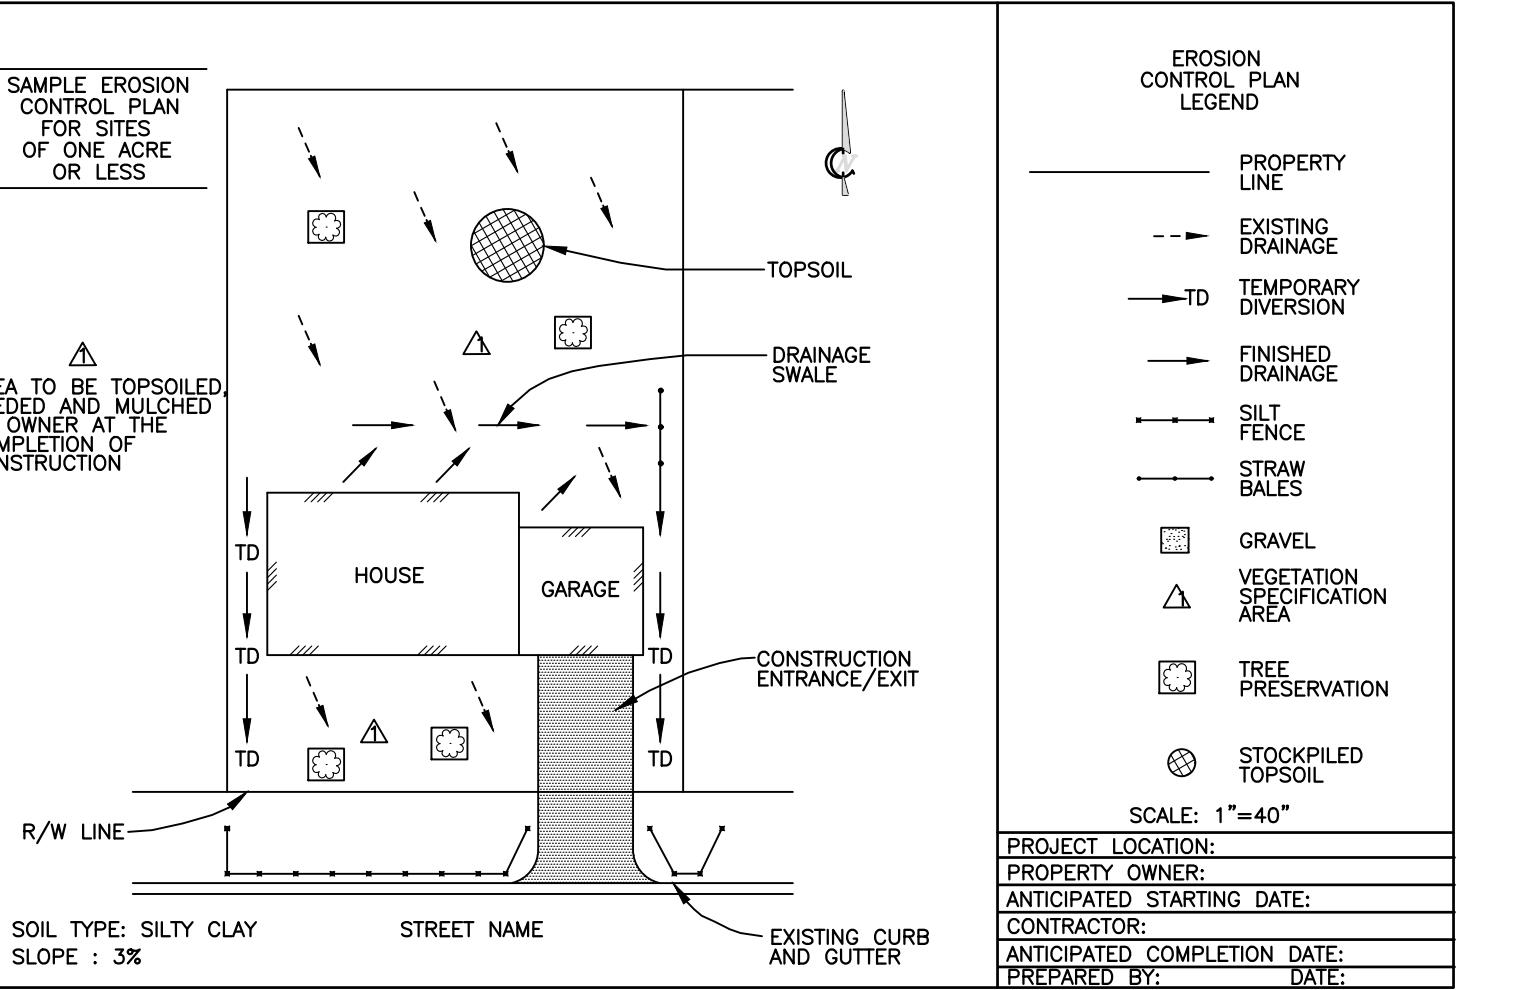

16

Not to scale

16

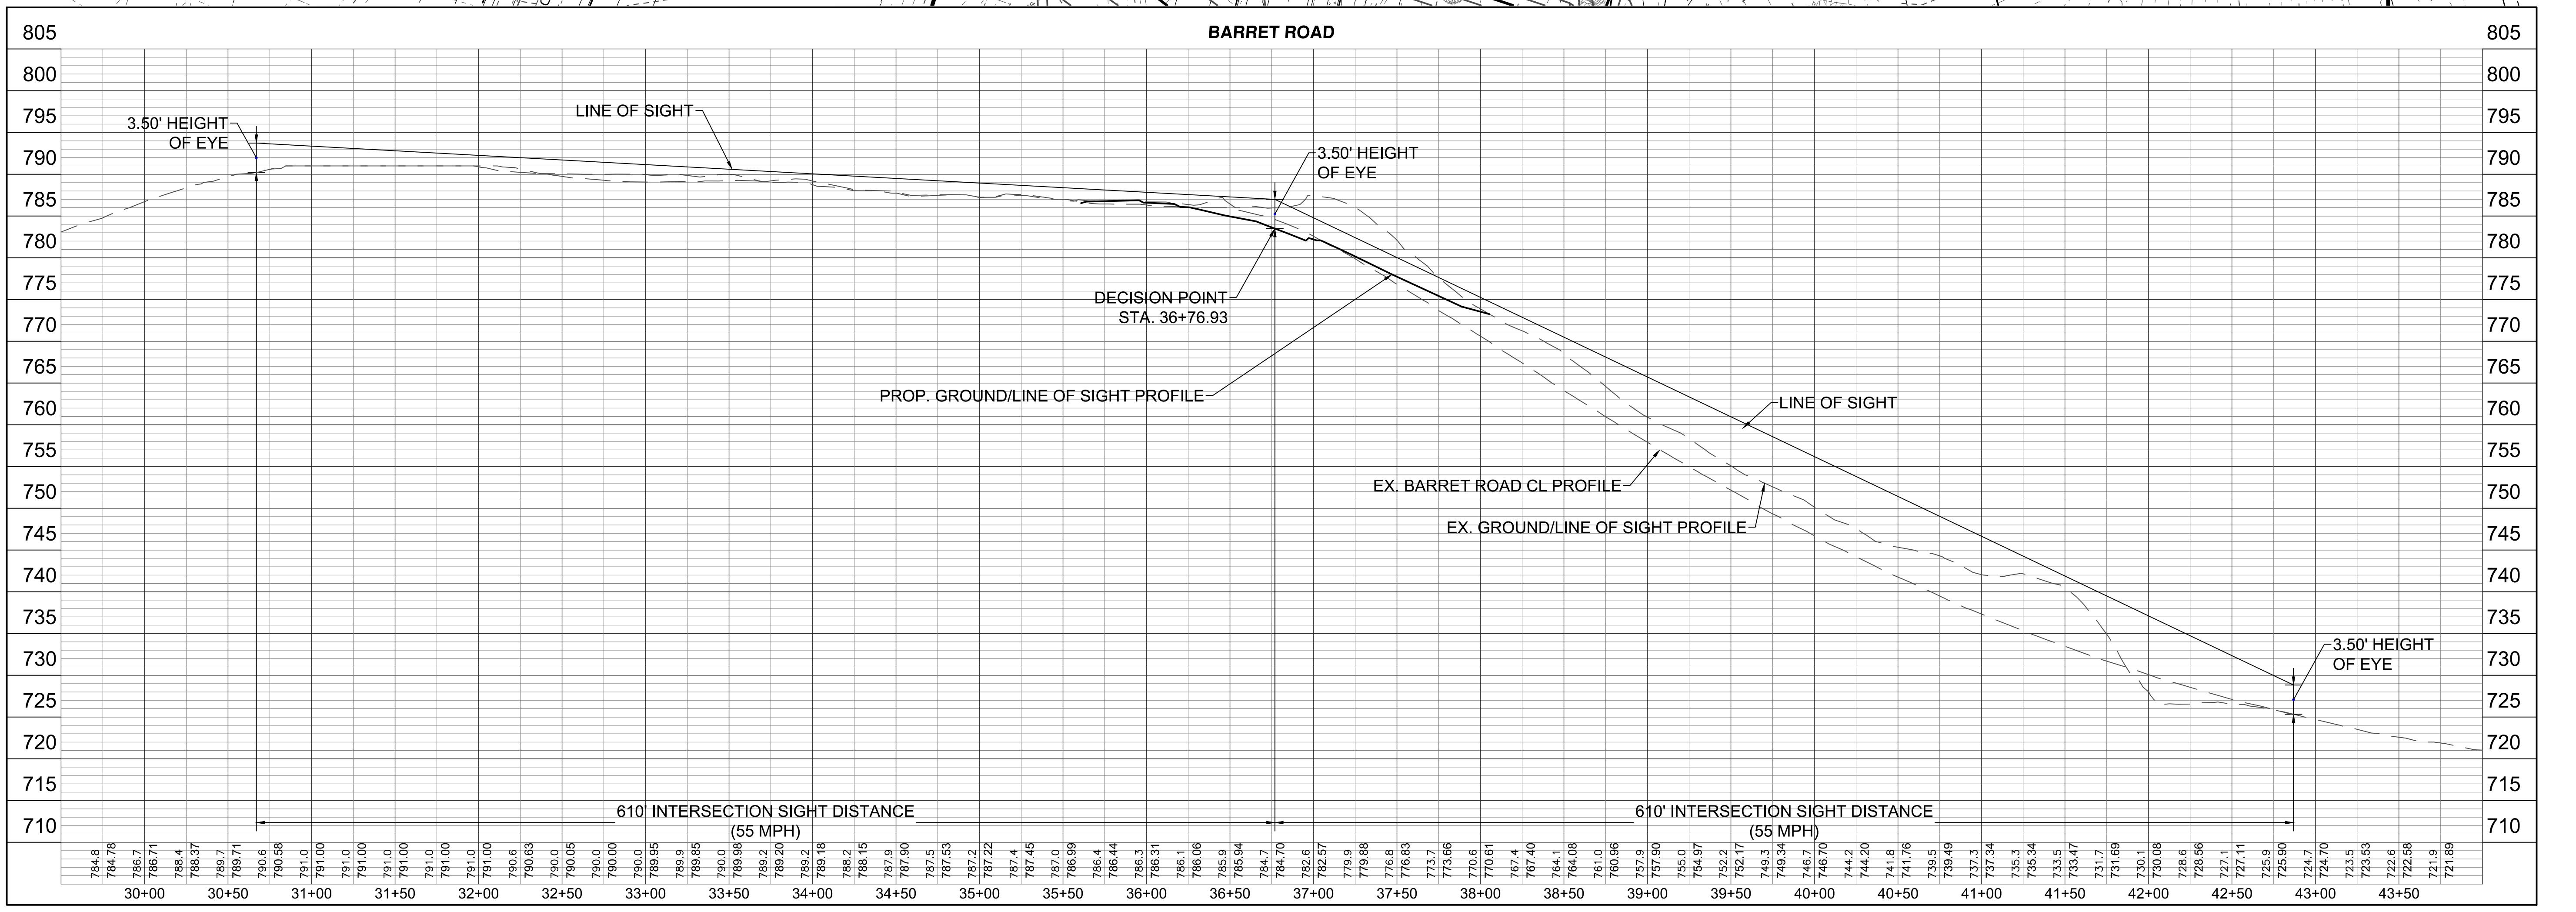
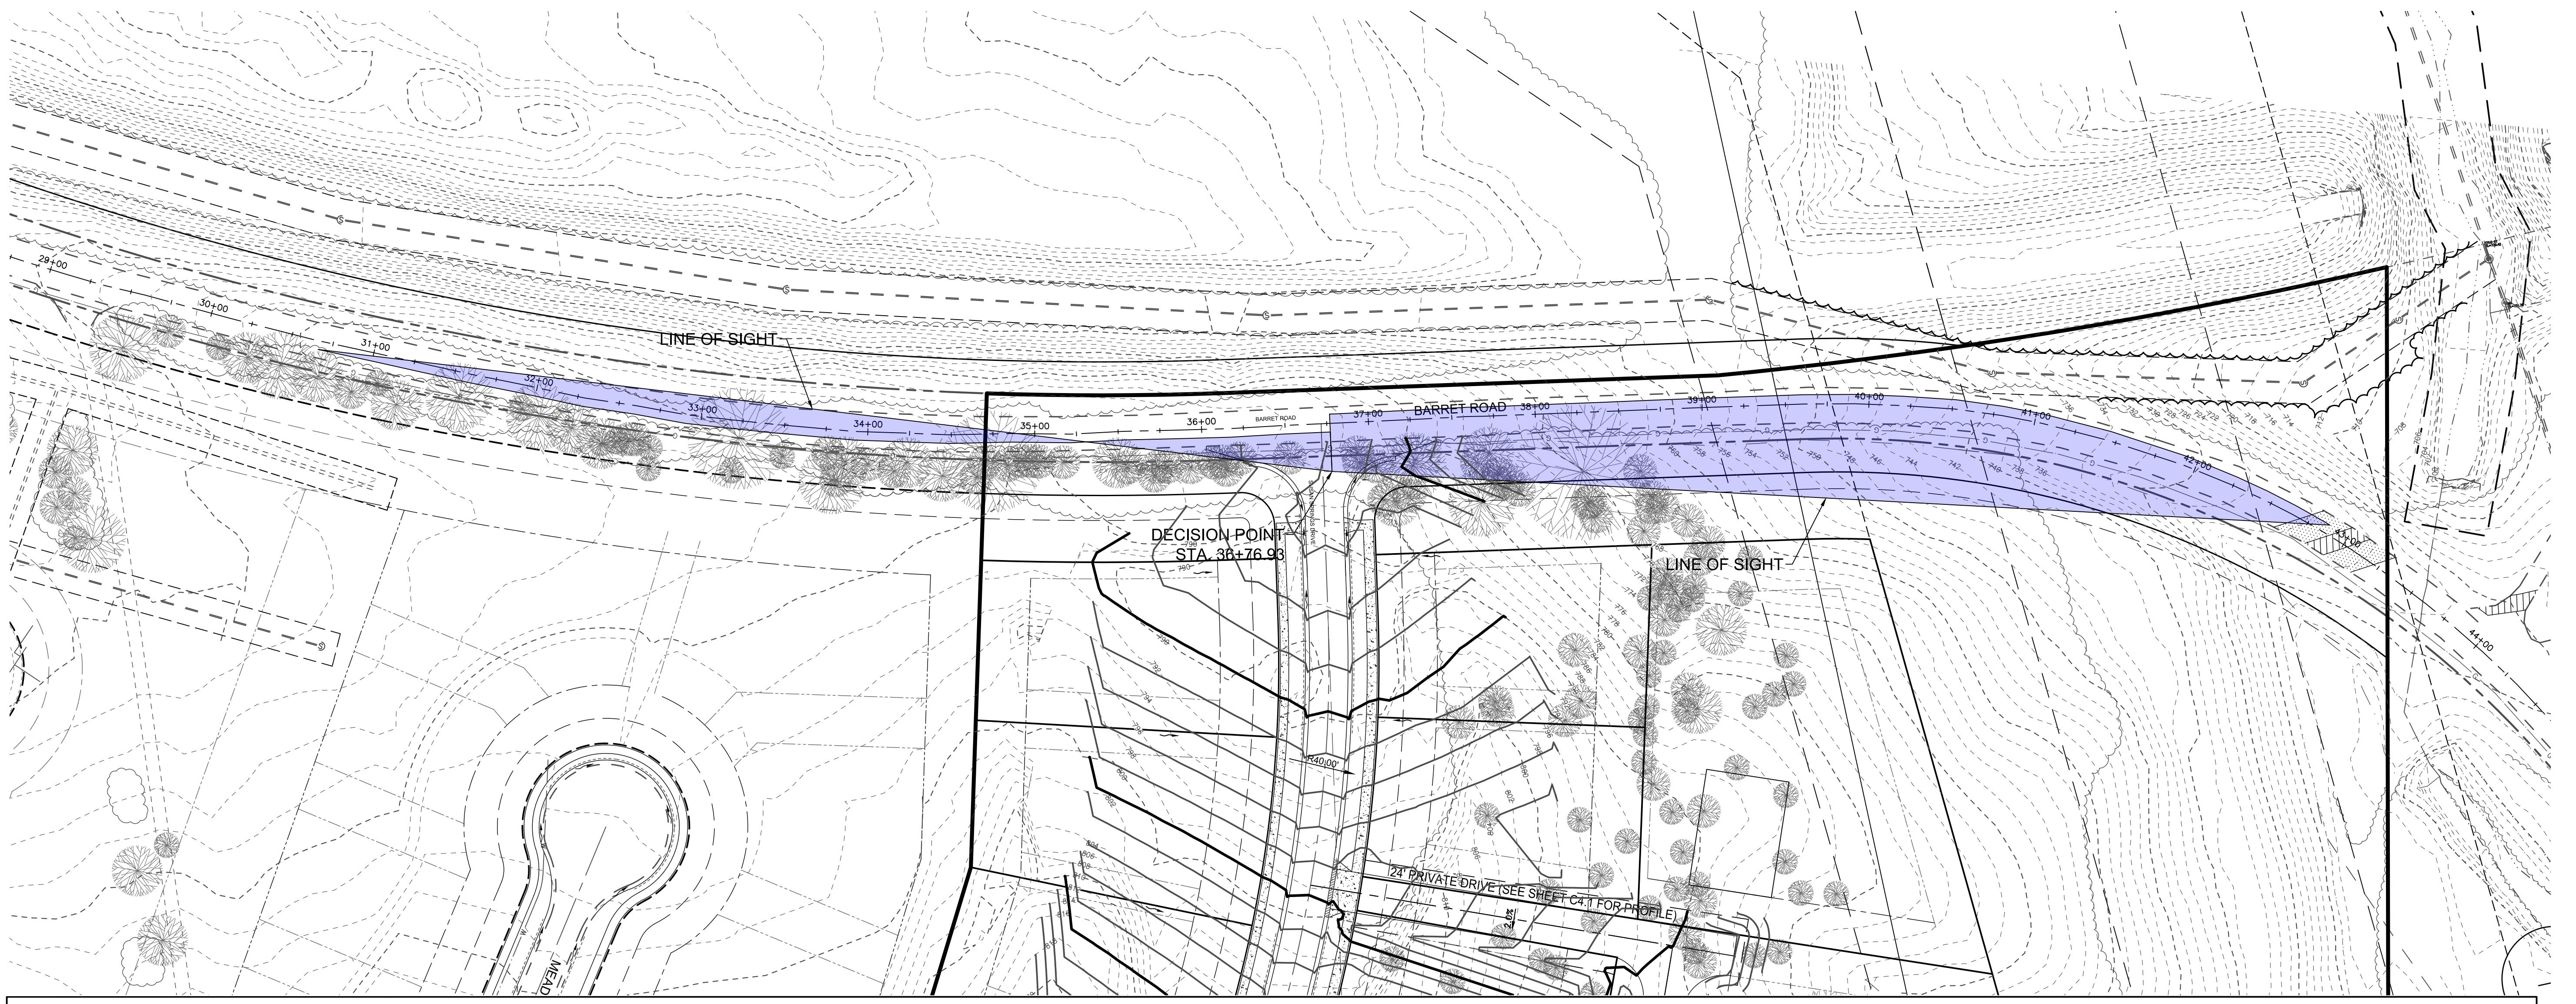



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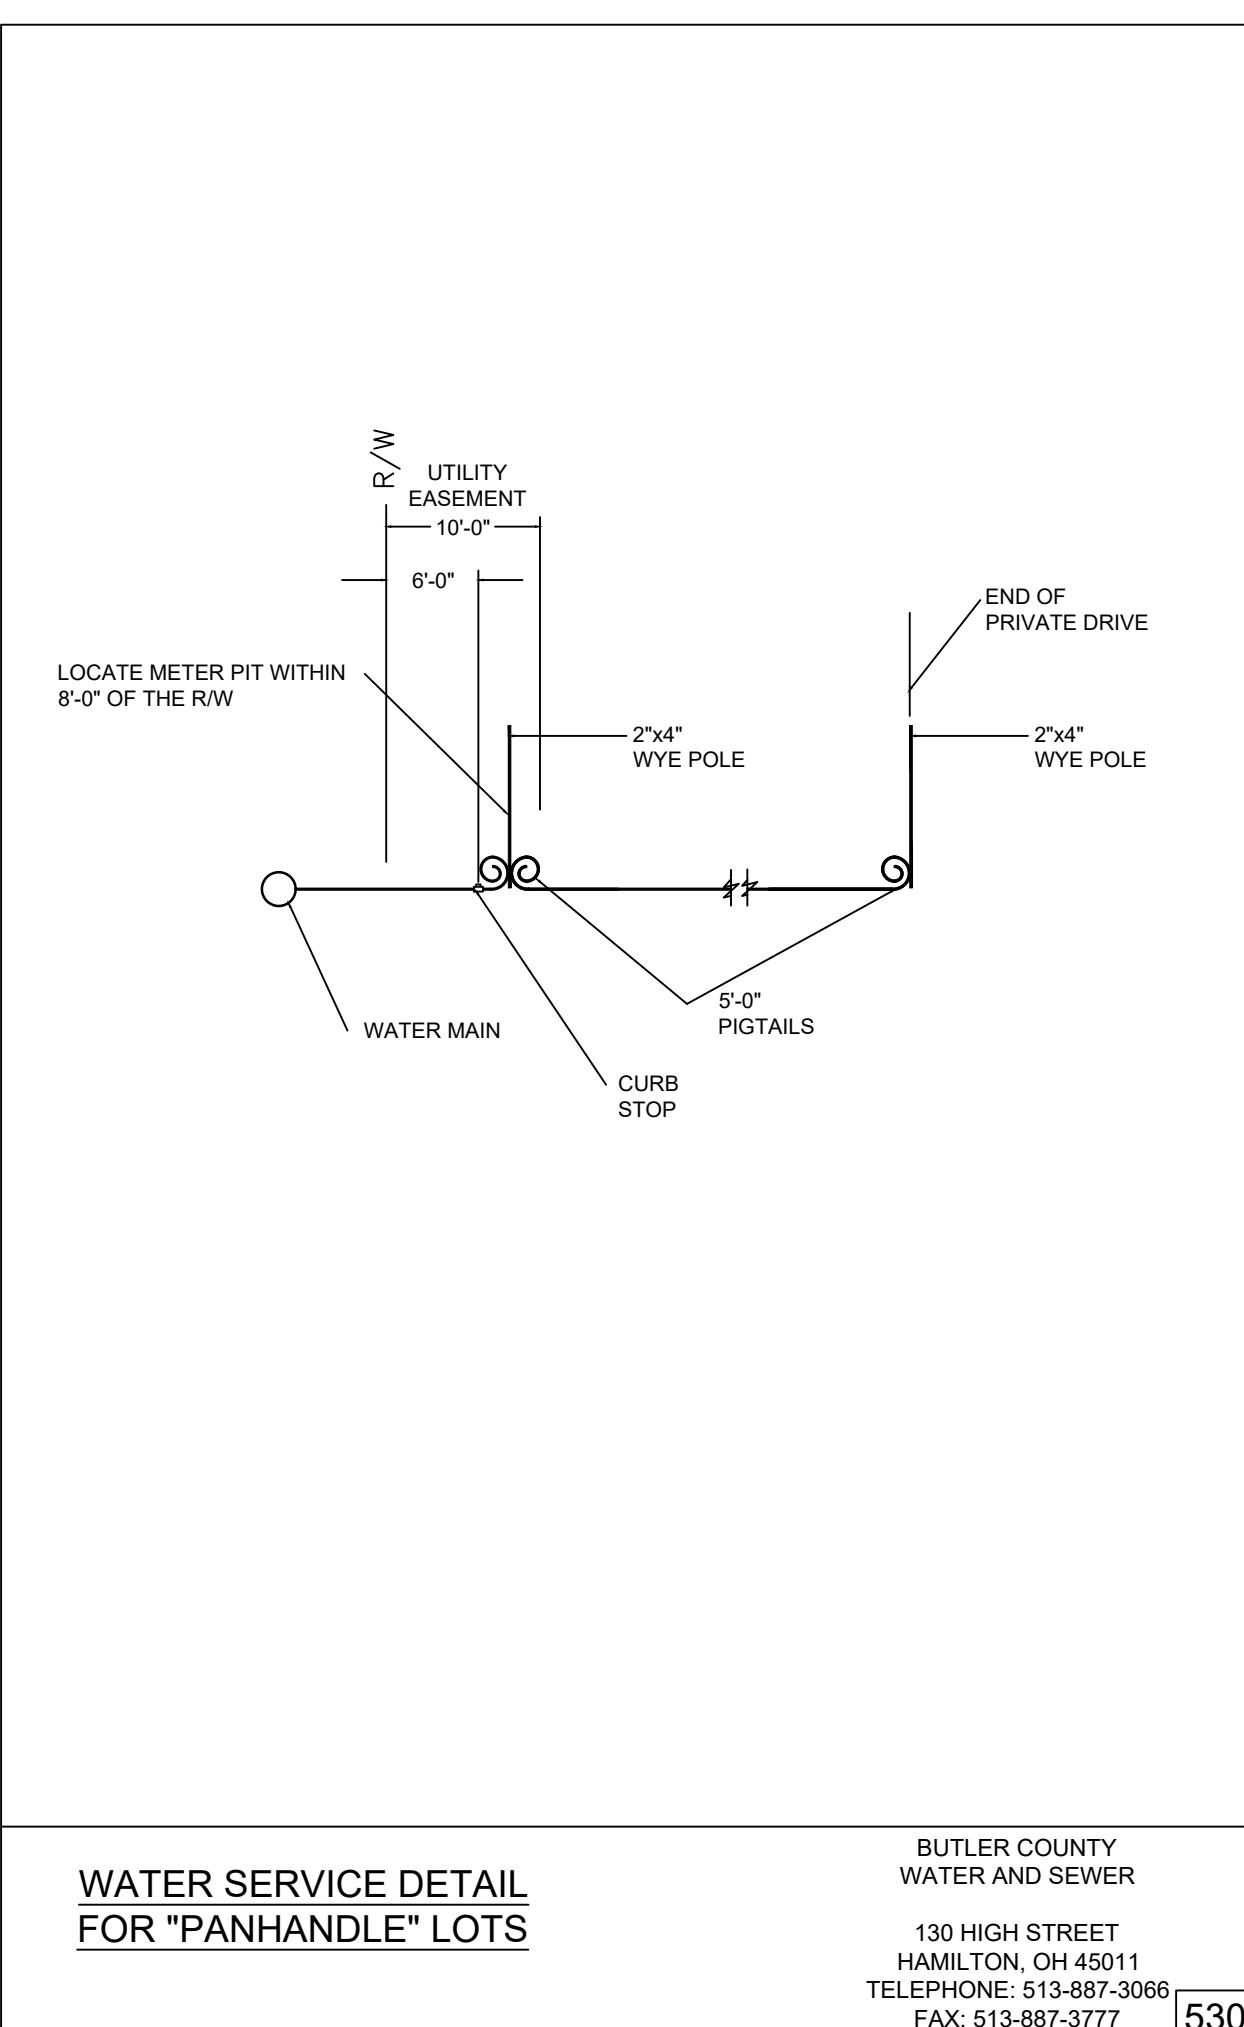
Plot time: Aug 05, 2020 - 1
Drawing name: J:\2006\06

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Plot time: Aug 05, 2020 - 1
Drawing name: J:\2006\06

Drawing:		06F158-006 ISD			
Drawn by:		KMD			
Checked By:					
Issue Date:		04-30-20			
Sheet:					
C6.0					
<p>THE OAKS OF WEST CHESTER SECTION SIX (PHASE 5, 6, & 7)</p> <p>SECTION 22, TOWN 3, RANGE 2 WEST CHESTER TOWNSHIP, BUTLER COUNTY, OHIO</p> <hr/> <p>INTERSECTION SIGHT DISTANCE ANALYSIS</p>					
 <p>www.bayerbecker.com 6900 Tylersville Road, Suite A Mason, OH 45040 - 513.336.6600</p>					
<p>Basis of Bearing: State Plane NAD83 GPS Observations</p> <p>0 50 75</p> <p>SCALE: 1" = 50'</p>					
 <p><i>John S. DelVerne 8/5/20</i></p>					




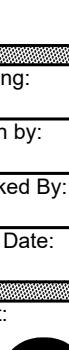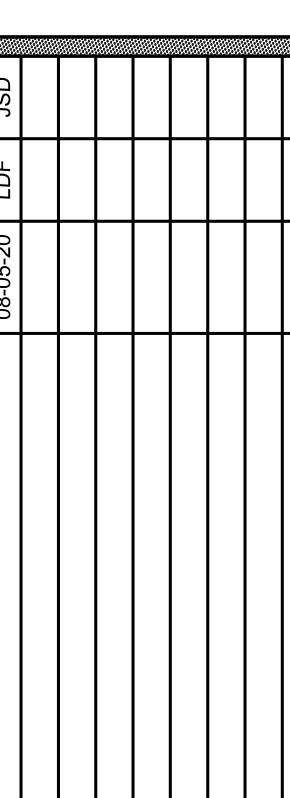

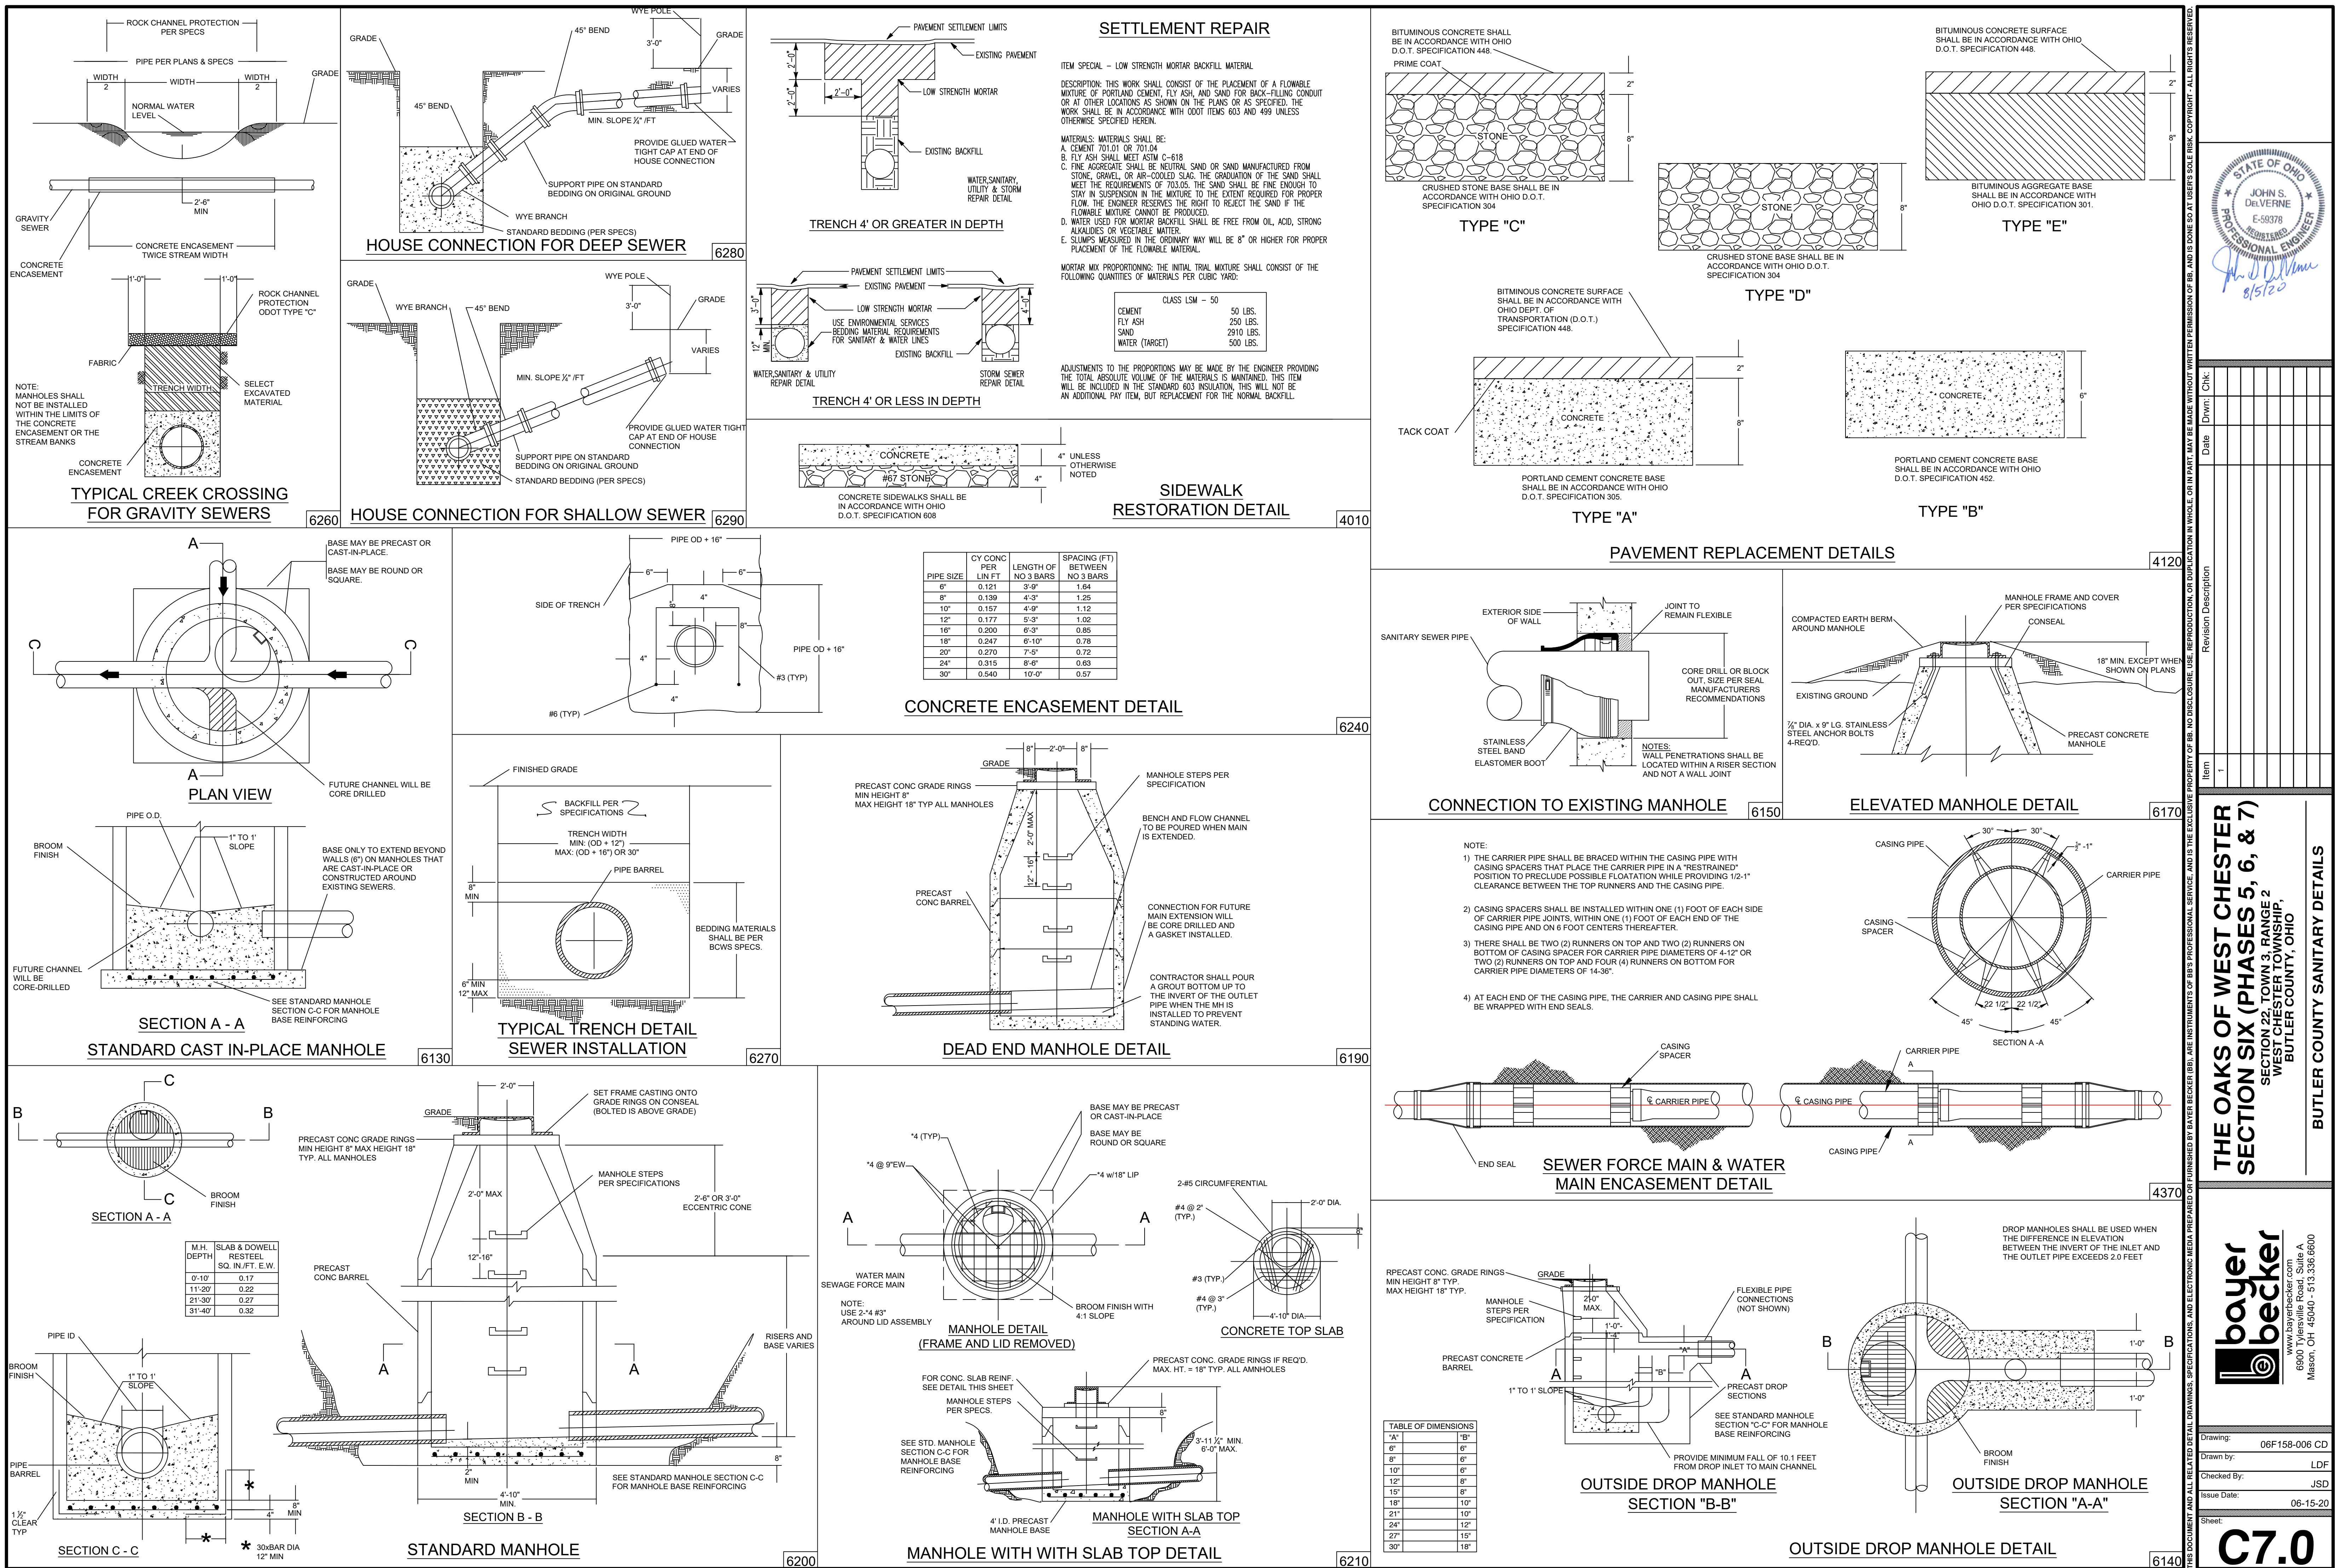WATER SERVICE DETAIL FOR "PANHANDLE" LOTS

BUTLER COUNTY WATER AND SEWER
130 HIGH STREET
HAMILTON, OH 45011
TELEPHONE: 513-887-3066
FAX: 513-887-3777


5300

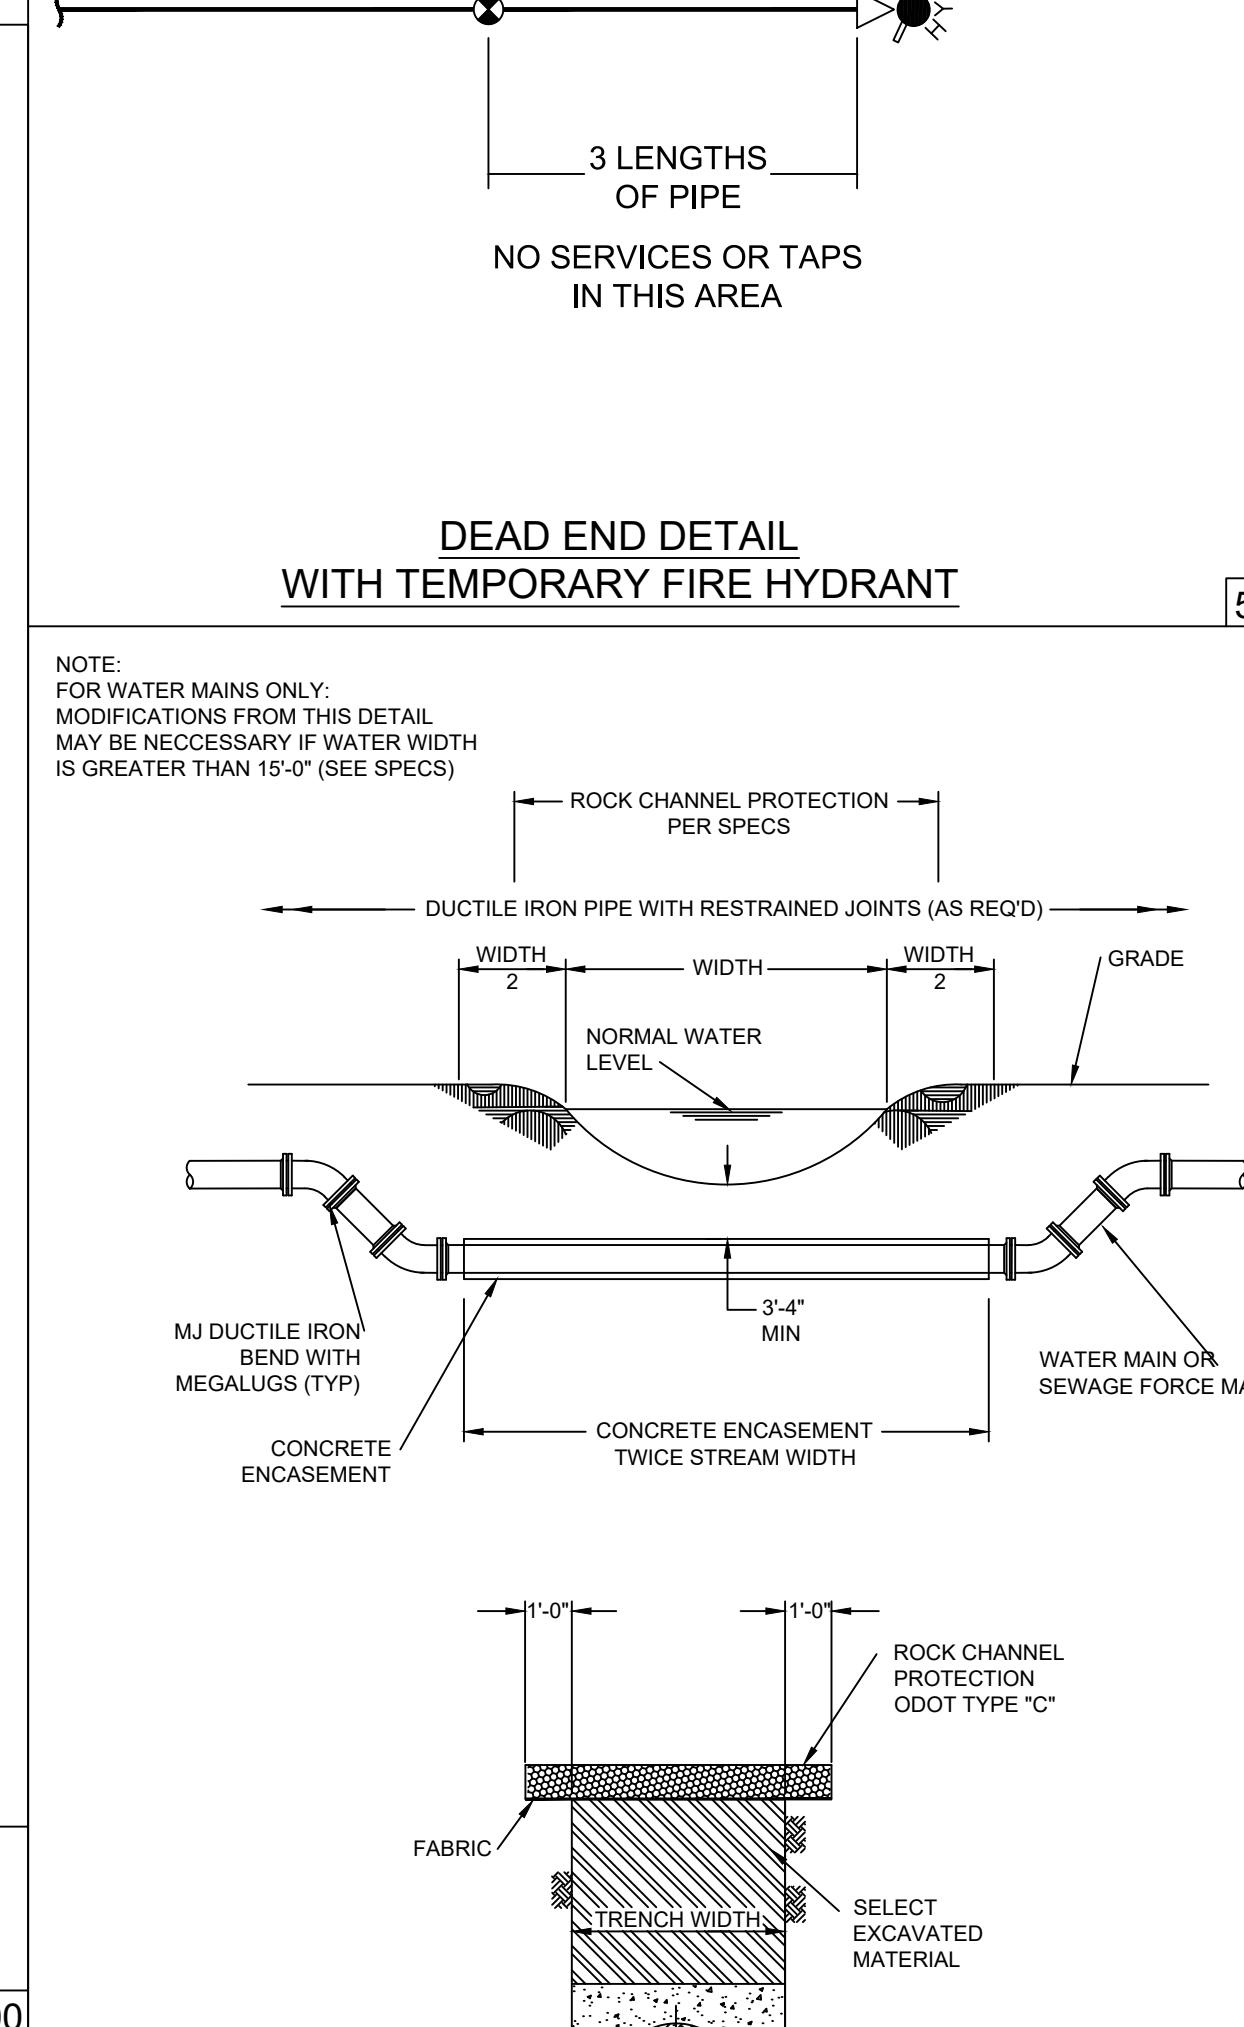

DEAD END DETAIL WITH TEMPORARY FIRE HYDRANT

NOTE: FOR WATER MAINS ONLY. MODIFICATIONS FROM THIS DETAIL MAY BE NECESSARY IF WATER WIDTH IS GREATER THAN 15'-0" (SEE SPECS)


5140

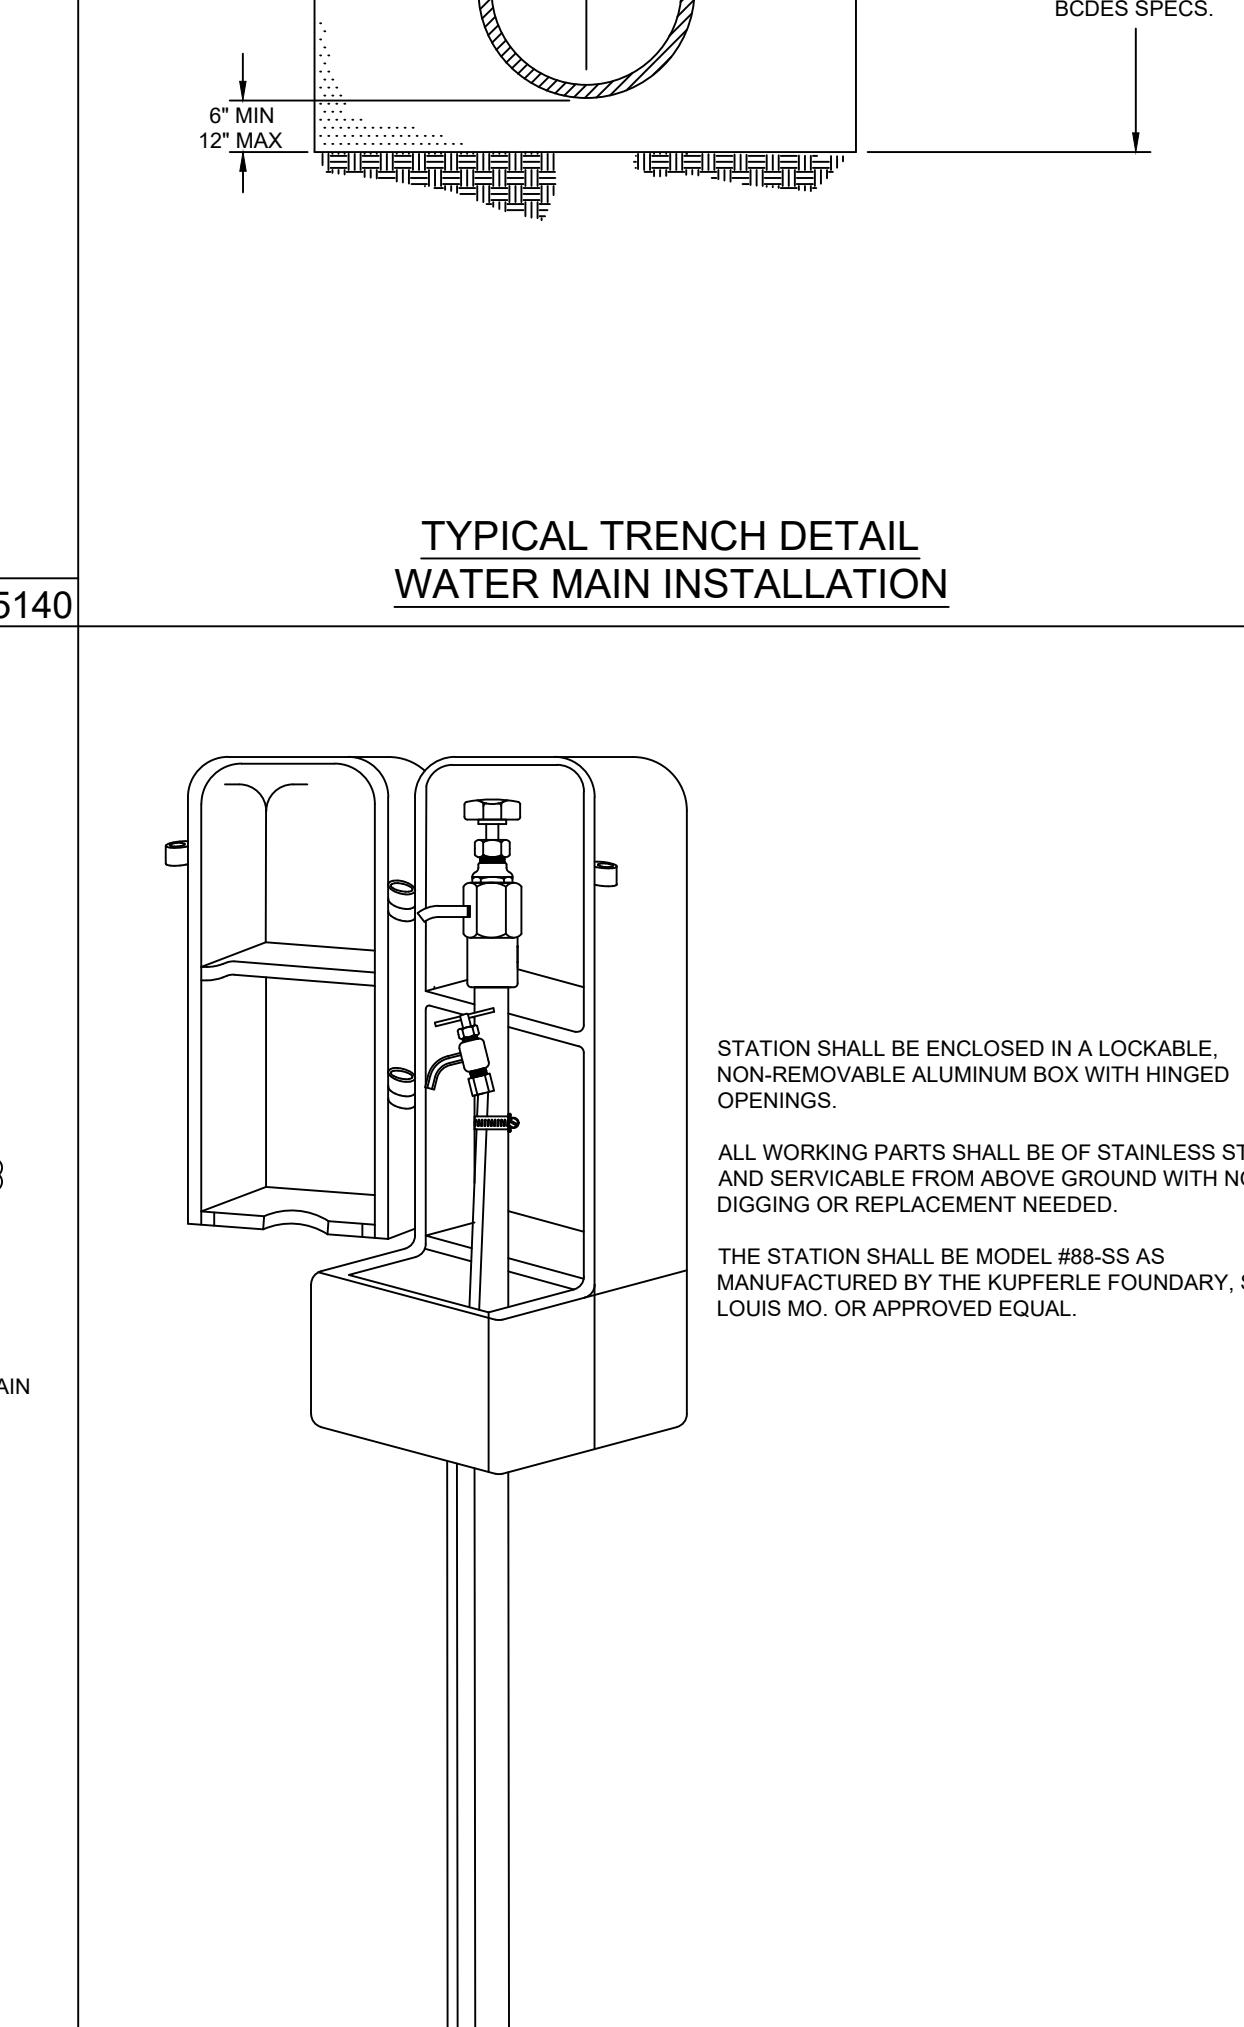

TYPICAL TRENCH DETAIL WATER MAIN INSTALLATION

STATION SHALL BE ENCLOSED IN A LOCKABLE, NON-REMovable ALUMINUM BOX WITH HINGED OPENINGS.
ALL WORKING PARTS SHALL BE OF STAINLESS STEEL AND SERVICABLE FROM ABOVE GROUND WITH NO DIGGING OR REPLACEMENT NEEDED.
THE STATION SHALL BE MODEL #98-SS AS MANUFACTURED BY THE KUPERLE FOUNDRY, ST. LOUIS MO. OR APPROVED EQUAL.


5280

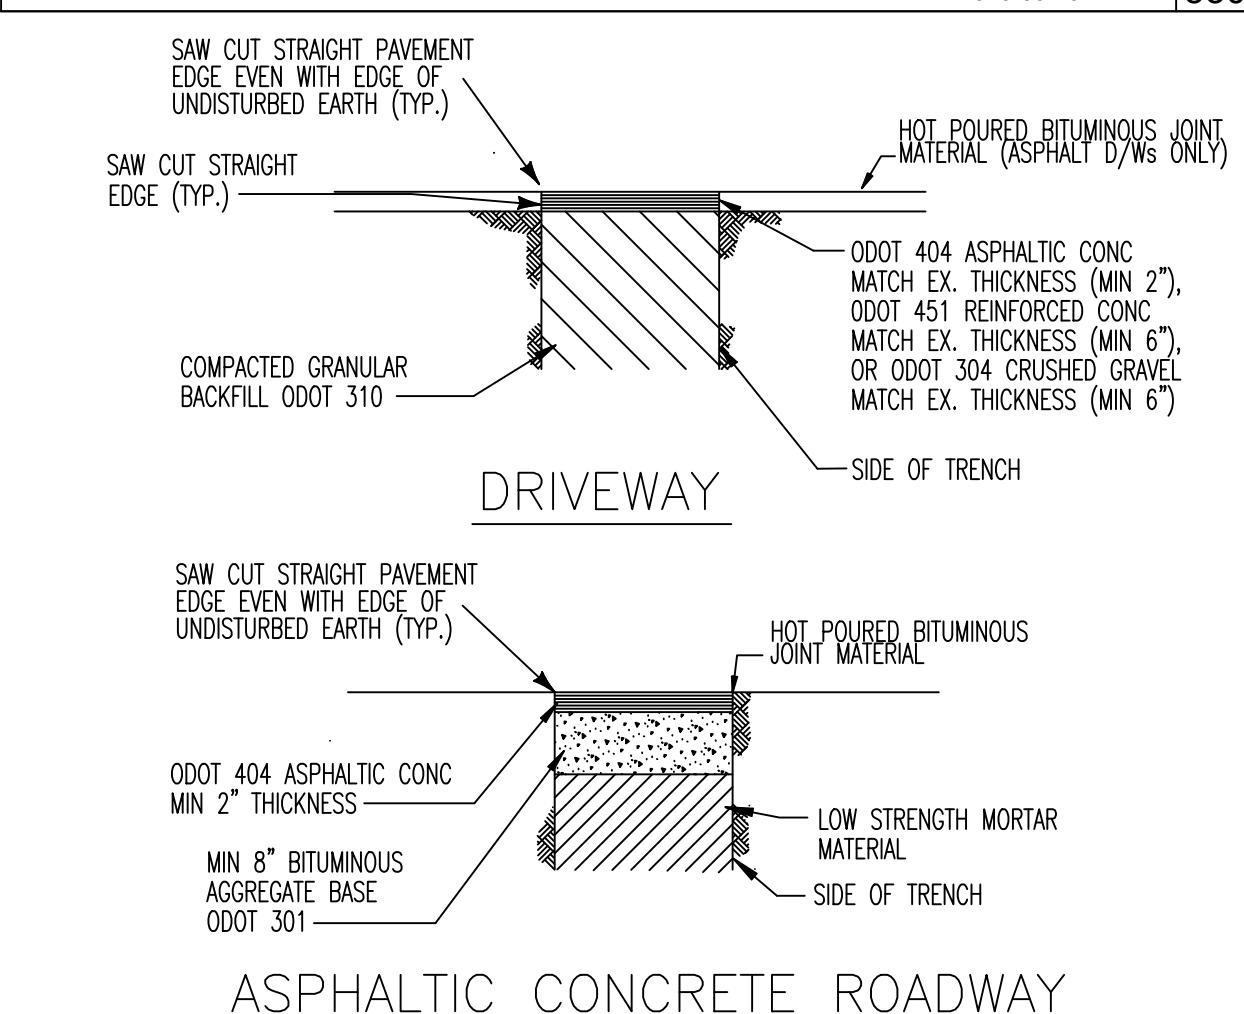

ASPHALTIC CONCRETE ROADWAY

PIPE SIZE	C.Y. CONC. PER LIN. FT.	LENGTH OF NO. 3 BARS	SPACING (FT) BETWEEN NO. 3 BARS
6"	0.121	3'-9"	1.64
8"	0.139	4'-3"	1.25
10"	0.157	4'-9"	1.12
12"	0.200	5'-3"	1.02
16"	0.247	6'-10"	0.85
20"	0.270	7'-5"	0.78
24"	0.315	8'-6"	0.72
30"	0.540	10'-0"	0.57


500

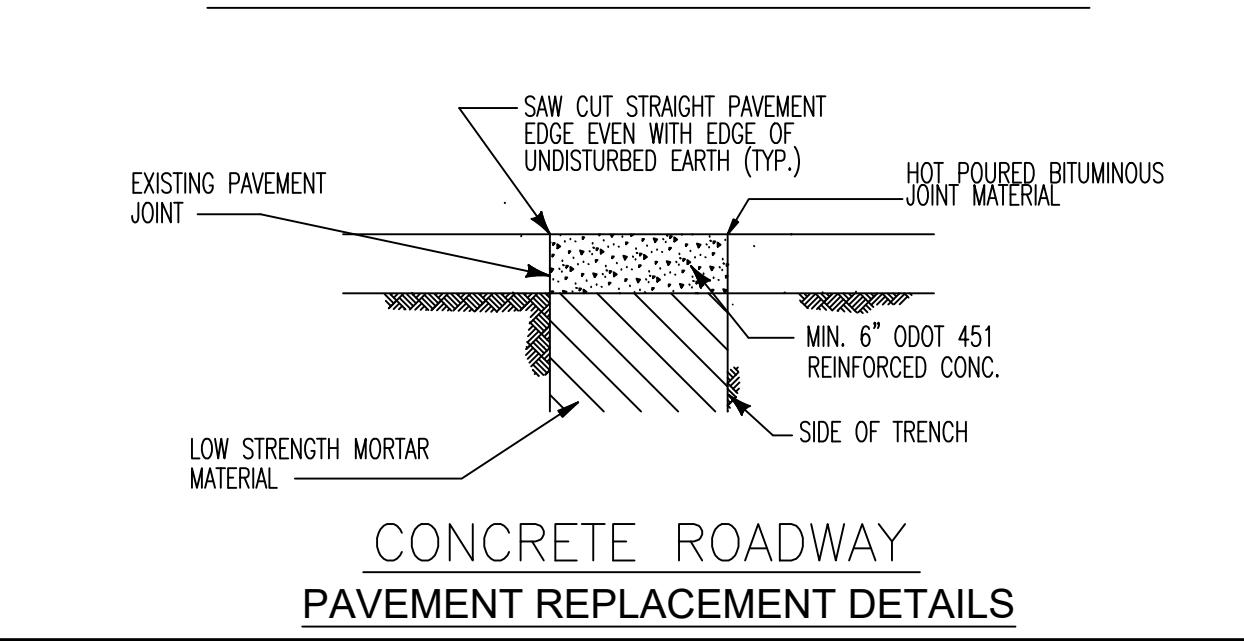

CONCRETE ROADWAY PAVEMENT REPLACEMENT DETAILS

NOTE:
 1) PIPE LESS THAN OR EQUAL TO 12" MUST USE 3/4" CORP. STOP, ANGLE BALL VALVE AND SERVICE PIPE.
 2) PIPE GREATER THAN 12" TO USE 1" CORP. STOP, ANGLE BALL VALVE AND SERVICE PIPE.


5290

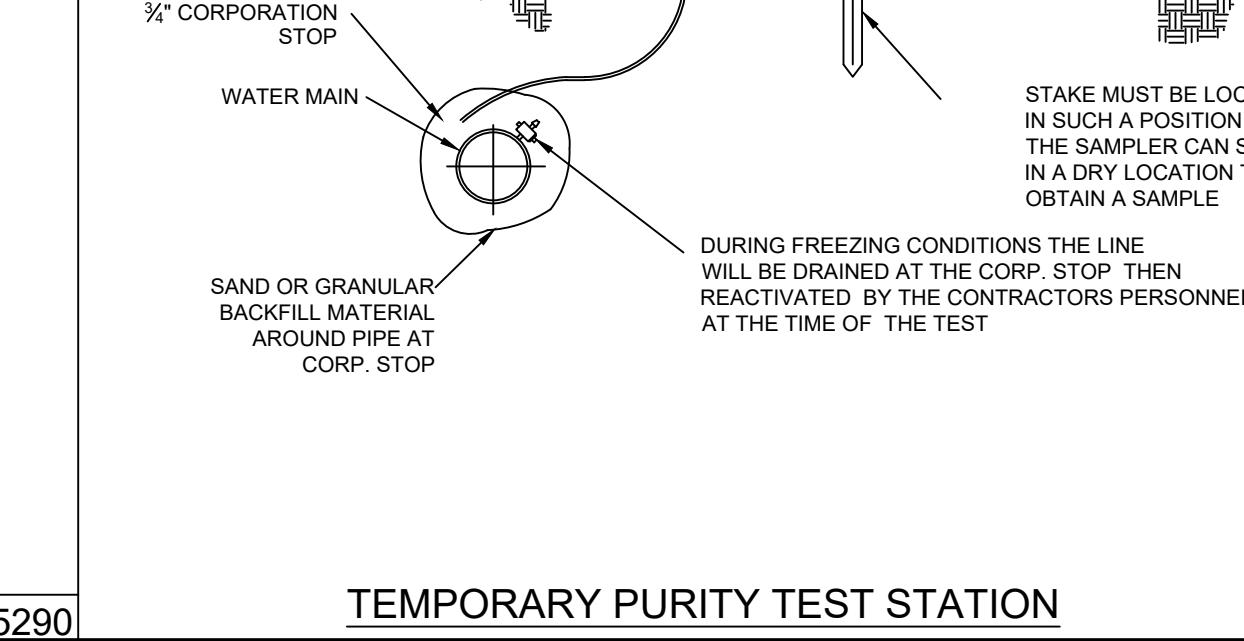

TEMPORARY PURITY TEST STATION

DURING FREEZING CONDITIONS THE LINE WILL BE DRAINED AT THE CORP. STOP THEN REACTIVATED BY THE CONTRACTORS PERSONNEL AT THE TIME OF THE TEST


5260

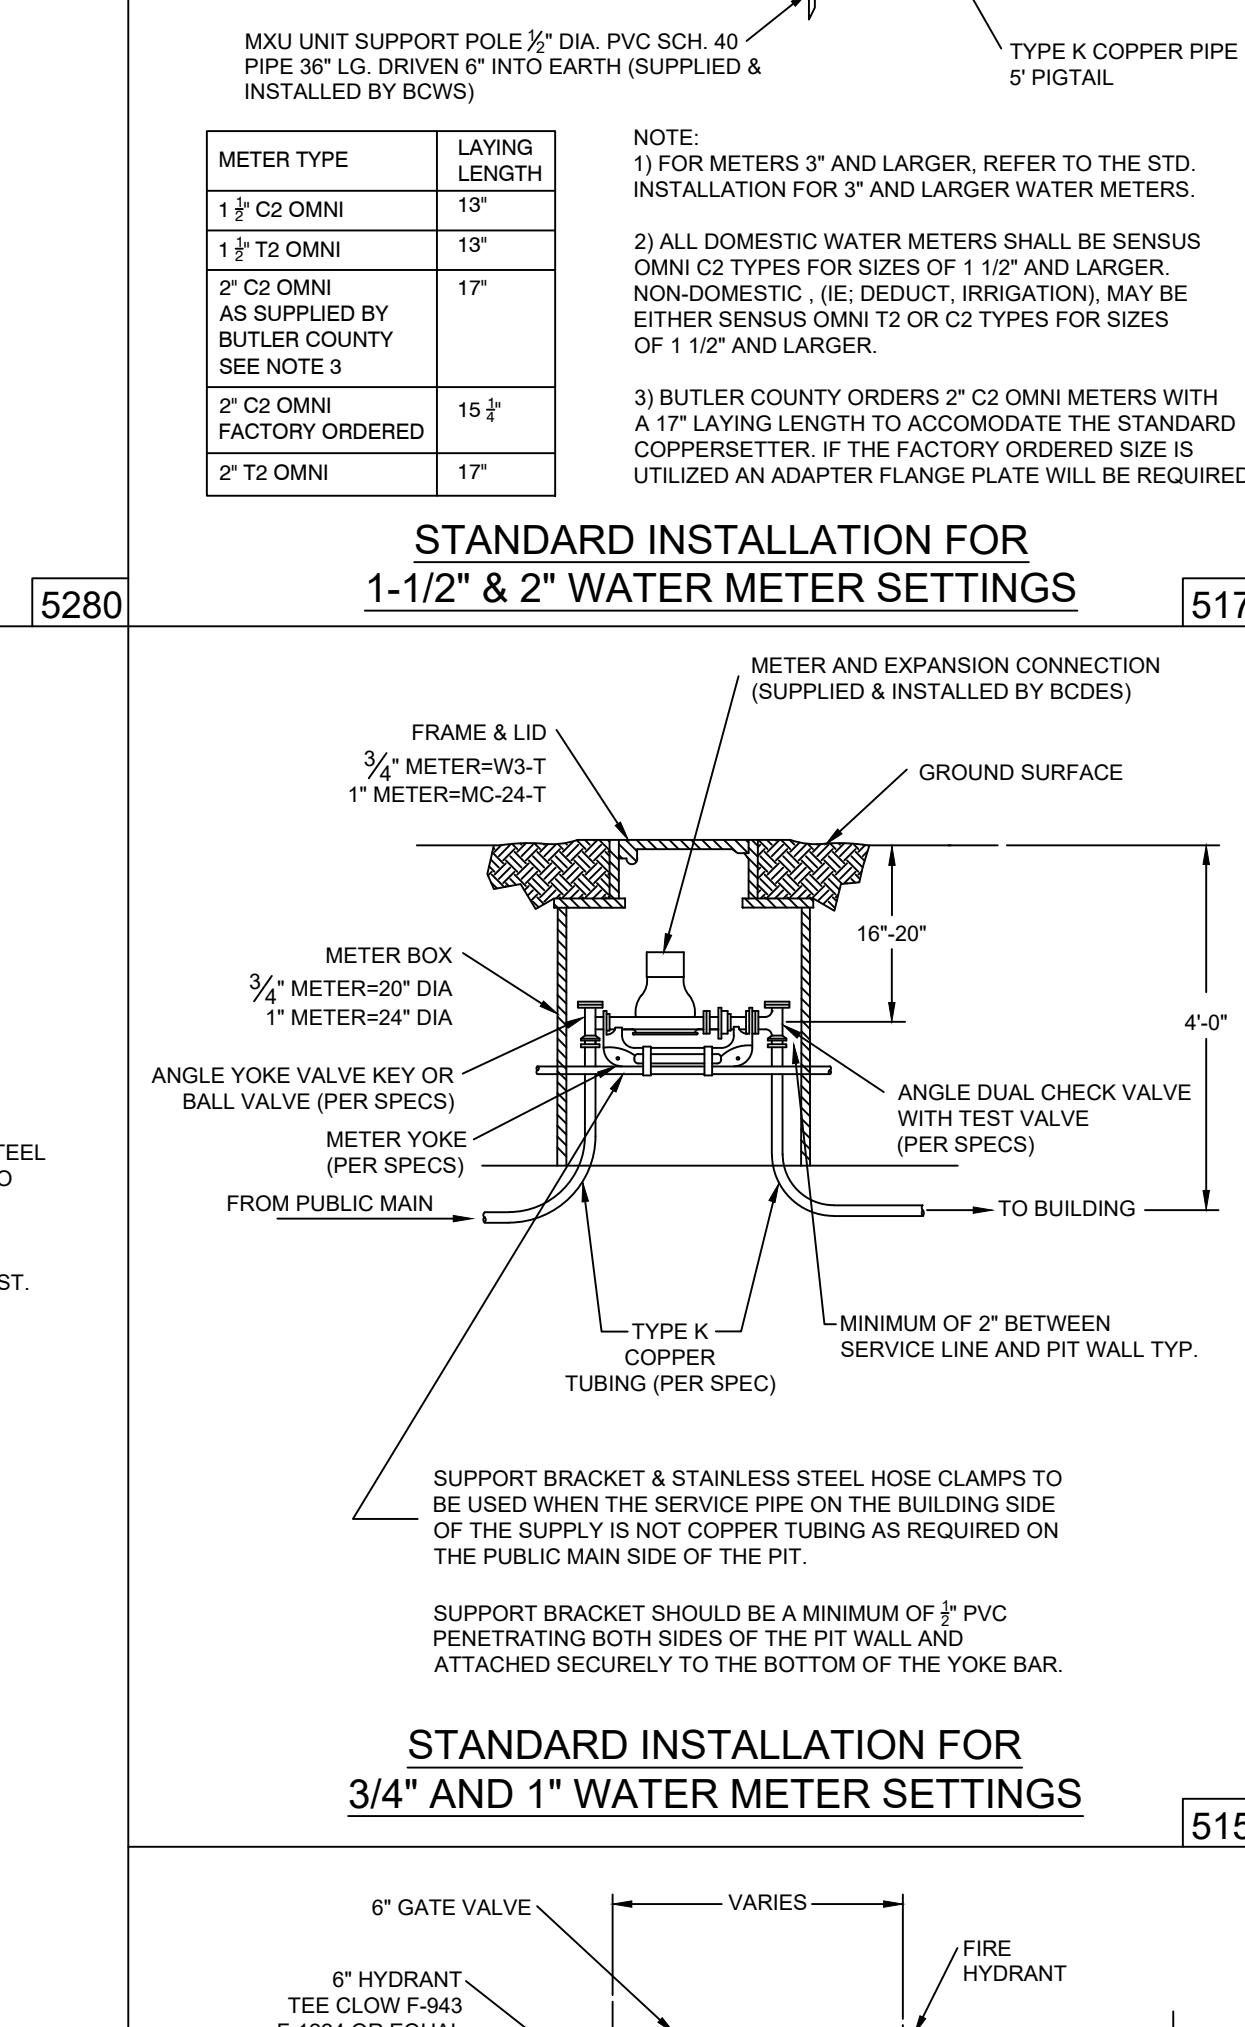

STANDARD INSTALLATION FOR 1-1/2" & 2" WATER METER SETTINGS

NOTE: 1) FOR METERS 3" AND LARGER, REFER TO THE STD. INSTALLATION FOR 3" AND LARGER WATER METERS.
 2) ALL DOMESTIC WATER METERS SHALL BE SENSUS OMNI C2 TYPES FOR SIZES OF 1 1/2" AND LARGER NON-DOMESTIC, (IE, DEDUCT, IRRIGATION, MAY BE EITHER SENSUS OMNI T2 OR C2 TYPES FOR SIZES OF 1 1/2" AND LARGER.
 3) BUTLER COUNTY ORDERS 2" C2 OMNI METERS WITH A 17" LAYING LENGTH TO ACCOMMODATE THE STANDARD COPPERSETTER. IF THE FACTORY ORDERED SIZE IS UTILIZED AN ADAPTER FLANGE PLATE WILL BE REQUIRED.


5170

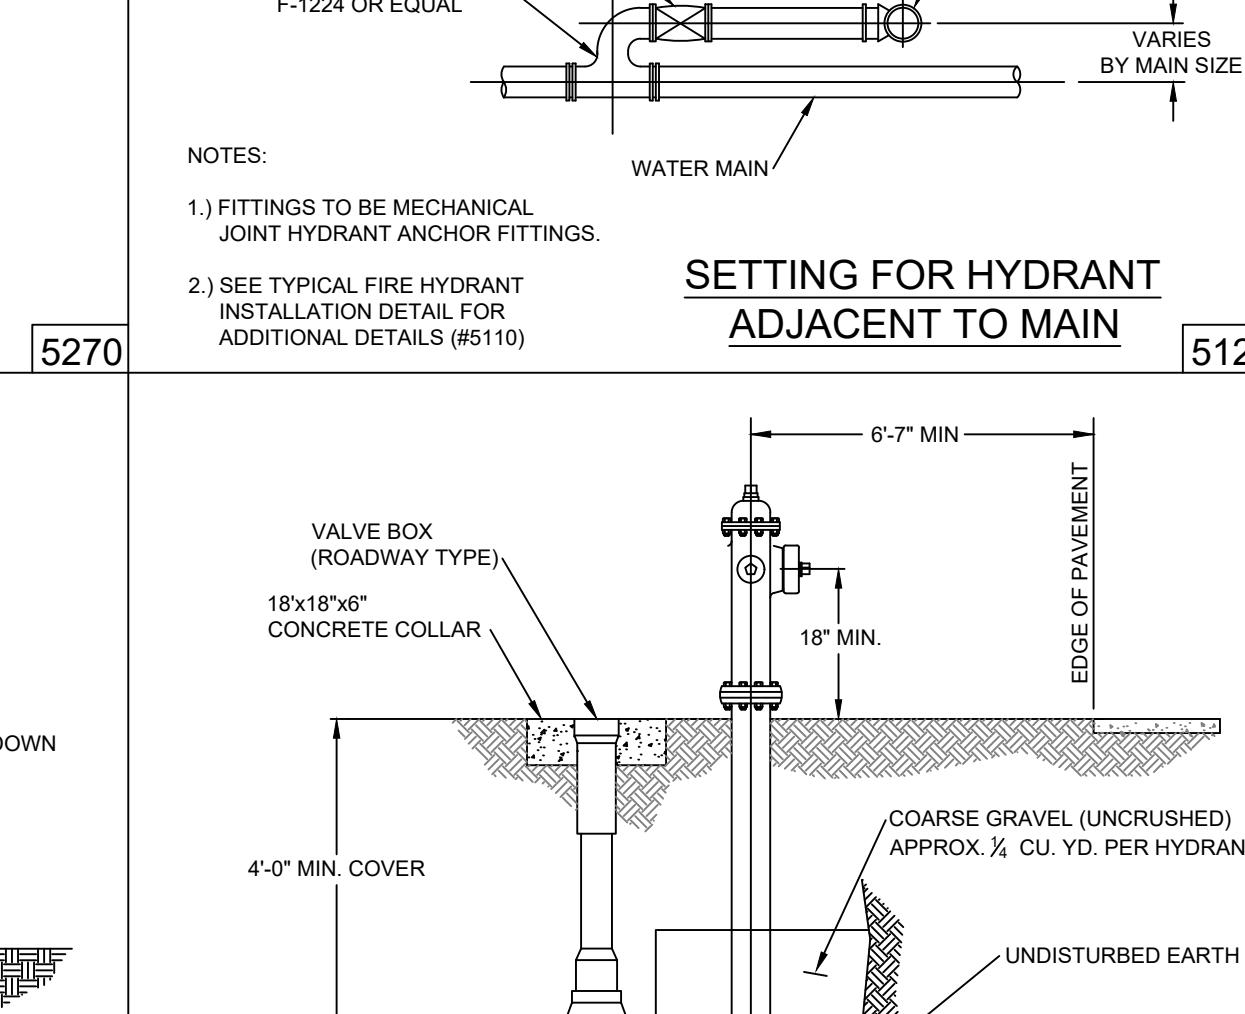

STANDARD INSTALLATION FOR 3/4" AND 1" WATER METER SETTINGS

NOTES:
 1.) FITTINGS TO BE MECHANICAL JOINT HYDRANT ANCHOR FITTINGS.
 2.) SEE TYPICAL FIRE HYDRANT INSTALLATION DETAIL FOR ADDITIONAL DETAILS (R5110)

5150

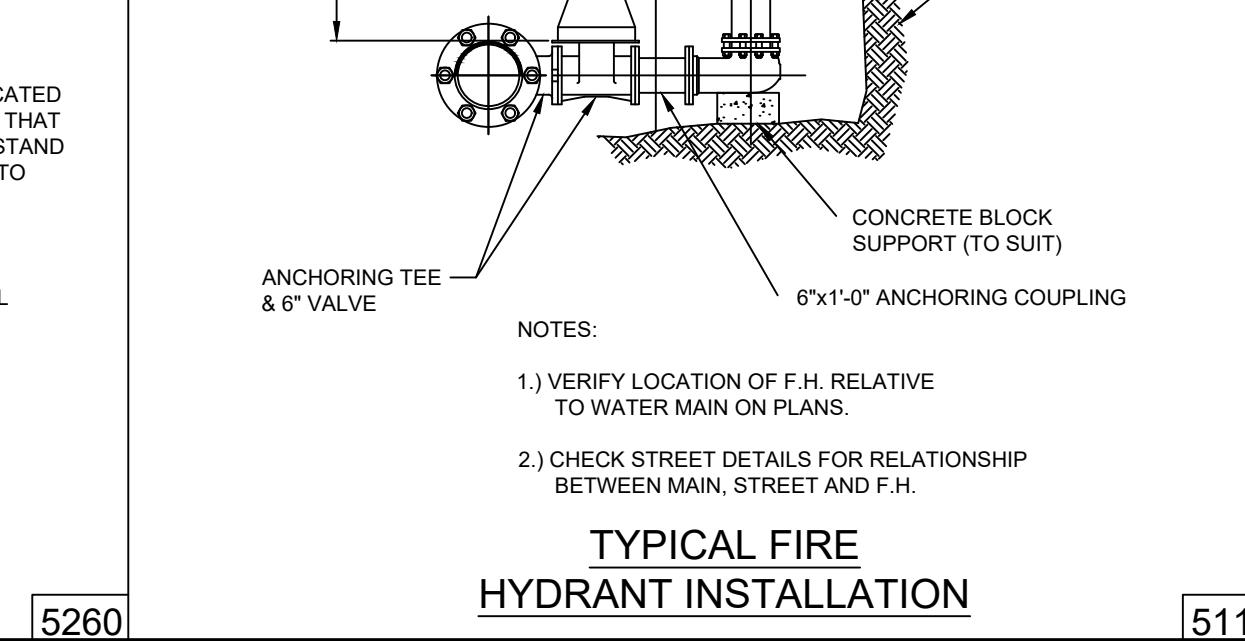

THE OAKS OF WEST CHESTER SECTION SIX (PHASES 5, 6, & 7)

NOTES:
 1.) VERIFY LOCATION OF F.H. RELATIVE TO WATER MAIN ON PLANS.
 2.) CHECK STREET DETAILS FOR RELATIONSHIP BETWEEN MAIN, STREET AND F.H.

5110

bayer becker
 www.bayerbecker.com
 6900 Tyerville Road Suite A
 Mason, OH 45040 - 513.336.6600

Drawing: 06F158-006 CD
 Drawn by: LDF
 Checked By: JSD
 Issue Date: 06-15-20
 Sheet: C7.1

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STATE OF OHIO
 JOHN S.
 DELVERNE
 E-59378
 PROFESSIONAL ENGINEER
 John S. Delverne
 8/5/20

