Stormwater Management

Dunkin Liberty Township

4969 Princeton Road
Liberty Township, Ohio
Butler County
Latitude 39°23'16.54"N Longitude 084°27'16.19"W

Prepared By:

Land Consultants

314 Front Street Lawrenceburg, Indiana 47025 (812) 537-2145

> In Association With

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March, 2021

3/9/2021

Jeffrey E. Talkers, P.E. #53383

Date

Prepared For:

Gilligan Company LLC

3805 Edwards Road Suite 680 Cincinnati, Ohio 45209

Dunkin 4969 Princeton Road Liberty Township, Ohio Butler County

Aerial Photo (Prior to proposed additional Development)





Project Summary:

Existing Conditions:

This subject parcel contains 0.998 acres of land. The existing site is currently vacant and previously undeveloped. There is an existing catch basin located in the southeast corner of the site that captures most of the acreage of the site as the existing contours generally slope in a southeasterly direction. This catch basin is the first in a series of basins that drain thru the adjacent lot to the south and then into a shared detention pond that was designed and constructed as part of Princeton Landings. Princeton Landings is a 4 lot subdivision that includes the subject lot. The detention for the subject lot was accounted for with the construction of the shared detention ponds. The undeveloped lot is completely covered in grass. This undeveloped portion generally drains via sheet flow in a south easterly direction towards the right-of-way of Princeton Glendale Road. Prior to reaching the Right-of-Way the runoff from the site drains into an on-site catch basin as noted previously and then continues in a private system for approximately 189' before it is outletted into an existing detention pond that was designed to handle the runoff from approximately 2.40 acres of the eastern portion of the Princeton Landings Development.

Proposed Conditions:

The existing undeveloped land will be improved by constructing a new Dunkin Restaurant and Drive-Thru and associated asphalt for access drives and parking. Upon completion of the construction the site will contain approximately 0.57 acres of impervious surface while 0.43 acres or 43% will remain as lawn or landscaped areas.

Additional on-site catch basins will be installed to capture the stormwater drainage from the impervious areas as well as from the rooftops. Approximately .09 Acres mostly comprised of green space from a grassed island will runoff the site to the west and into the previously developed portion of Princeton Landings and a small area approximately 0.07 acres located on the west side of the proposed public sidewalk will runoff into the Princeton-Glendale Road right-of-way. The original grading plan for Princeton Landings does allow for and show these areas of the site as direct drainage in the manor being proposed by this development.

Analysis Summary:

The detention pond that was built at part of Princeton Landings was designed to handle the stormwater from the subject lot. The infrastructure to convey the stormwater to the pond was constructed as part of the original construction. The proposed runoff from this site is has been quantified and the existing infrastructure has been proven to have plenty of capacity to convey the runoff of this site to the detention basin. Detailed information follows.

Storm Sewer Computation Sheet- On-site & Off-Site Storm Sewer

Dunkin Liberty Township

4969Princeton Road

March 2021

Job # 134-20

*this worksheet assumes that the pipe installed is HDPE Smooth interiour Pipe n=0.012

	DRAINAC	GE AREA		ACTUAL (10 year storm)			PIPE INFORMATION			CAPACITY		İ	
	INLET	SUM			time in		SYSTEM				(full flo	ow)	
MH/CB	AREA(A)	AREA(A)	С	tc	pipe	i	Q	L	s	D	V	Q	
Number	acre	acre		min	min	in/hr	cfs	ft	%	in	fps	cfs	
Dunkin													
CB#3 - Exist CB#603	0.09	0.09	0.65	10.00	0.12	5.50	0.32	104	8.75	12	14.54	11.42	Pipe informa Fieldwork ex below.
CB#1 - CB#2	0.08	0.08	0.65	10.00	0.30	5.50	0.29	127	2.00	12	6.95	5.46	
CB#2 - CB#4	0.36	0.44	0.65	10.30	0.08	5.50	1.57	37	2.50	12	7.77	6.10	
CB#4 - Exist CB#603	0.15	0.59	0.65	10.38	0.11	5.50	2.11	85	7.16	12	13.15	10.33	
CB#603-MH#1	0.16	0.84	0.65	10.49	0.08	5.50	3.00	55	5.98	12	12.02	9.44	
UC Medical	1										<u> </u>		1
CB#3-CB#2-MH#1	0.26	0.26	0.80										1
Princeton Landings	1												_
MH#1-CB#602	0.00	1.10	0.80	10.57	0.13	5.50	4.84	72	3.55	12	9.26	7.27	Pipe informa Princeton La dated April 2
CB#602-#601	0.25	1.35	0.80	10.70	0.08	5.50	5.94	27	0.56	24	5.84	18.34	
CB#601-#HW600	1.05	2.40	0.80	10.77	0.11	5.50	10.56	35	0.49	24	5.46	17.15	
	0.25 Acres from UC Medical Site and the remainder 0.80 Acres from the Princeton Glendale Road right-of-way,												
	including	the 0.07ac	res of di	irect draina	age from tl	ne subjed	ct site.	Ī	T	l		<u> </u>	
	Our field	work show	ws this	pipe to be	2 15" but	 	sed for cal	L culation	s to be	<mark>conserva</mark>	tive and assur	re there is	8
	capacity, since prior plans called for this to be a 12" pipe.												

 $_{\text{n= 0.012}}$ HDPE CB=Catchbasin MH=Manhole $_{\text{n= 0.013}}$ CONC HW=Headwall

Proposed Drainage Map Site Contains 0.998 Acres (43,477 Sf)

Area Summary

Dunkin

Site Contains 1.00 Acres

0.84 Acres Drains into the storm system

0.07 Acres Drains East into the Princeton Glendale ROW

0.09 Acres Drains West into Princeton Landings

These drainage patterns follow the intent of the grading plan from Princeton Landings which was the Original Development. The grading plan from the archieved set of plans are attached for reference.

UC Medical


Site Contains 0.76 Acres


For purposes of analyzing the capacity of the common drainage system which outlets to the shared detention pond, we have assummed the following acreage breakdown. We have also assigned a coefficient of c=0.8

0.26 Acres drains into Manhole #1 from UC site0.25 Acres is added at CB#6020.25 Acres of mostly the access road is added at CB#601


- · Areas shaded gray will be green space and landscruped 0.43 Acres (43%)
- · Remainder of site will be impervious 0.57 Acres (57%)


Cw = 0.65 (Excludes direct drainage (dd)) Strip Center

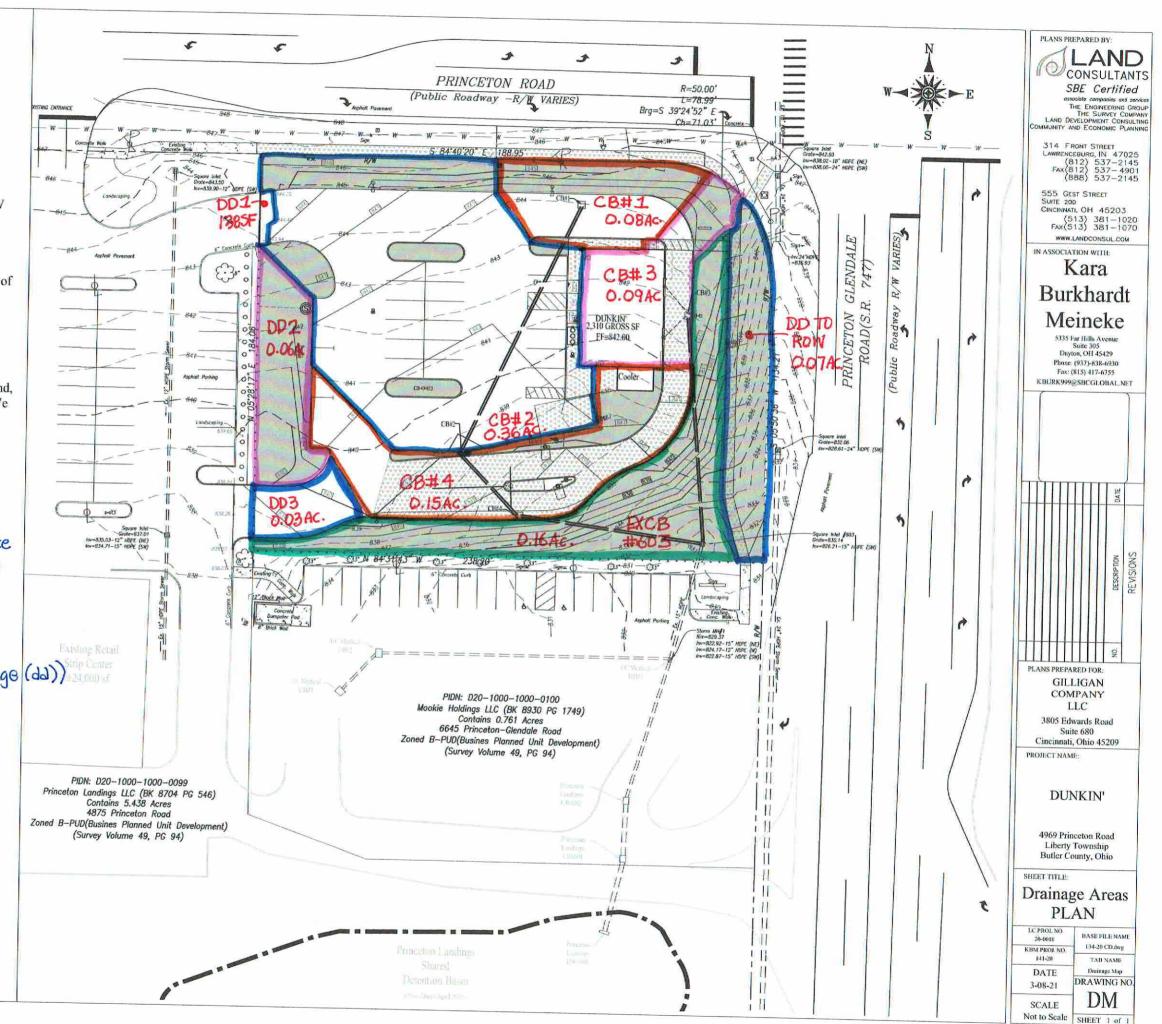

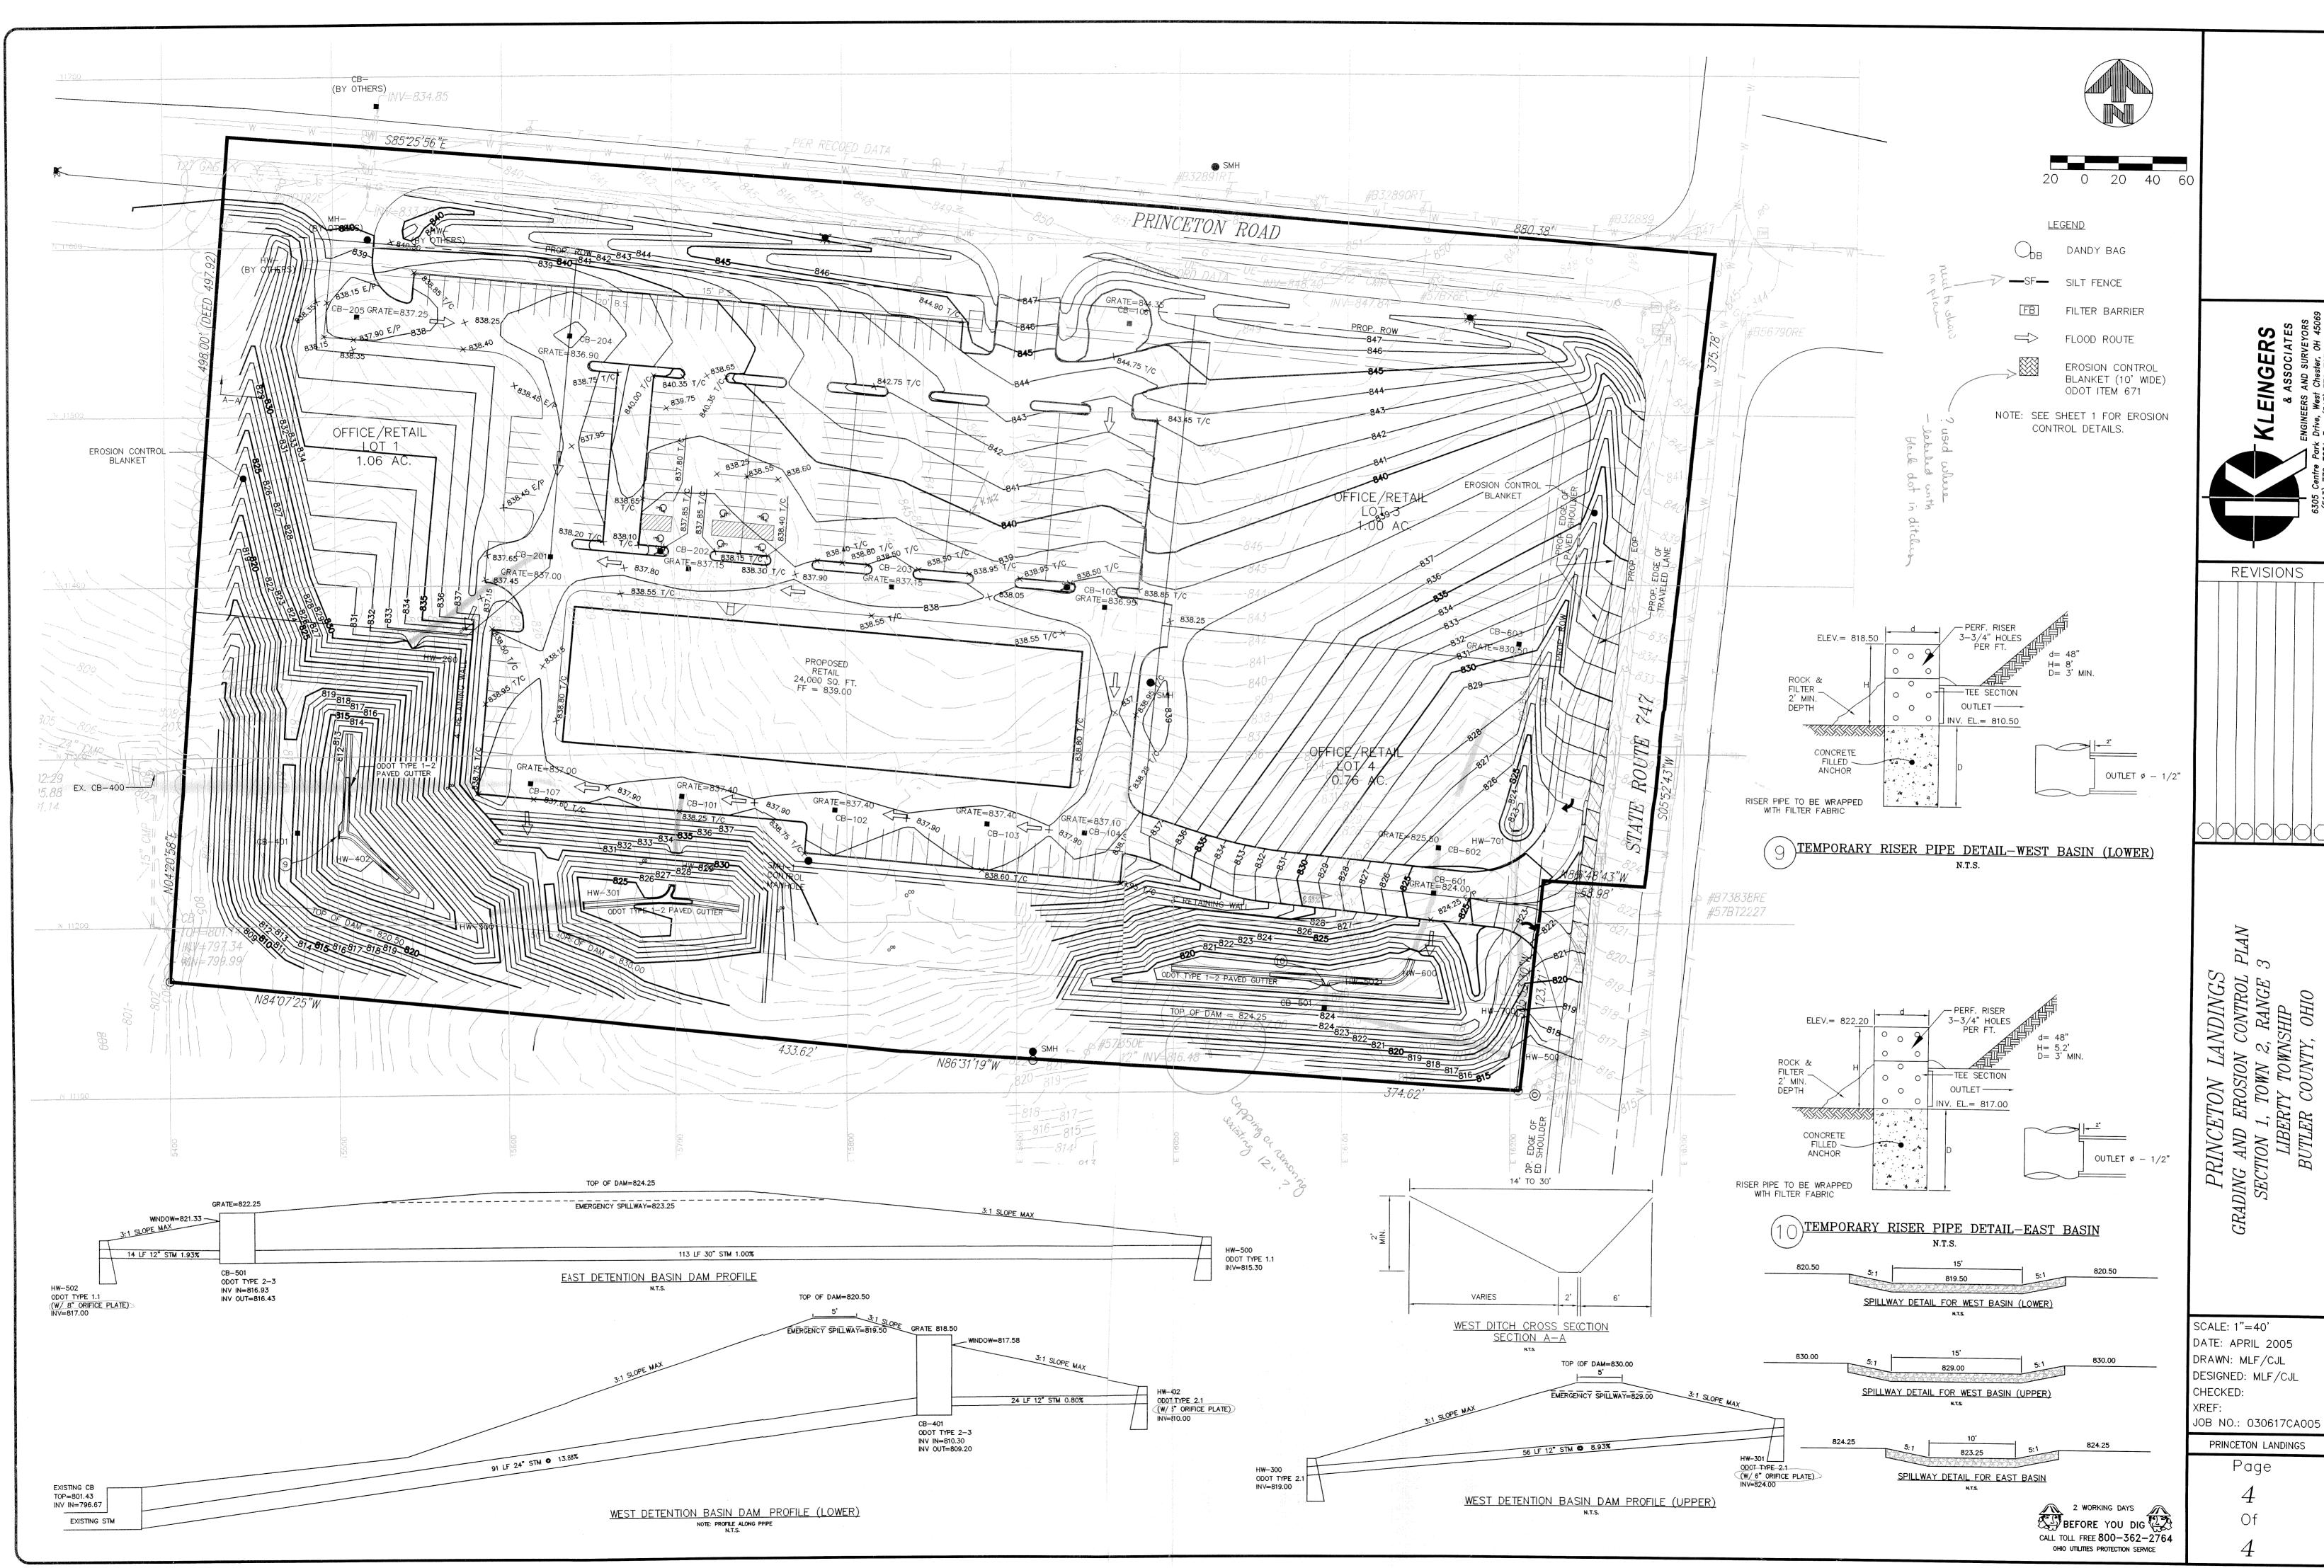

PRINCETON LANDINGS

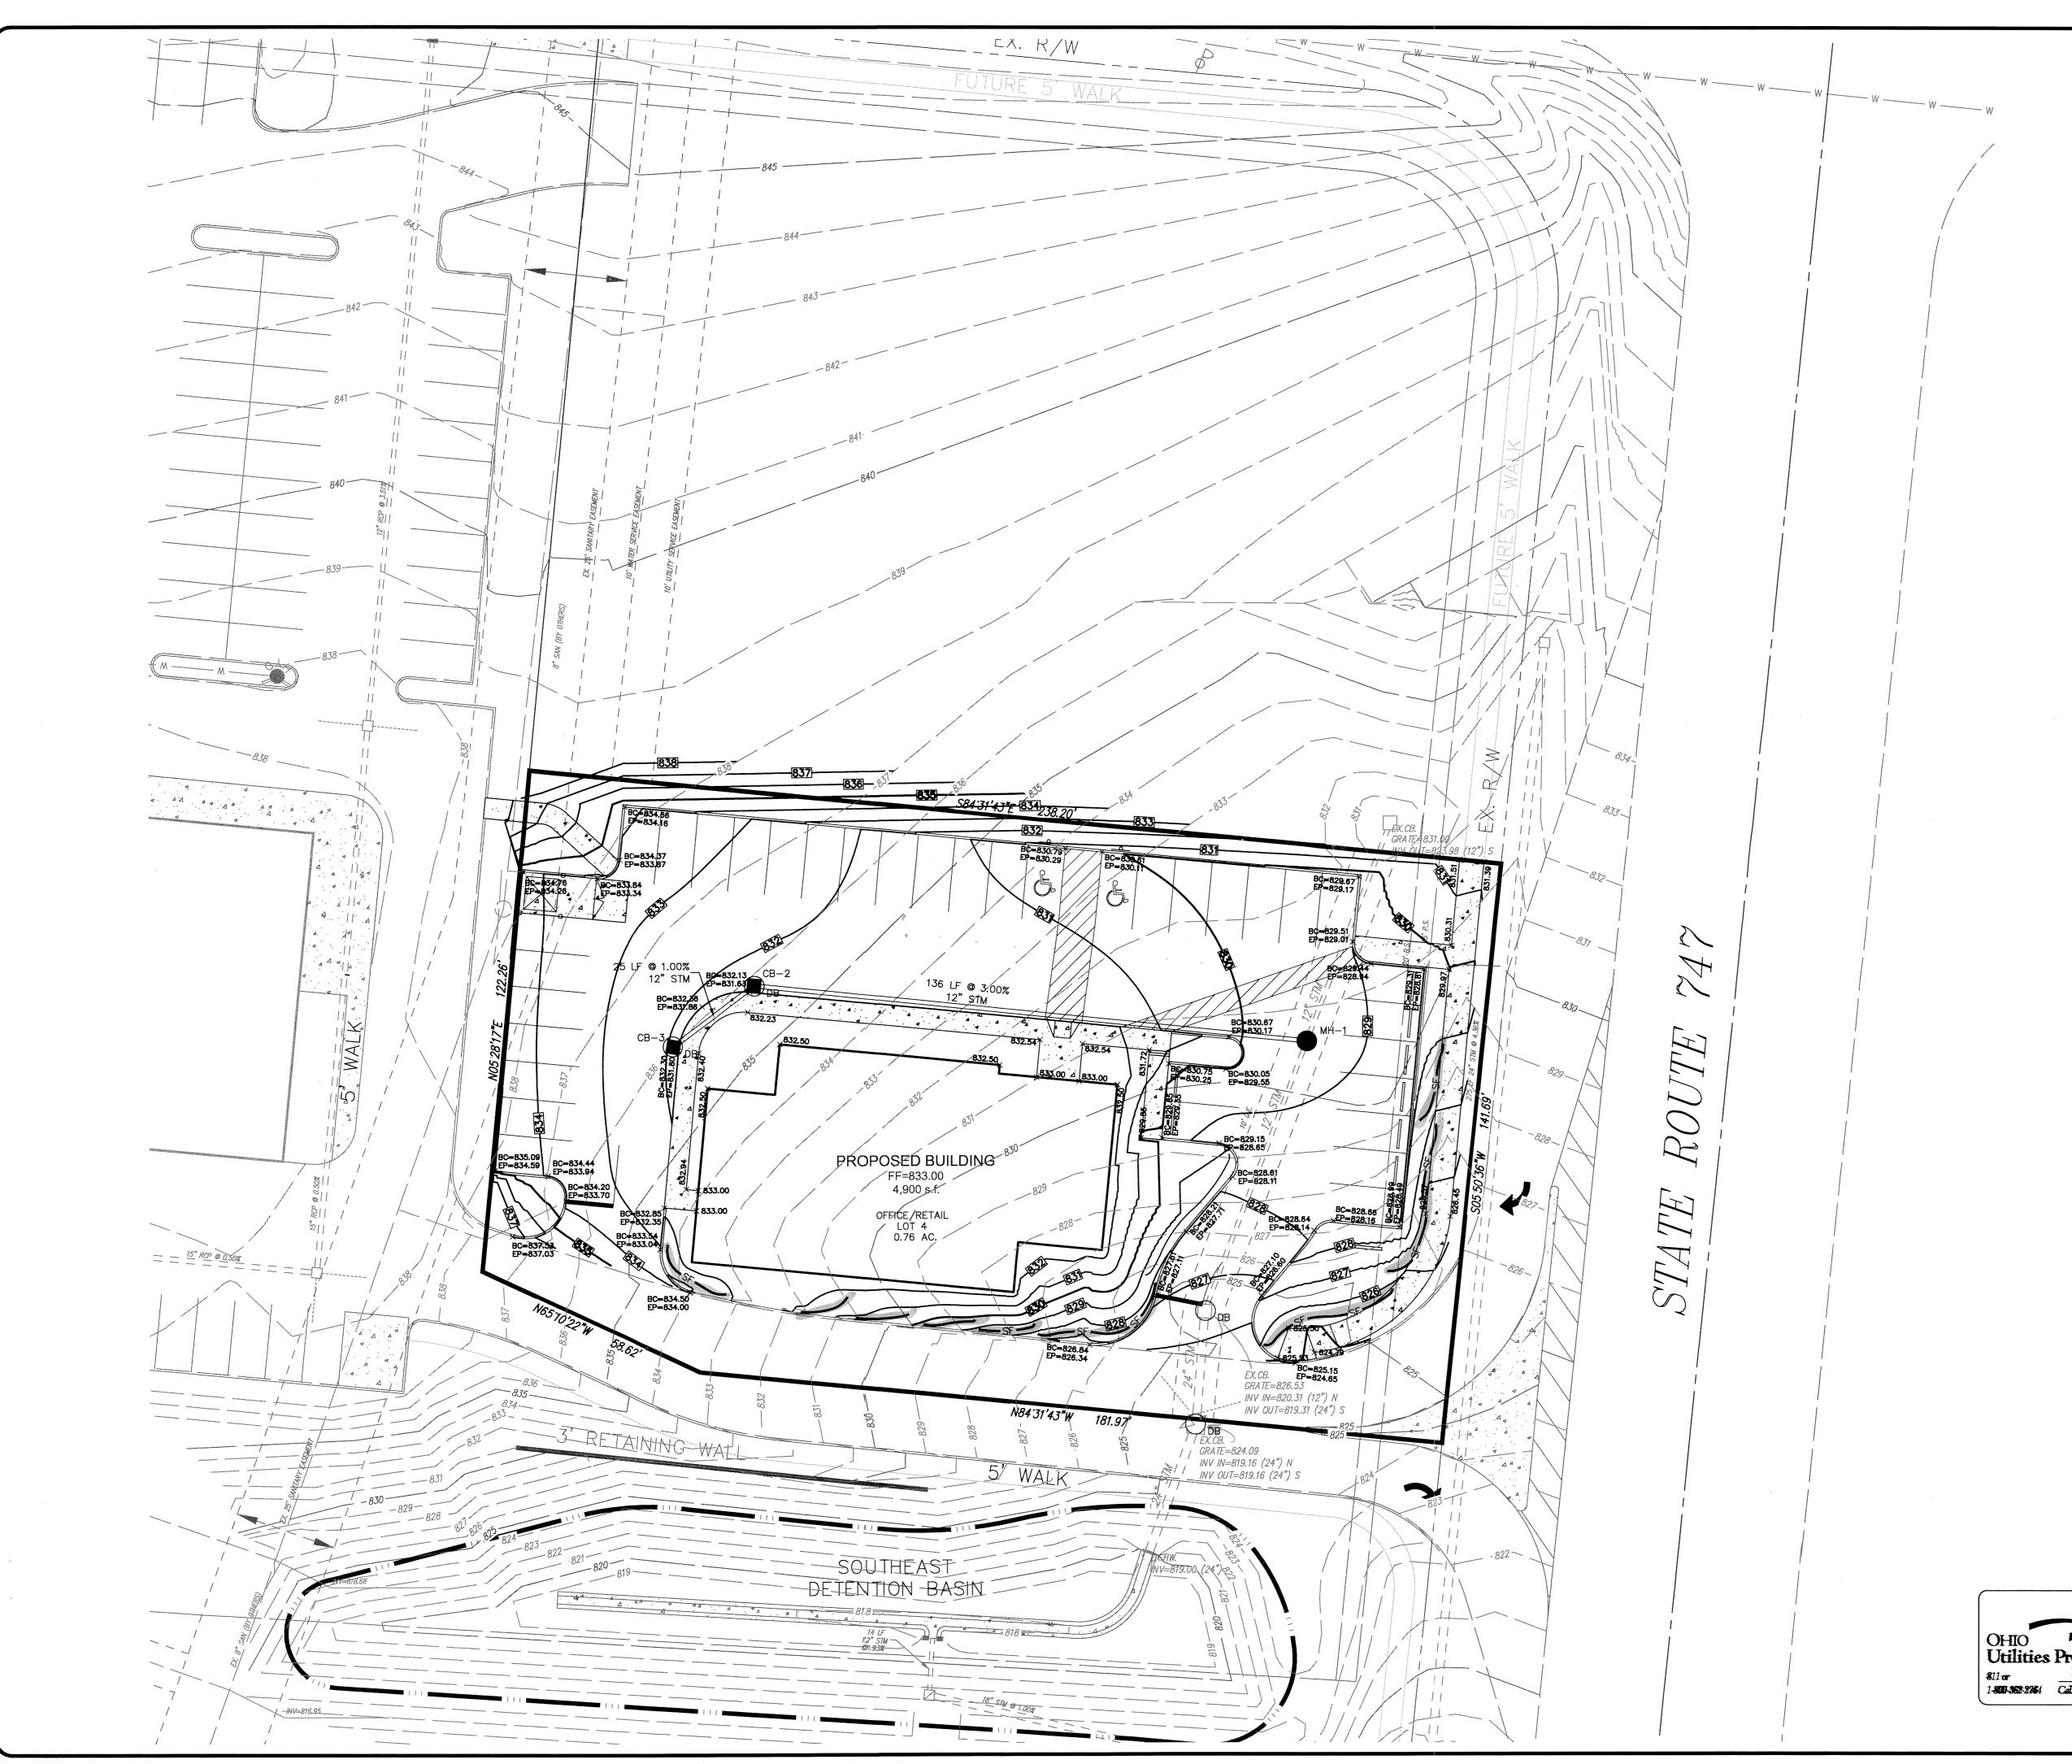

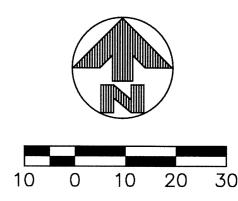


EROSION CONTROL LEGEND

CHECK DAM



NOTE: UNDERGROUND UTILITIES ARE PLOTTED FROM A COMPILATION OF AVAILABLE RECORD
INFORMATION AND SURFACE INDICATIONS OF
UNDERGROUND STRUCTURES AND MAY NOT BE
INCLUSIVE. PRECISE LOCATIONS AND THE
EXISTENCE OR NON EXISTENCE OF
UNDERGROUND UTILITIES CANNOT BE VERIFIED. PLEASE NOTIFY THE OHIO UTILITY PROTECTION SERVICE AT 1-800-362-2764 BEFORE ANY PERIOD OF EXCAVATION OR CONSTRUCTION ACTIVITY.

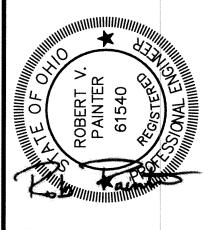








REVISIONS

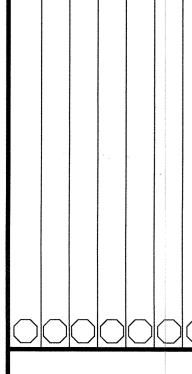

PLAN GRADING AL MEDIC

SCALE: 1"=20' DATE: JULY 16, 2014 DRAWN: SAD DESIGNED: SAD CHECKED: RVP

JOB NO.: 13060 UC MEDICAL CENTER

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