KLEINGERS & ASSOCIATES, INC.

Civil Engineers & Surveyors

6305 Centre Park Drive

WEST CHESTER, OHIO, 45069

LETTER OF TRANSMITTAL

Project #

	VV L.O I	OHLOTEH,	JI 110 43009		02/14/05		030617 005	
(513)779-7851 FAX (513)779-7852					Altention Eric Pottenger / Teresa Barnes			
·	Butler County Engineer's Office				RE: Princeton Landings			
	21 Fairgrove		<u> </u>	***************************************				
		Ave.			Dr	TOO FED 1 A	2005	
_Ha	amilton		OH 450	111	K	EC'D FEB 14	2003	
WE ARE SENDING YOU X Attached Under separate cov					via		the following items:	
> Shop Drawings Prints X Plans						Samples	Specifications	
-					<u> </u>	·	'	
L	Copy of I	·	Change Order					
COPIES	PIES DATE NO.					SCRIPTION		
4	02/14/05	/14/05 1-4/4 Princeton Landings Construc						
1	02/14/05	2/14/05 1 Local storm calculations and drainage map						
1	02/14/05	Detention Summary						
THESE	ARF TRAN	SMITTED as o	checked below	•				
THESE ARE TRANSMITTED as checked below: Approved as submitted Record 1							copies for approval	
		or your use		Approved as note	ed	Submit	copies for distribution	
	As	s requested		Returned for corr	rections	Return	corrected prints	
	F	or review and com	ment	- 7			_	
	F	OR BIDS DUE			20	PRINTS RETUI	RNED AFTER LOAN TO US	
REMARKS: Mr. Pottenger / Ms. Barnes,								
	design access	calculations, dr	ainage map, and velopment is sho	d detention sumn	nary. The culv	ert underneath Princ	Also, a copy of local storm ceton Road near the west e plans for the additional	
Please contact our office with any questions or comments.								
	Thanks and have a great day!							
COPY T	O FILE					Chart.		
						Matthew W S	pidare	

Date

1. ALL PLANS & CONSTRUCTION SHALL BE IN ACCORDANCE WITH CURRENT "RULES AND REGULATIONS" OF BUTLER COUNTY AND APPLICABLE OHIO DEPARTMENT OF TRANSPORTATION STANDARDS.

2. FORTY-EIGHT HOURS BEFORE DIGGING IS TO COMMENCE, THE CONTRACTOR SHALL NOTIFY THE FOLLOWING AGENCIES: THE OHIO UTILITY PROTECTION SERVICES (OUPS), AND ALL OTHER AGENCIES WHICH MAY HAVE UNDERGROUND UTILITIES INVOLVING THIS PROJECT AND ARE NON-MEMBERS OF OHIO

3. THE CONTRACTOR SHALL VERIFY LOCATION AND ELEVATION OF ALL EXISTING UTILITIES PRIOR TO THE BEGINNING OF CONSTRUCTION OR EARTH MOVING OPERATIONS.

CONTRACTOR SHALL OBTAIN A PERMIT FOR ALL CONSTRUCTION ACTIVITIES IN ACCORDANCE WITH LOCAL, STATE. & FEDERAL REGULATIONS.

THE CONTRACTOR IS TO PERFORM ALL INSPECTIONS AS REQUIRED BY THE OHIO EPA FOR THE

NATIONAL POLLUTANT DISCHARGE ELIMINATION SYSTEM (NPDES) PERMIT AND FURNISH OWNERS REPRESENTATIVE WITH WRITTEN REPORTS. OWNER WILL OBTAIN REPORTS. 6. ITEM NUMBERS REFER TO THE OHIO DEPARTMENT OF TRANSPORTATION CONSTRUCTION AND

MATERIAL SPECIFICATIONS, AND ALL CONSTRUCTION WORK SHALL BE DONE ACCORDING TO SAID SPECIFICATIONS AND IN ACCORDANCE WITH APPLICABLE STANDARDS OF THE BUTLER COUNTY. WHEN IN CONFLICT, THE COUNTY REQUIREMENTS SHALL PREVAIL.

7. SITE BUILDING PAD EXCAVATION AND CONSTRUCTION TO BE PER GEOTECHNICAL ENGINEERS RECOMMENDATIONS. BUILDING PAD PREPARATION SHALL BEGIN BY CLEARING & STRIPPING UNSUITABLE MATERIAL FROM PAD SITE. THEN PLACE & COMPACT BACKFILL MATERIAL AT GEOTECHNICAL ENGINEER'S RECOMMENDATIONS. ALL BACKFILL MATERIAL MUST BE ACCEPTABLE TO THE GEOTECHNICAL ENGINEER.

8. ALL FILL UNDER PAVEMENT SHALL BE COMPACTED TO THE GEOTECHNICAL ENGINEER'S RECOMMENDATIONS.

9. COMPACTED FILLS ARE TO BE MADE TO A MINIMUM OF THREE FEET ABOVE THE CROWN OF ANY PROPOSED SEWER PRIOR TO CUTTING OF TRENCHES FOR PLACEMENT OF SAID SEWERS. ALL FILLS SHALL BE CONTROLLED, COMPACTED, AND INSPECTED BY AN APPROVED TESTING LABORATORY OR AN INSPECTOR FROM THE APPROPRIATE GOVERNMENTAL AGENCY.

10. CONTRACTOR SHALL IMPLEMENT ALL SOIL AND EROSION CONTROL PRACTICES REQUIRED BY BUTLER COUNTY AND THE OHIO EPA.

11. ALL GROUND SURFACE AREAS THAT HAVE BEEN EXPOSED OR LEFT BARE AS A RESULT OF CONSTRUCTION AND ARE TO FINAL GRADE AND ARE TO REMAIN SO, SHALL BE SEEDED AND MULCHED AS SOON AS PRACTICAL IN ACCORDANCE WITH STATE OF OHIO SPECIFICATIONS ITEM 659.

12. ALL PROPOSED STORM SEWERS, SURFACE OR OTHER DRAINAGE FACILITIES ARE TO BE PRIVATE AND MAINTAINED BY THE OWNER.

13. THE DEVELOPER/OWNER IS TO CONSTRUCT CURBS, CATCH BASINS, DOWNSPOUTS, PIPING AND CONNECTION ETC. AS REQUIRED TO CONVEY THE ROOF AND PAVED SURFACE DRAINAGE TO THE DETENTION BASIN.

14. ROOF DRAINS, FOUNDATION DRAINS AND ALL OTHER CLEAR WATER CONNECTIONS TO THE SANITARY SEWER SYSTEMS ARE PROHIBITED.

15. ALL STORM STRUCTURES ARE ODOT TYPES UNLESS OTHERWISE INDICATED.

16. STORM SEWER PIPE LABELED "STM" SHALL BE ONE OF THE FOLLOWING: PVC SDR-35, PVC PROFILE PIPE PER ODOT ITEM 707.33, HIGH DENSITY POLYETHYLENE PER ODOT ITEM 707.33 OR CONTECH ULTRA FLO ALUMINIZED CORRUGATED METAL, ODOT ITEM 707.01, 707.02. STORM SEWER PIPE LABELED "RCP" SHALL BE REINFORCED CONCRETE PIPE, ODOT ITEM 706.02 CLASS IV. ALL STORM IS TO BE INSTALLED PER ODOT ITEM 603, TYPE A. ALL STORM IS TO BE INSTALLED PER ODOT ITEM 603, TYPE A.

17. ALL CATCH BASINS IN THE PAVEMENT OR CURB ARE TO HAVE A MINIMUM OF 2, 4" PERFORATED UNDERDRAINS EXTENDING 12 LF FROM THE CATCH BASIN IN THE UPHILL DIRECTION.

18. FOR EXACT LOCATION OF DOWN SPOUTS & ROOF DRAINS, COORDINATE WITH CONSTRUCTION

19. ALL CATCH BASINS WITH DEPTH GREATER THAN 4.5' SHALL BE PROVIDED WITH STEPS. STEPS SHALL MEET THE REQUIREMENTS OF ITEM 604.

20. DISTANCES SHOWN FOR BOTH SANITARY AND STORM SEWER PIPES ARE MEASURED FROM CENTER OF STRUCTURE. CONTRACTOR RESPONSIBLE FOR ACTUAL FIELD CUT LENGTH. COORDINATES FOR STORM & SANITARY STRUCTURES ARE SHOWN TO THE CENTER OF STRUCTURE.

21. SANITARY SEWER IS TO BE BEDDED WITH CLEAN GRANULAR MATERIAL-AGGREGATES NOT TO BE LARGER THAN 3/4" AND NOT SMALLER THAN NO. 8 SIEVE, FREE OF SILT AND FINES, AASHTO M43 SIZE #67, 7 OR 8. BEDDING TO BE A MINIMUM OF 6" BELOW & 12" ABOVE THE PIPE.

22. ALL MANHOLES WITH A DEPTH GREATER THAN 4' SHALL BE PROVIDED WITH EXTRUDED ALUMINUM STEPS, CONFORMING TO ASTM B2221, 6061.

23. SANITARY SERVICE SHALL BE 6" PVC PIPE OR APPROVED EQUAL (CONFORMING TO BUTLER COUNTY WATER & SEWER DEPARTMENT RULES AND REGULATIONS) INSTALLED AT A MINIMUM SLOPE OF TWO PERCENT (2.00%) UNLESS OTHERWISE NOTED. SANITARY SERVICE SHALL BE INSTALLED AT A MINIMUM DEPTH OF FOUR FEET (4') UNLESS OTHERWISE NOTED. A MINIMUM OF 18" CLEARANCE SHALL BE MAINTAINED AT ALL WATERLINE CROSSINGS. SANITARY SERVICE JOINTS ALL CONFORM TO ASTM D-3212.

24. SANITARY SEWER MATERIALS AND INSTALLATION AS PER BUTLER COUNTY ENVIRONMENTAL SERVICES SPECIFICATIONS, USING SECTION 3110 FOR PVC, SDR-35 & 26 PIPE; SECTION 3140 FOR ABS OR PVC COMPOSITE PIPE. SECTION 3410 FOR MANHOLES.

25. ALL BUILDINGS TO BE SERVED BY THE PUBLIC SEWER SYSTEM SHALL BE CONSTRUCTED SO AS TO PROVIDE A MINIMUM OF FOUR FEET OF VERTICAL SEPARATION BETWEEN THE PUBLIC SANITARY SEWER, AT THE POINT OF CONNECTION AND THE LOWEST BUILDING LEVEL SERVED BY A GRAVITY SEWER CONNECTION. IN ADDITION, SAID BUILDING LEVEL SHALL BE AT LEAST ONE FOOT ABOVE THE LOWEST POINT OF FREE-OVERFLOW (NON-SEATED MANHOLE COVER) UPSTREAM OF ANY TREATMENT FACILITY OR WASTEWATER PUMPING FACILITY THAT RECEIVES THE DISCHARGE FROM SAID BUILDING. SAID MINIMUM SERVICE LEVELS SHALL BE RECORDED ON THE "AS-BUILT" PLANS FOR THE DEVELOPMENT. WHICH WILL BE KEPT ON FILE IN THE OFFICE OF THE BUTLER COUNTY DEPARTMENT OF ENVIRONMENTAL SERVICES.

26. BUTLER COUNTY DEPARTMENT OF ENVIRONMENTAL SERVICES DOES NOT ACCEPT ANY RESPONSIBILITY FOR THE RELOCATION, REPAIR, OR REPLACEMENT OF ANY OTHER UTILITY INSTALLED WITHIN FIVE FEET OF THE CENTER LINE OF ANY SANITARY SEWER MAIN OR WATER MAIN.


27. MECHANICAL/ELECTRICAL CONTRACTORS SHALL BRING ALL UTILITIES 5' OUTSIDE BUILDING WALL. COORDINATE WITH CONSTRUCTION MANAGER.

28. ALL DIMENSIONS AND RADII ARE TO THE FACE OF CURB OR EDGE OF PAVEMENT UNLESS OTHERWISE NOTED.

29. ALL EDGE OF PAVEMENT RADII ARE 3.0' UNLESS OTHERWISE NOTED.

30. PARKING LOT STRIPING SHALL BE 4" WIDE WHITE HIGHWAY-TYPE STRIPING APPLIED IN ACCORDANCE WITH THE PLAN.

31. DUMPSTER PAD TO BE 4000 PSI CONCRETE, 9" THICK.

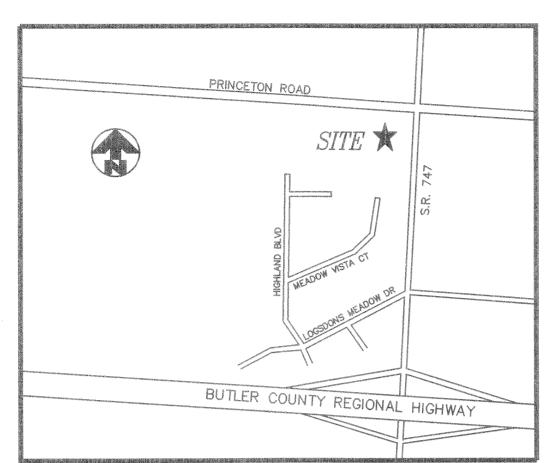

VICINITY MAP NOT TO SCALE

8746 UNION CENTRE BLVD.

WEST CHESTER, OH 45069

5/8" IRON PIN FOUND

ELEV=847.12)

LEGEND

O 5/8" IRON PIN FOUND

5/8" IRON PIN SET

EX. POWER POLE

EX. LIGHT POLE

EX. TRAFFIC PULL BOX

EX. TRAFFIC SIGNAL POLE

EX. GUY WIRE

EX. MAIL BOX

EX. LIGHT POST

EX. TRAFFIC BOX

EX. SIGN (2 POST)

EX. SIGN (1 POST)

EX. WATER VALVE

EX. WATER METER

EX. FIRE HYDRANT

EX. TREELINE

EX. FENCE LINE

EX. WATER LINE

EX. GUARD RAIL

(CONTROL POINT FOR SR-747 WIDENING

116 STANDARD SPACES

182 STANDARD SPACES

5 HANDICAP ACCESSIBLE SPACES

6 HANDICAP ACCESSIBLE SPACES

(513) 860-5050

SITE DATA

AREA: 9.928 ACRES

OWNER/DEVELOPER: PRINCETON LANDINGS, LLC

6305 CENTRE PARK DRIVE

WEST CHESTER, OH 45069

9394 MONTGOMERY ROAD

CINCINNATI, OH 45242

FNGINEER: KLEINGERS & ASSOCIATES

(513) 779-7851

PROPOSED USE: COMMERCIAL/RETAIL

EXISTING USE: RESIDENTIAL

PARKING REQUIRED:


PARKING PROVIDED:


REFERENCE BENCHMARKS:


ARCHITECT: CREATIVE SHELTER ARCHITECTS

(513) 984-8143


ZONING: B-PUD

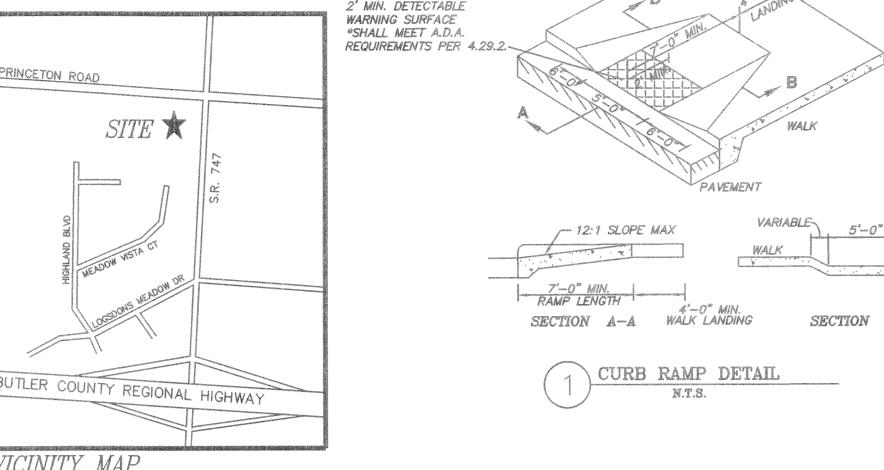


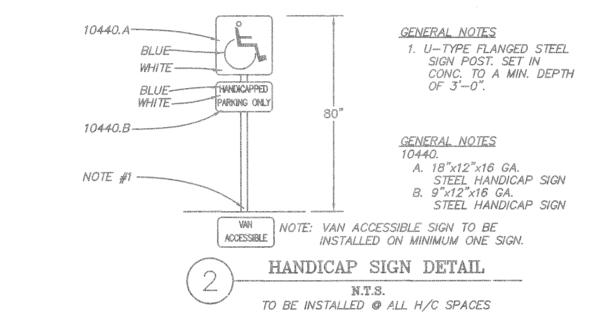


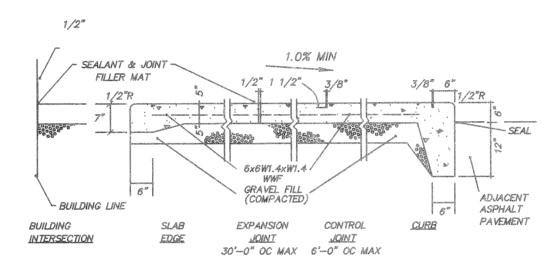

TYPICAL EXTERIOR CONCRETE SLAB WALK

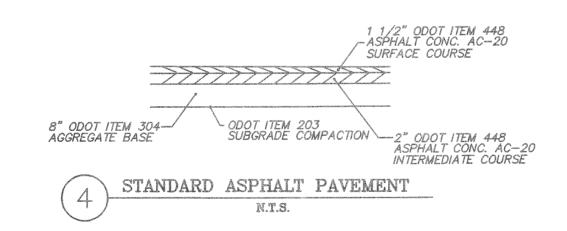

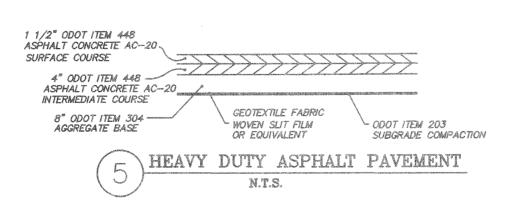

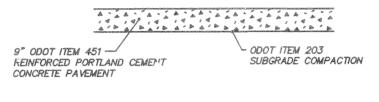


CONCRETE PAD

N.T.S.





PAVEMENT JOINT SEALER $_{ackprime}$ BARRIER CURB (ODOT TYPE 6)


1/4" R 5"1 NORMAL WIDTH OF PAVEMENT

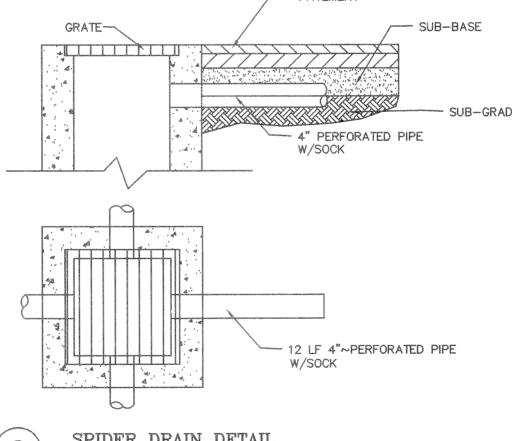


SPIDER DRAIN DETAIL

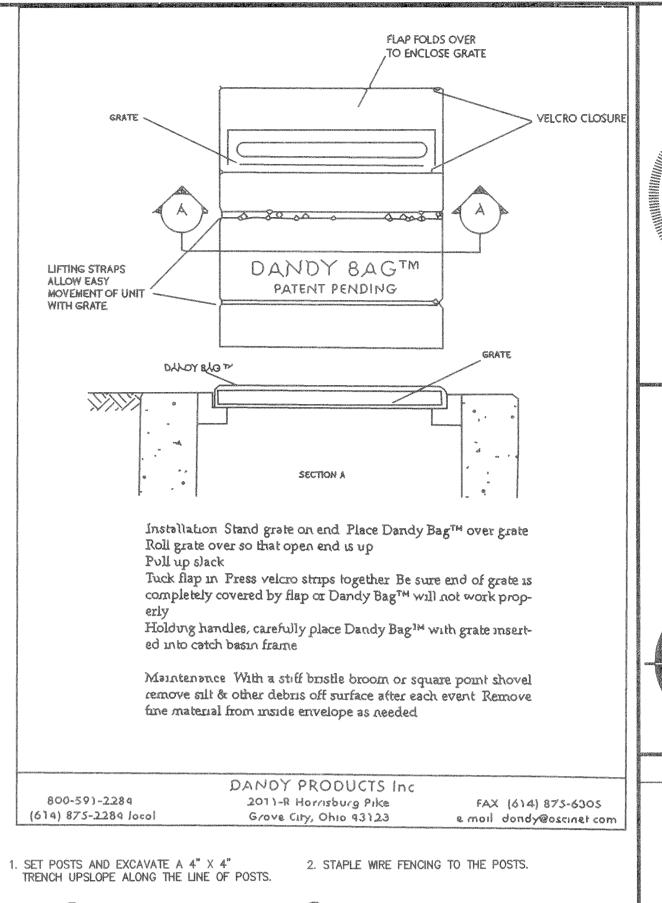


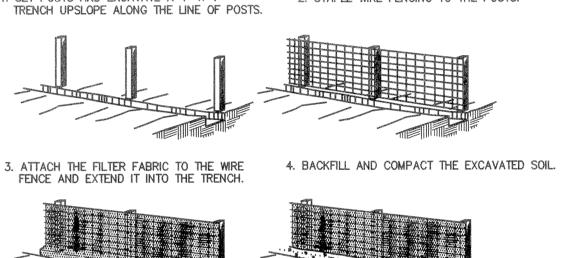

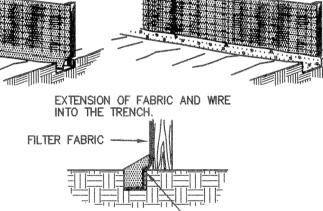

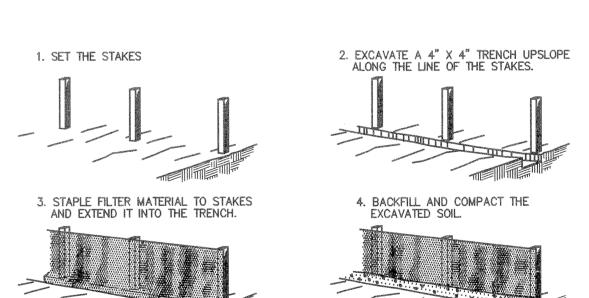

SILT FENCE (SF)

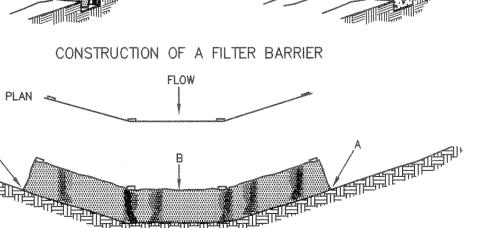

POINTS A SHOULD BE HIGHER THAN POINT B PROPER PLACEMENT OF FILTER BARRIER IN A DRAINAGE WAY FILTER BARRIER (FB)

60000 FER LAZINE

BEFORE YOU DIG CALL TOLL FREE 800-362-2764 OHIO UTILITIES PROTECTION SERVICE


TANDINGS PRINCETON


REVISIONS

DATE: FEBRUARY 2005 DRAWN: MLF/CJL DESIGNED: MLF/CJL CHECKED: JOB NO.: 030617CA005 PRINCETON LANDINGS

SCALE: N.T.S.

Page

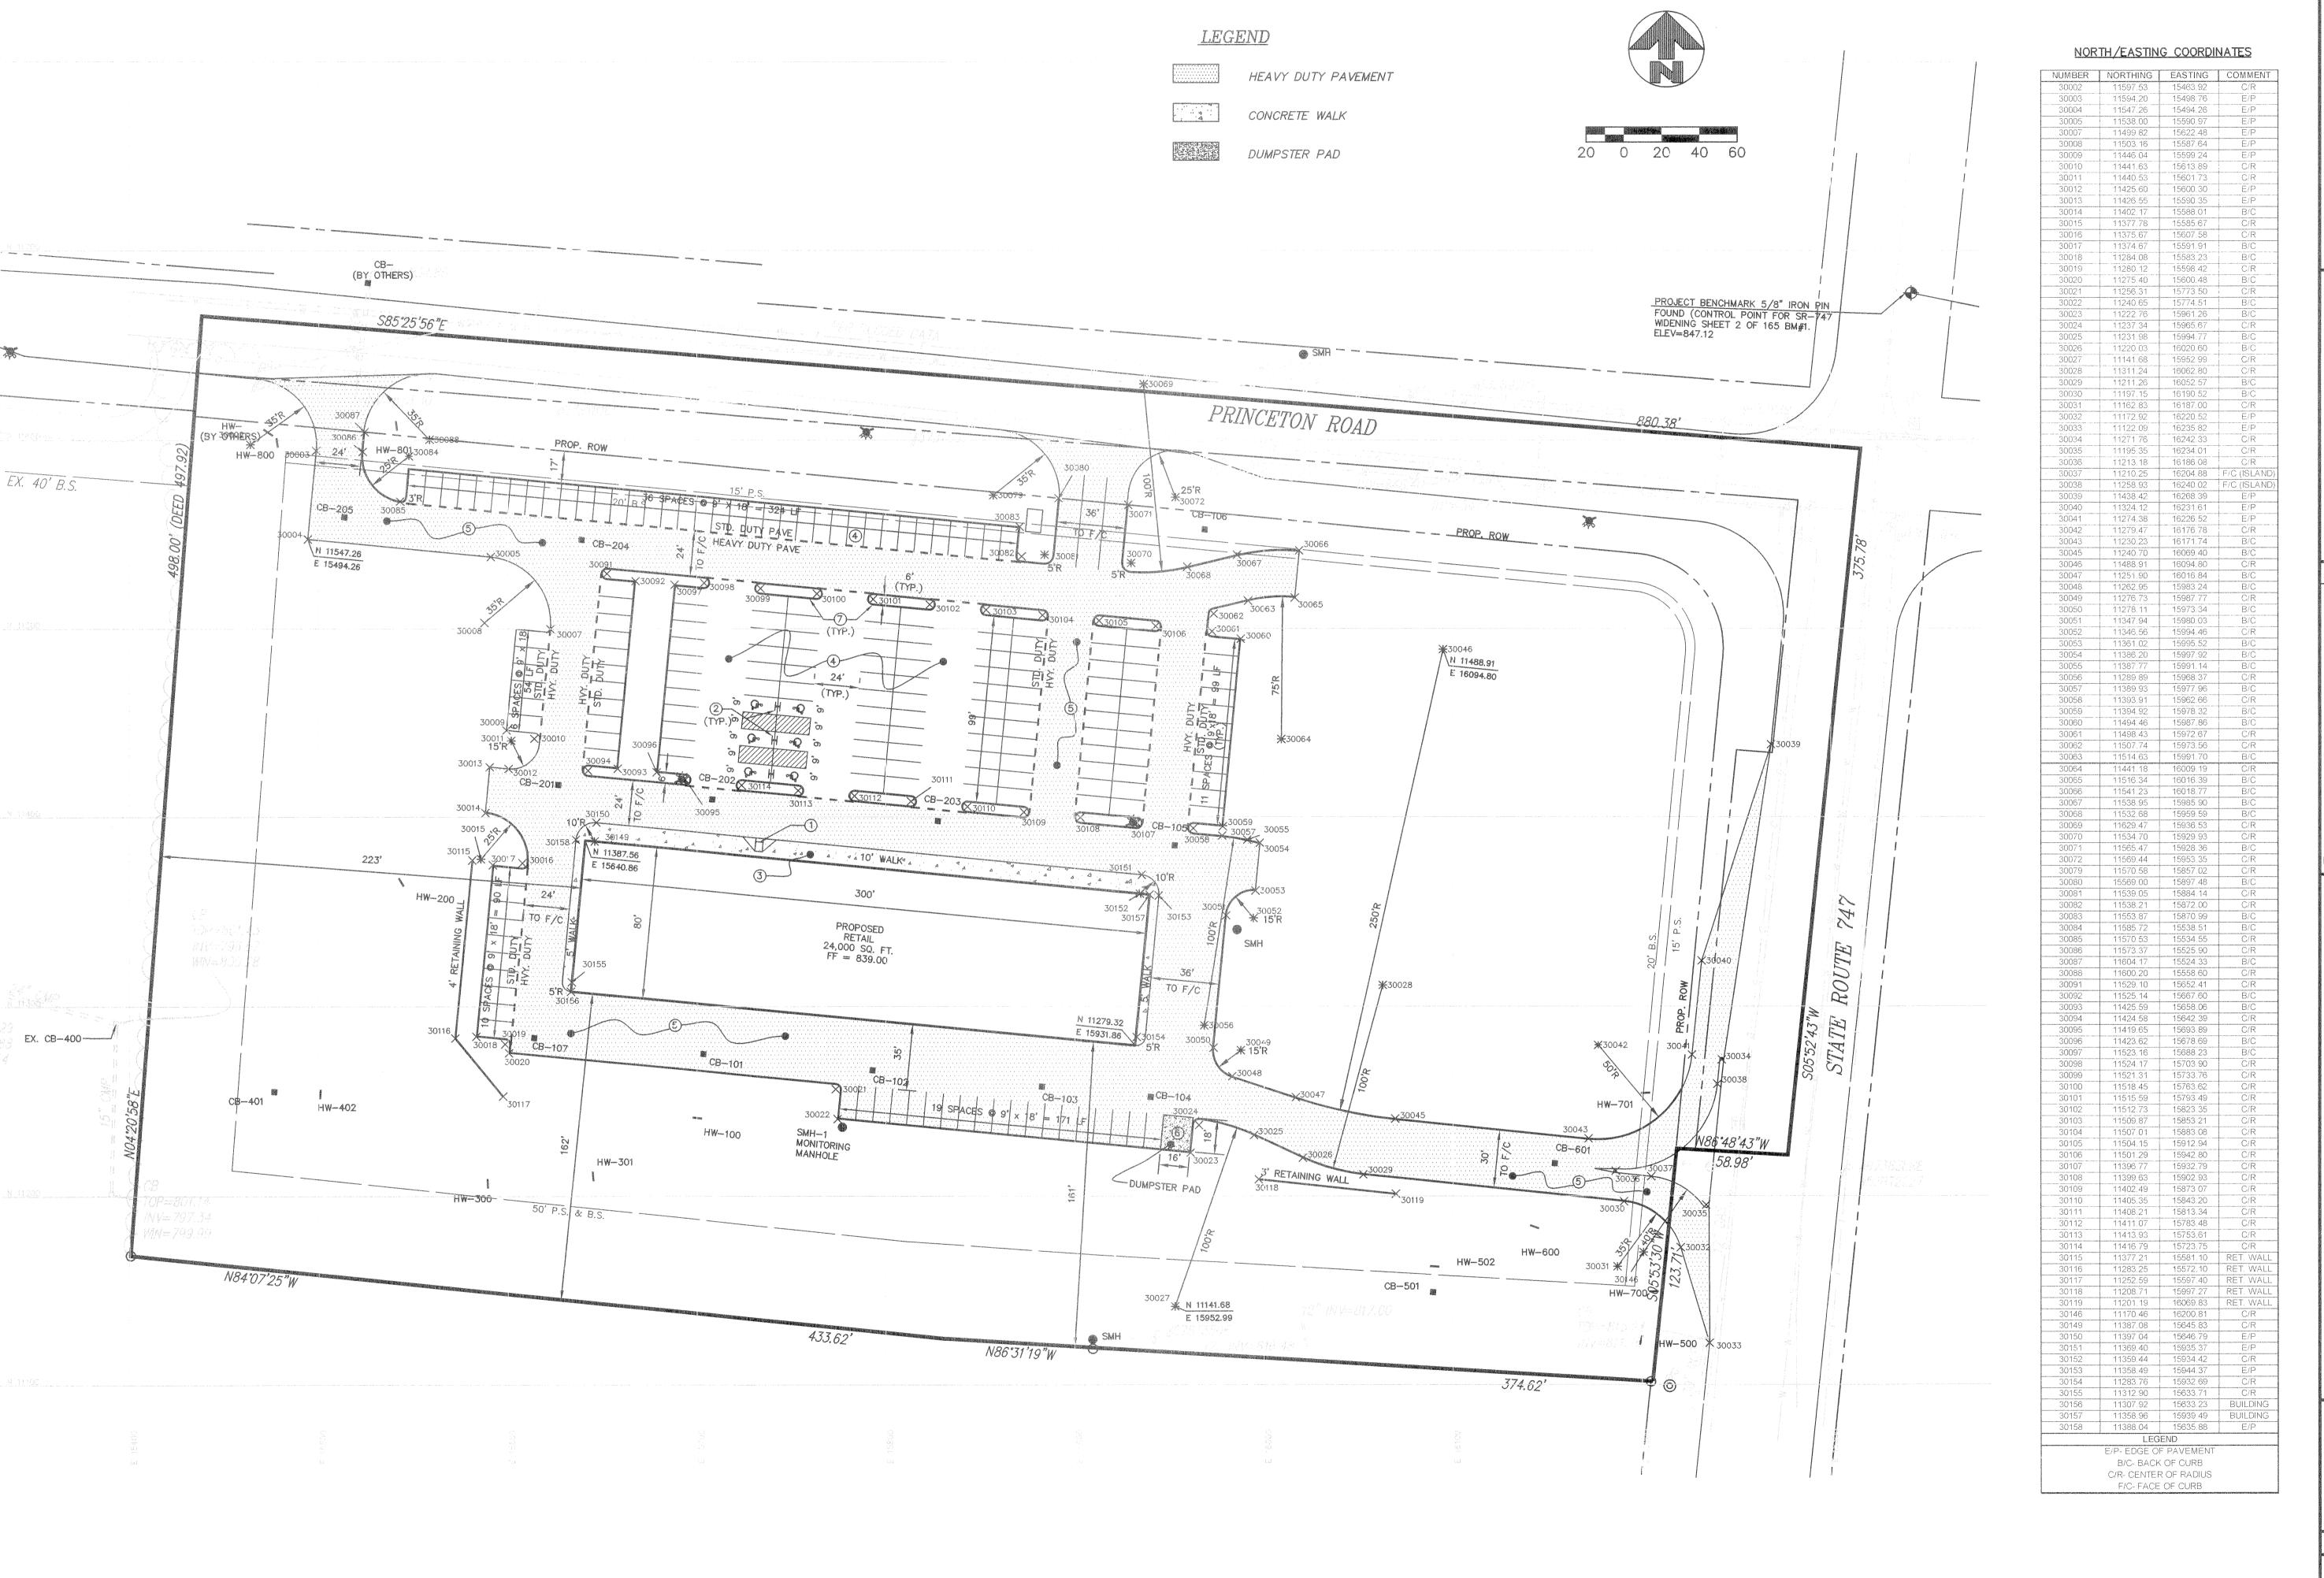

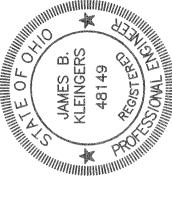

KLEINGERS AND SURVEYORS

K Drive, West Chester, OH 4506i

REVISIONS

CLO LOCATION PLAN
SECTION 1, TOWN 2, RANGE 5
LIBERTY TOWNSHIP
BUTLER COUNTY, OHIO PRINCETON LANDINGS


SCALE: 1"=40' DATE: FEBRUARY 2005 DRAWN: MLF/CJL DESIGNED: MLF/CJL CHECKED: XREF:

JOB NO.: 030617CA005 PRINCETON LANDINGS

Page Of

2 WORKING DAYS
BEFORE YOU DIG
CALL TOLL FREE 800-362-2764
OHIO UTILITIES PROTECTION SERVICE



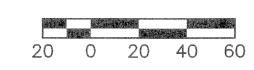

STORM SEWER SCHEDULE

CB-204 ODOT TYPE 2-2-B GRATE = 836.90

CB-205 ODOT TYPE 2-2-B GRATE = 837.25

HW-600 ODOT TYPE 1.1

INV = 820.83 (12")

CB-601 ODOT TYPE 2-2-B GRATE = 824.00

INV = 822.00 (15")

INV = 817.50 (15")

HW-701 ODOT TYPE 1.1

HW-700 ODOT TYPE 1.1

ODOT TYPE 1.1 INV = 833.50 (12")

HW-801 ODOT TYPE 2.1

INV = 838.90 (12")

008-WH

INV OUT = 821.00 (12")

INV OUT = 834.00 (12")

INV IN = 833.37 (12")INV OUT = 833.27 (12")

HW-100 ODOT TYPE 1.1 INV = 831.30 (18") CB-101 ODOT TYPE 2-4 GRATE = 837.40 INV IN = 833.40 (12") W INV IN = 831.75 (18") E INV OUT = 831.65 (18") S CB-102

CB-102 ODOT TYPE 2-3 GRATE = 837.40 INV IN = 832.50 (15") INV OUT = 832.25 (18")

CB-103 ODOT TYPE 2-2-B GRATE = 837.40 INV IN = 833.40 (15") INV OUT = 833.30 (15") CB-104

ODOT TYPE 2-2-B
GRATE = 837.10
INV IN = 833.79 (15")
INV OUT = 833.69 (15")
CB-105
ODOT TYPE 2-2-B
GRATE = 836.95

INV IN = 834.70 (12")
INV OUT = 834.45 (15")

CB-106
ODOT TYPE 2-2-B
GRATE = 844.60
INV OUT = 840.60 (12")

CB-107 ODOT TYPE 2-2-B GRATE = 837.00 INV OUT = 833.85 (12")

HW-200 ODOT TYPE 1.1 INV = 830.00 (15") CB-201 ODOT TYPE 2-3 GRATE = 837.00

GRATE = 837.00 INV IN = 832.15 (12") N INV IN = 832.56 (15") E INV OUT = 831.90 (15") SW CB-202 ODOT TYPE 2-2-B GRATE = 837.15

INV OUT = 833.17 (15")

CB-203

ODOT TYPE 2-2-B

GRATE = 837.15

INV OUT = 834.15 (12")

INV IN = 833.42 (12")

SANITARY SEWER SCHEDULE

SMH-1 N 11236.28 E 15777.05 (BUTLER COUNTY MONITORING MANHOLE) RIM = 838.50 INV = 826.45

NORTH/EASTING STORM STRUCTURES

STRUCTURE ID	NORTHING	EASTING
HW-100	11241.20	15700.17
CB-101	11274.84	15703.39
CB-102	11266.26	15792.99
CB-103	11257.68	15882.58
CB-104	11252.18	15940.11
CB-105	11384.86	15952.81
CB-106	11552.36	15968.85
CB-107	11283.41	15613.80
HW-200	11365.74	15543.49
CB-201	11417.05	15626.60
CB-202	11409.24	15708.14
CB-203	11397.80	15827.59
CB-204	11546.96	15639.04
CB-205	11558.97	15513.62
CB-206	11206.85	15589.29
CB-207	11210.56	15645.03
HW-400	11291.29	15392 70
CB-401	11255.02	15476.40
HW-402	11253.82	15500.80
HW-500	11123.68	16199.47
CB-501	11149.17	16089.39
HW-502	11162.98	16090.23
HW-600	11183.87	16143.12
CB-601	11217.19	16153.83
HW-700	11149.98	16211.59
HW-701	11254.34	16201.92


NOTE: CONTRACTOR TO MAINTAIN 18"
VERTICAL CLEARANCE BETWEEN THE
SANITARY SEWER SERVICE AND THE STORM
SEWER.

2 WORKING DAYS

BEFORE YOU DIG

CALL TOLL FREE 800-362-2764

OHO UTILITIES PROTECTION SERVICE

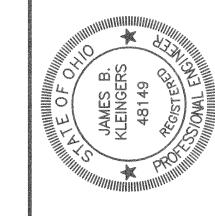

RESOCIATES

& ASSOCIATES

ENGINEERS AND SURVEYORS

& Drive, West Chester, OH 45069

1 Fax: (513) 779-7852

SAOS CONTRE Park Drive, We (513) 779-7851 Fax: (51.

PRINCETON LANDINGS
UTILITY PLAN
SECTION 1, TOWN 2, RANGE 3
LIBERTY TOWNSHIP
BUTLER COUNTY, OHIO


SCALE: 1"=40'
DATE: FEBRUARY 2005
DRAWN: MLF/CJL
DESIGNED: MLF/CJL
CHECKED:

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JOB NO.: 030617CA005

PRINCETON LANDINGS

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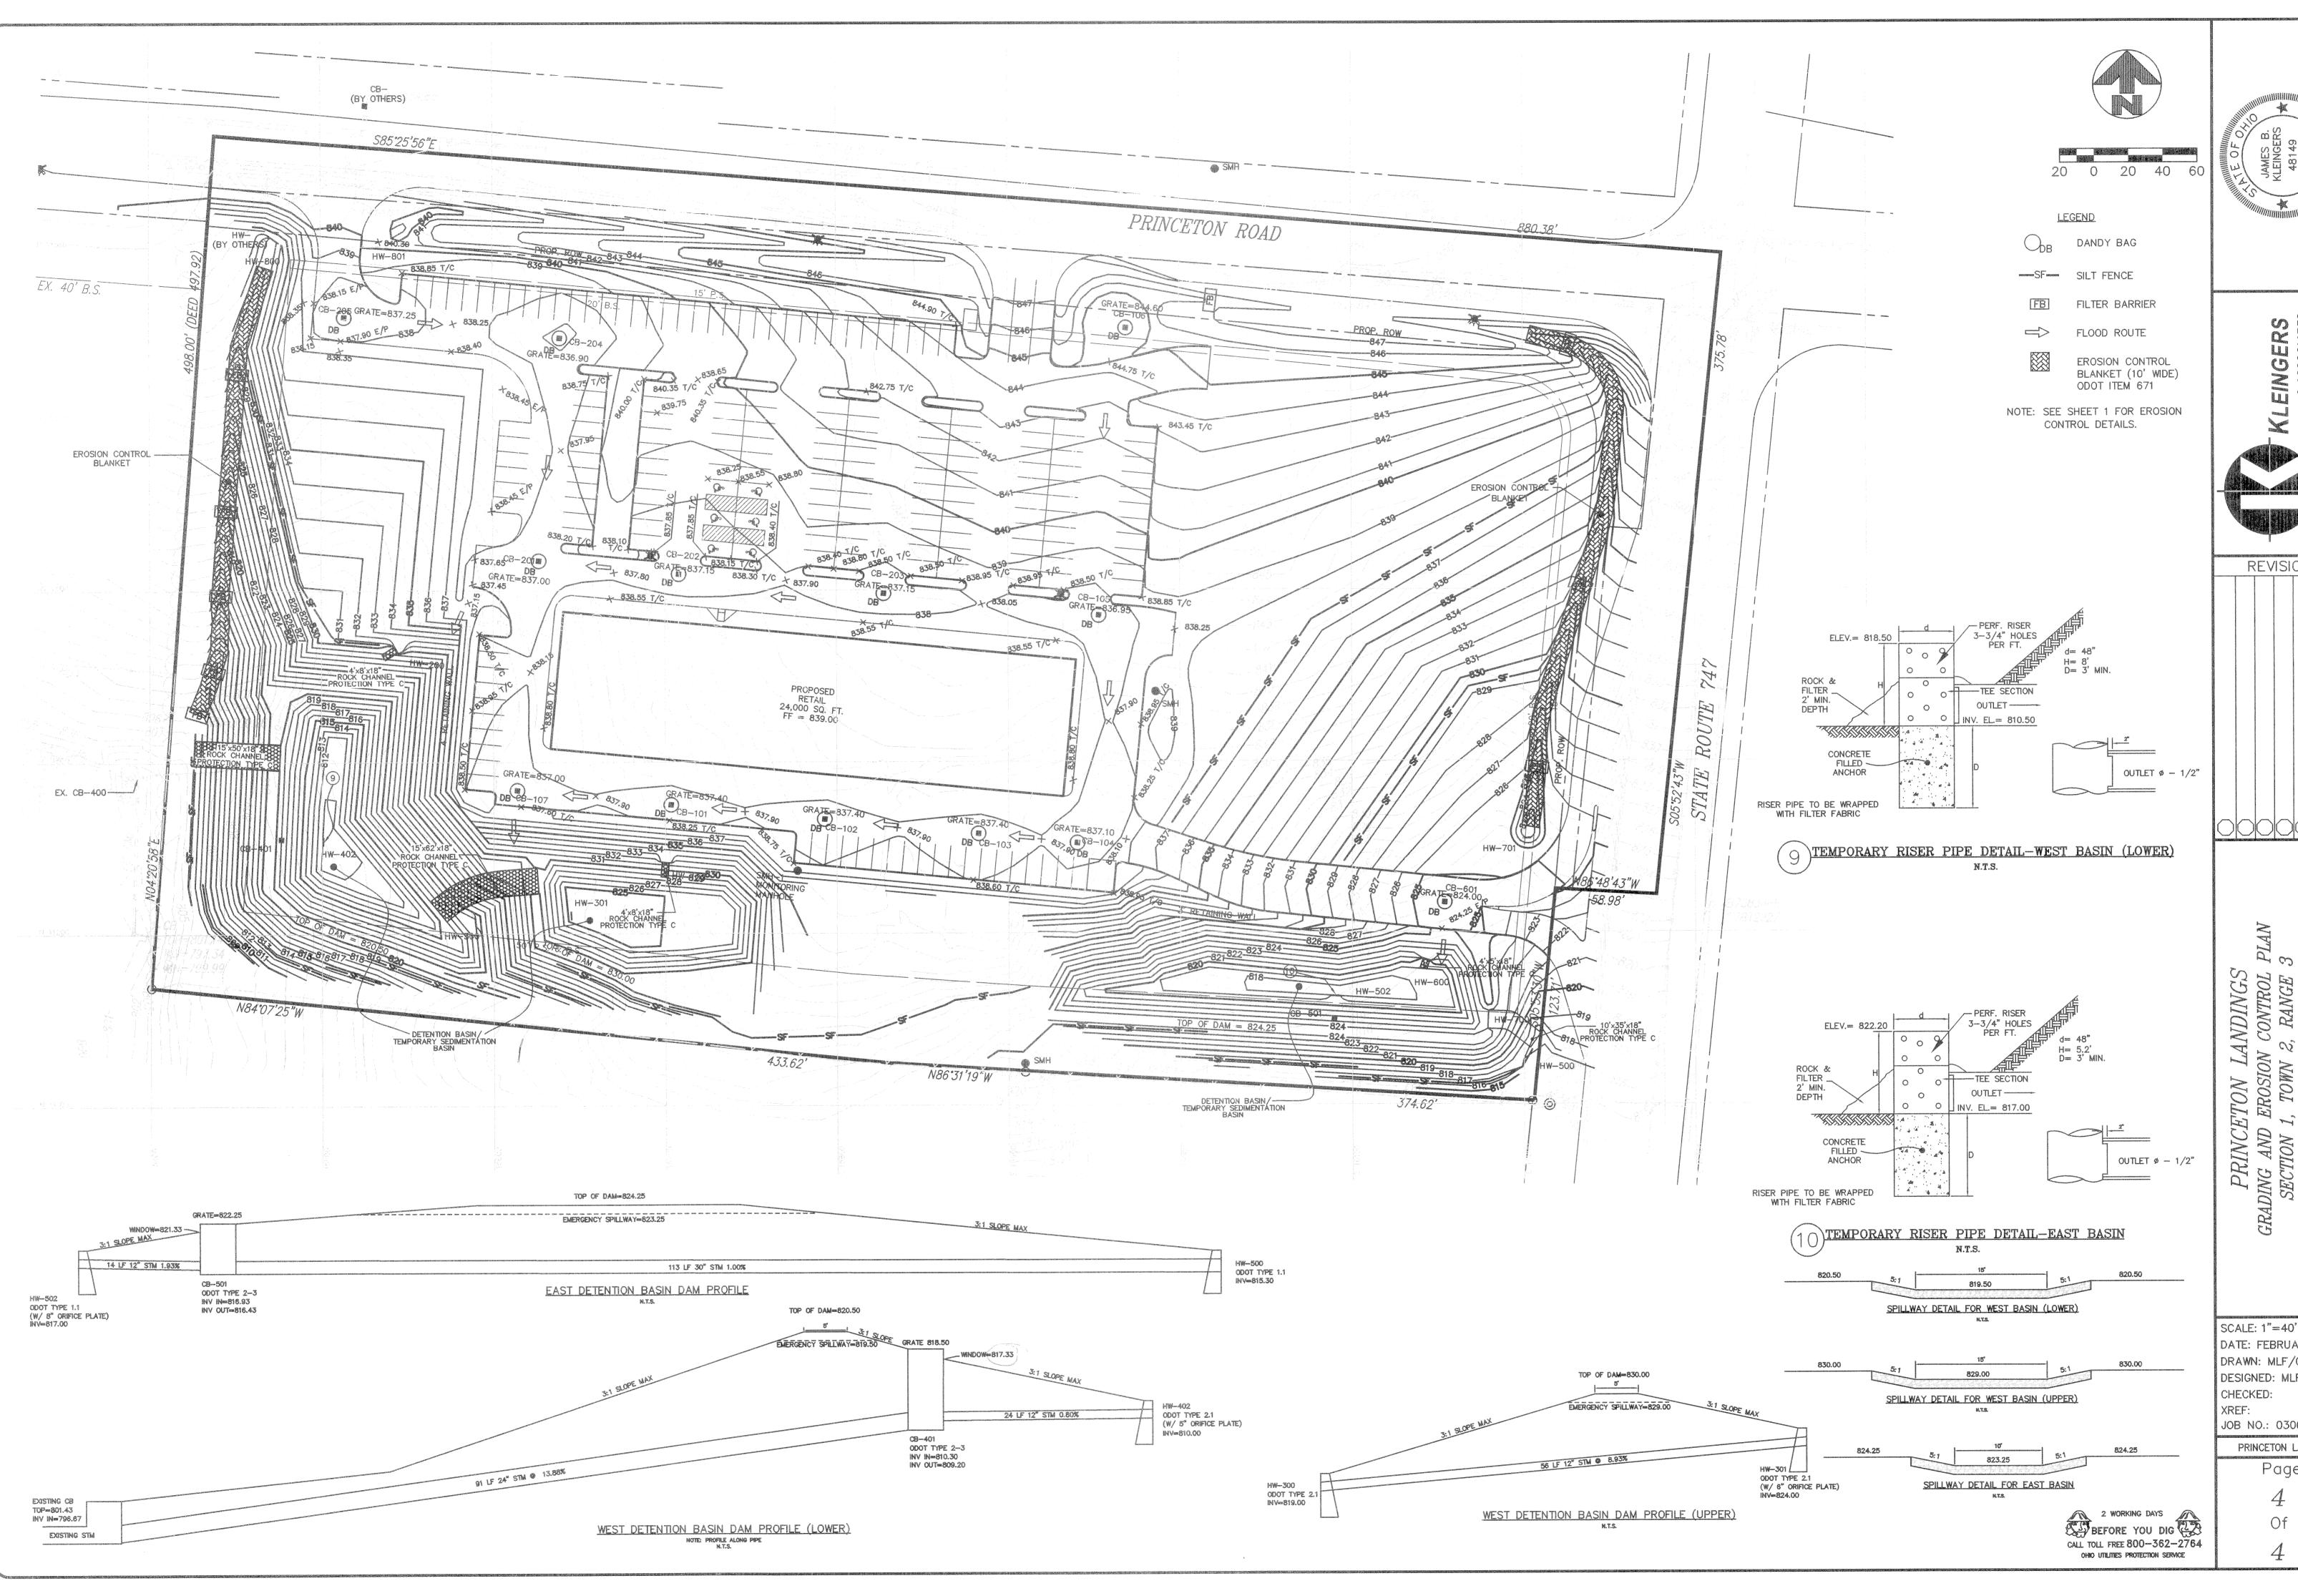


(BY OTHERS)

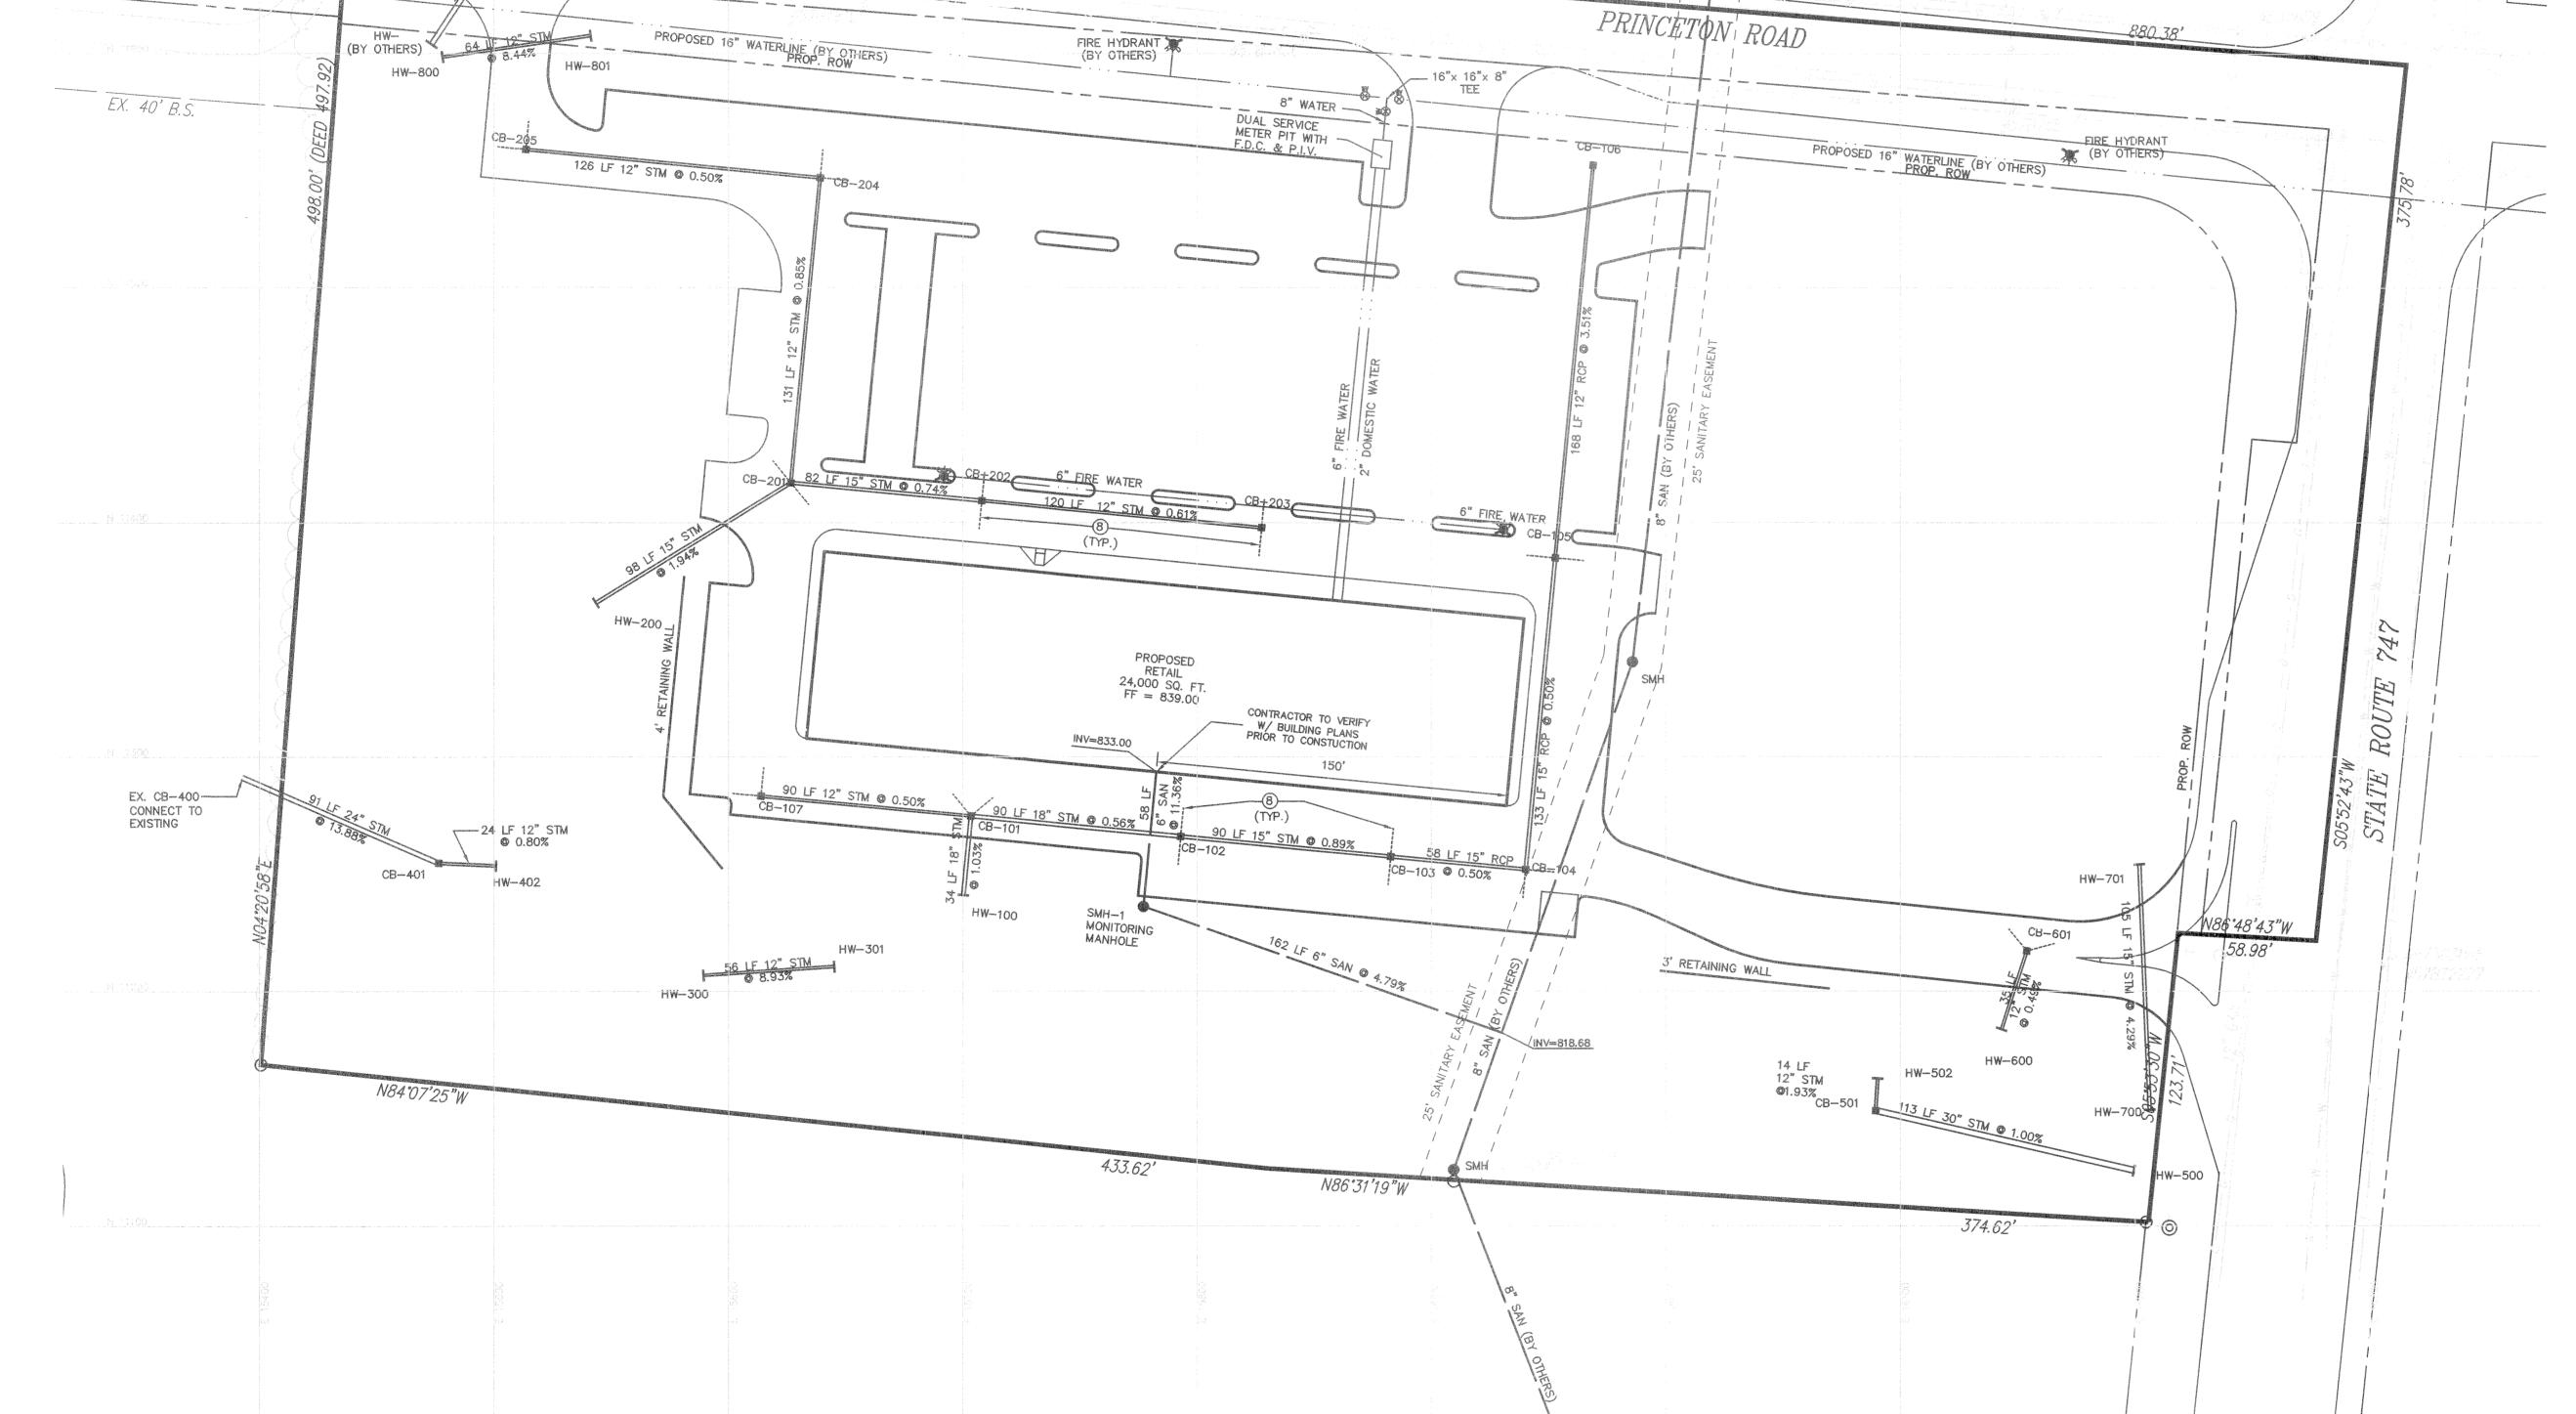FIRE HYDRANT

(BY OTHERS)

S85°25'56"E



REVISIONS

SCALE: 1"=40' DATE: FEBRUARY 2005 DRAWN: MLF/CJL DESIGNED: MLF/CJL

JOB NO.: 030617CA005 PRINCETON LANDINGS Page