SITE IMPROVEMENTS

CASEY'S GENERAL STORE

PRINCETON ROAD HAMILTON, OH 45011

OWNER/DEVELOPER: CASEY'S GENERAL STORES, INC ONE SE CONVENIENCE BLVD. ANKENY, IA 50021 PHONE: (515) 446-6402 CONTACT: DARREN MOGA

ENGINEER: CESO, INC. 2800 CORPORATE EXCHANGE DR, SUITE 400 COLUMBUS, OH 43231 PHONE: (614) 942-3017 CONTACT: JÉFF LONCHOR EMAIL: LONCHOR@CESOINC.COM

GOVERNING AGENCIES AND UTILITY COMPANIES:

SEWER: BUTLER COUNTY WATER & SEWER CONTACT: STEVEN THOMPSON EMAIL: WATER.BCOHIO.US

BUTLER COUNTY WATER & SEWER PHONE: (513) 785-5288 CONTACT: STEVEN THOMPSON EMAIL: WATER.BCOHIO.US

BUTLER COUNTY ENGINEER'S OFFICE PHONE: (513) 785-4121 CONTACT: ERIC POTTENGER EMAIL: POTTENGERE@BCEO.ORG

FAIRFIELD TOWNSHIP PLANNING & ZONING PHONE: (513) 785-2266

CONTACT: CHUCK GOINS

EMAIL: CGOINS@FAIRFIELDTWP.ORG

GAS SERVICE:
DUKE ENERGY GAS RECORDS PHONE: (513) 287-2366 CONTACT: MARK BRANSCUM

ELECTRIC:
DUKE ENERGY ELECTRIC CONTACT: CRAIG HUTCHINSON

EXISTING FEATURES LEGEND


APPLIES TO ALL CIVIL SHEETS

RIGHT OF WAY LINE

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	FARGEL LINE	0	IRON PIN FOUND AS NO
	SUBJECT PROPERTY BOUNDARY LINE	0	CONCRETE BOLLARD PO
		E	ELECTRIC METER
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	CURB		TELEPHONE BOX
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	EDGE OF WALK	\$	POWER & TELEPHONE F
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Sheet List Table					
Sheet Number	Sheet Title				
C-001	COVER SHEET				
C-002	GENERAL NOTES				
C-003	ALTA				
C-004	ALTA				
C-100	DEMOLITION PLAN				
C-101	SITE PLAN				
C-201	GRADING PLAN				
C-202	TRIBUTARY AREA MAP				
C-301	UTILITY PLAN				
C-401	SWPPP				
C-402	SWPPP DETAILS				
C-501	PHOTOMETRIC PLAN				
C-601	CIVIL DETAILS				
C-602	CIVIL DETAILS				
C-603	CIVIL DETAILS				
C-604	CONSTRUCTION DETAILS				
C-701	LANDSCAPE PLAN				



TOLEDO CLEVELAND AKRON CANTON COLUMBUS	
DAYTON HAMILTON OHIO	
Malden Ponds Circle	
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VICINITY MAP	
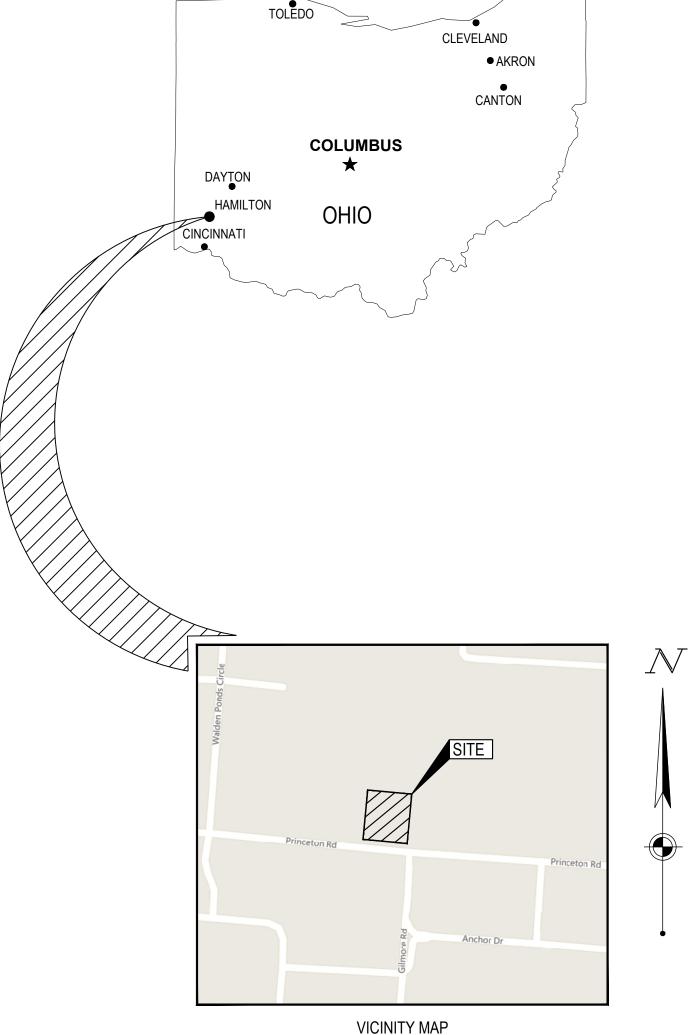
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		BENCHMARK	
	ELEVATION*	DESCRIPTION	
BM #1191	736.30	BENCH NAIL SET SOUTH SIDE OF POWER POLE #JH-0009. NORTH SIDE OF PRINCETON ROAD, SOUTH OF WALDEN PONDS COMMUNITY CHURCH BUILDING.	OHIC
BM #1270	749.19	BENCHNAIL SET NORTH SIDE OF POWER POLE #J12-0013 SOUTHWEST OF GILMORE ROAD AND PRINCETON ROAD INTERSECTION, NORTH OF POPEYE'S CHICKEN.	Utili
BM #1514	752.88	CHISELED BOX SOUTHWEST CORNER OF TRAFFIC SIGNAL LIGHT POLE BASE. LOCATED ON NORTHEAST CORNER OF PRINCETON ROAD AND GILMORE ROAD INTERSECTION.	811 or 1-800-362

- 3. IT IS THE CONTRACTOR'S RESPONSIBILITY TO CALL OHIO UTILITY PROTECTION SERVICE AND THEN TO CONTACT ALL UTILITY COMPANIES TO SCHEDULE UTILITY SERVICE REMOVAL AND/OR ABANDONMENT. ALL UTILITIES SHALL BE REMOVED AND/OR RELOCATED PER THE SPECIFICATIONS OF THE UTILITY COMPANIES. THE CONTRACTOR IS RESPONSIBLE TO PAY ALL FEES AND CHARGES ASSOCIATED WITH THIS WORK.
- 4. CONTRACTOR IS RESPONSIBLE FOR PROVIDING TRAFFIC CONTROL. ALL TRAFFIC CONTROL MEASURES SHALL BE IN ACCORDANCE WITH THE 2012 ODOT MANUAL OF UNIFORM TRAFFIC CONTROL DEVICES AND BUTLER COUNTY PROJECT SPECIFICATIONS.
- THE CONTRACTOR IS RESPONSIBLE FOR THE DEMOLITION, REMOVAL AND DISPOSAL, IN A LOCATION APPROVED BY THE GOVERNING AUTHORITIES, OF ALL STRUCTURES, PADS, WALLS, FOUNDATIONS, DRAINAGE STRUCTURES, UTILITIES, ETC. SUCH THAT THE IMPROVEMENTS SHOWN ON THE REMAINING PLANS CAN BE CONSTRUCTED. ALL FACILITIES TO BE REMOVED SHALL BE UNDERCUT TO SUITABLE MATERIAL AND BROUGHT TO GRADE WITH SUITABLE COMPACTED FILL MATERIAL AS SPECIFIED IN THE GEOTECHNICAL REPORT. THE CONTRACTOR IS RESPONSIBLE FOR OBTAINING ALL PERMITS REQUIRED FOR DEMOLITION AND DISPOSAL
- 6. CONTRACTOR IS RESPONSIBLE FOR PROVIDING JOB SITE SAFETY PER OSHA REQUIREMENTS. AT ALL TIMES DURING DEMOLITION AND CONSTRUCTION, CONTRACTOR SHALL PROVIDE SAFETY RAILINGS AT ALL AREAS WHERE FALL PROTECTION IS REQUIRED.
- 7. CONTRACTOR MAY LIMIT SAW-CUT AND PAVEMENT REMOVAL TO ONLY THOSE AREAS WHERE IT IS REQUIRED AS SHOWN ON THESE CONSTRUCTION PLANS BUT IF ANY DAMAGE IS INCURRED TO ANY OF THE SURROUNDING PAVEMENT, ETC., THE CONTRACTOR SHALL BE RESPONSIBLE FOR ITS REMOVAL AND REPAIR.
- 8. SAWCUT AND REMOVE TO FULL DEPTH AT ALL PAVEMENT/SIDEWALK LIMITS OR TO EXISTING JOINTS.

PROPOSED STRUCTURES AND APPURTENANCES CAN BE CONSTRUCTED.

- 9. CONTRACTOR SHALL MAINTAIN A WELL-DRAINED SITE, FREE OF STANDING WATER DURING CONSTRUCTION. CONTRACTOR SHALL BE RESPONSIBLE FOR TEMPORARY DRAINAGE MEASURES DURING CONSTRUCTION.
- 10. CONTRACTOR IS RESPONSIBLE FOR PLACING AND MAINTAINING CONSTRUCTION FENCE, SIGNS, ETC. TO WARN AND KEEP UNAUTHORIZED PEOPLE OFF SITE
- FOR THE DURATION OF THE PROJECT.

 11. EXTENT OF DEMOLITION WORK IS NOT LIMITED TO ONLY WHAT IS SHOWN TO BE DEMOLISHED ON THIS PLAN. DEMOLITION WORK MUST BE COMPLETE SO THE
- 12. ALL POTENTIALLY HAZARDOUS/TOXIC MATERIALS MUST BE REMOVED FROM THE SITE PRIOR TO DEMOLITION, AND PER DIRECTION OF ENVIRONMENTAL ENGINEER
- 13. THE REMOVAL OF STRUCTURES AND OBSTRUCTIONS SHALL BE IN ACCORDANCE WITH FEDERAL, STATE AND LOCAL CODE REQUIREMENTS.
- 14. FEDERAL, STATE AND LOCAL CODE REQUIREMENTS SHALL CONTROL THE DISPOSAL OF DEBRIS RESULTING FROM THE REMOVAL OPERATION.
- 15. ALL MATERIALS AND STRUCTURES DESIGNATED AS "TO BE REMOVED" SHALL BE DISPOSED OF OFF SITE AND AT THE COST OF THE CONTRACTOR.
- 16. DEAD SEWER CONNECTIONS OR MAINS BEING REMOVED SHALL BE REMOVED TO THE RIGHT OF WAY (UNLESS PLANS OR THE SANITARY ENGINEER SPECIFY OTHERWISE) AND SEALED AND MADE WATERTIGHT.
- 17. ALL TRENCHES, HOLES AND PITS RESULTING FORM THE REMOVAL AND ABANDONMENT OF ANY STRUCTURE OR OBSTRUCTION SHALL BE BACKFILLED AND COMPACTED IN ACCORDANCE WITH THE GEOTECHNICAL REPORT.
- 18. TREE REMOVAL AND CLEARING AND GRUBBING SHALL BE PERFORMED PER FEDERAL, STATE AND LOCAL CODE REQUIREMENTS. STUMP SHALL BE REMOVED COMPLETELY, INCLUDING ALL ROOTS.
- 19. THE CONTRACTOR SHALL STRIP AND REMOVE (OR STOCKPILE) ALL TOPSOIL PRIOR TO COMMENCING WITH ANY EXCAVATION OR DEMOLITION.
- 20. EXISTING UTILITIES NOT TO BE UTILIZED BY THE NEW DEVELOPMENT SHALL BE CAPPED BY THE CONTRACTOR.

SITE GENERAL NOTES

- 1. ALL DIMENSIONS ARE MEASURED TO THE BACK OF CURB OR FACE OF BUILDING.
- 2. ALL LIGHT POLES TO BE LOCATED 3' FROM THE BACK OF CURB, AS MEASURED FROM THE FACE OF POLE FOUNDATION, UNLESS OTHERWISE DENOTED ON PLANS.
- 3. ALL SIGNAGE SHALL COMPLY WITH THE OHIO MANUAL ON UNIFORM TRAFFIC CONTROL DEVICES (O.M.U.T.C.D.)
- a. STOP SIGNb. DO NOT ENTER
- b. DO NOTENTER
- 4. ALL PAVEMENT MARKINGS AND STRIPING SHALL COMPLY WITH ODOT AND THE OHIO MANUAL ON UNIFORM TRAFFIC CONTROL DEVICES (O.M.U.T.C.D.)
- a. LANE LINE: 6" WHITE
- b. WORDING/LANE USE ARROWS AND HANDICAP AREA: WHITE
- c. PARKING STALLS: 4" YELLOWd. STOP LINE: 12" WHITE
- 5. BOLLARDS SHALL BE PLACED PER PLAN.
- 6. NEW CURB AND GUTTER ALONG EXISTING STREETS TO MATCH EXISTING CURB AND GUTTER IN KIND. IF UNDER DRAIN EXISTS, IT SHALL BE REPLACED.

GRADING GENERAL NOTES

- 1. CONTRACTOR SHALL CONSTRUCT SIDEWALKS SUCH THAT 2% IS THE MAXIMUM CROSS SLOPE, AND 5% IS THE MAXIMUM TRANSVERSE SLOPE, AND CURB RAMPS SHALL BE CONSTRUCTED PER DETAILS IN THESE PLANS, AND THE MAXIMUM SLOPES SHALL NOT BE EXCEEDED. FORMS SHALL BE PLACED FOR SIDEWALK AREA, AND THE SLOPES ARE TO BE VERIFIED PRIOR TO PLACING CONCRETE. IF SLOPES BECOME AN ISSUE, CONTRACTOR SHALL CONTACT THE ENGINEER.
- 2. CURB AND GUTTER SHALL PITCH OUT WHERE GRADING IS SLOPED AWAY FROM THE CURB AND SHALL PITCH IN WHEN GRADING IS SLOPED TOWARDS THE CURB. THE PITCH OF THE GUTTER SHALL MATCH PARKING LOT GRADES.
- 3. UNLESS OTHERWISE NOTED, ALL SPOT ELEVATIONS SHOWN ARE PAVEMENT ELEVATIONS.

PLANTING GENERAL NOTES:

- 1. ALL PLANT MATERIAL SHALL BE NORTHERN NURSERY GROWN NO. 1 GRADE AND INSTALLED ACCORDING TO ACCEPTED PLANTING PROCEDURES. ALL PLANT MATERIALS SHALL MEET CURRENT AMERICAN ASSOCIATION OF NURSERYMEN STANDARDS. DO NOT PLANT MATERIALS UNTIL DIRECTED BY OWNER/CONSTRUCTION MANAGER. THE OWNER RESERVES THE RIGHT TO REJECT ANY PLANT MATERIAL, FOR ANY REASON BEFORE OR AFTER IT IS INSTALLED.
- 2. SIZES SPECIFIED ARE MINIMUM SIZES TO WHICH THE PLANTS ARE TO BE INSTALLED. ANY PLANT SUBSTITUTIONS SHALL BE APPROVED BY THE MUNICIPALITY AND OWNER.
- 3. ALL LANDSCAPING SHALL BE INSTALLED AND MAINTAINED IN ACCORDANCE WITH MUNICIPAL STANDARDS AND IN ACCORDANCE WITH CURRENT INDUSTRY STANDARDS IN A NEAT, HEALTH AND WEED FREE CONDITION. ANY DEAD, DISEASED OR DAMAGED PLANT MATERIALS ARE TO BE REPLACED IMMEDIATELY AFTER NOTIFIED TO DO SO. PLANT MATERIAL SHALL BE GUARANTEED FOR ONE YEAR AFTER PLANTING AND ACCEPTANCE.
- 4. PLANT TREES AND SHRUBS IN ACCORDANCE WITH PLANTING DETAILS. DIG TREE PITS PER DETAILS. PLANT TREES AND SHRUBS AT THE SAME GRADE LEVEL AT WHICH THEY WERE GROWN AT THE NURSERY. IF HEAVY CLAY SOILS ARE EVIDENT, PLANT TREES AND SHRUBS HIGHER, APPROX. 1/4 OF THE ROOT BALL ABOVE GRADE.
- 5. REMOVE ALL TWINE, WIRE, NURSERY TREE GUARDS, TAGS AND INORGANIC MATERIAL FROM ROOT BALLS. REMOVE THE TOP 1/3 OF BURLAP FROM EARTH BALLS AND REMOVE BURLAP FROM AROUND TRUNK.
- 6. BRICK CHIPS OR WASHED GRAVEL IS REQUIRED FOR ALL PLANTINGS AND PLANTING BEDS.
- 7. LANDSCAPE CONTRACTOR SHALL BE RESPONSIBLE FOR THE VERIFICATION OF ALL UNDERGROUND AND OVERHEAD UTILITIES. IF A CONFLICT WITH UTILITIES EXISTS, NOTIFY OWNER/CONSTRUCTION MANAGER PRIOR TO PLANTING.

UTILITY GENERAL NOTES:

- 1. COORDINATE ALL SITE UTILITY WORK WITH THE MECHANICAL AND ELECTRICAL DRAWINGS.
- 2. THE LOCATIONS OF UNDERGROUND FACILITIES SHOWN ON THESE PLANS ARE BASED ON FIELD SURVEYS AND LOCAL UTILITY COMPANY RECORDS. IT SHALL BE THE CONTRACTOR'S FULL RESPONSIBILITY TO CONTACT THE VARIOUS UTILITY COMPANIES TO LOCATE THEIR FACILITIES PRIOR TO STARTING CONSTRUCTION. NO ADDITIONAL COMPENSATION SHALL BE PAID TO THE CONTRACTOR FOR DAMAGE AND REPAIR TO THESE FACILITIES CAUSED BY CONTRACTOR'S WORK FORCE.
- 3. CONTRACTOR IS RESPONSIBLE FOR OBTAINING AND PAYING FOR ALL PERMITS REQUIRED TO PERFORM THE WORK PROPOSED ON THESE PLANS.
- 4. EXISTING AND PROPOSED GAS, ELECTRIC, TELEPHONE ASSUMED TO BE 36" COVER
- 5. CONTRACTOR TO ENSURE MIN. 10' FOOT HORIZONTAL AND 18" VERTICAL CLEARANCE BETWEEN WATER AND SANITARY/STORM LINES
- 6. ROOF DRAINS, FOUNDATION DRAINS, AND OTHER CLEAN WATER CONNECTIONS TO THE SANITARY SEWER SYSTEM ARE PROHIBITED.

STORM SEWER GENERAL NOTES:

- 1. ALL STORM SEWER PIPES SHALL BE MANUFACTURED WITH INTEGRAL BELL AND SPIGOT JOINTS INCLUDING A GASKET, SO AS TO PROVIDE A WATERTIGHT SEAL.
- 2. ALL STORM SEWER PIPES SHALL BE PVC SDR 35 WATERTIGHT PIPE CONFORMING TO ASTM SPECIFICATION D3034, UNLESS DENOTED OTHERWISE ON PLANS.
- 3. CONNECTIONS TO STRUCTURES SHALL BE MADE WATERTIGHT WITH NON-SHRINKING AND NON-CORROSIVE GROUT.

WATER GENERAL NOTES:

- 1. THE CONTRACTOR SHALL SUBMIT SHOP DRAWINGS TO BUTLER COUNTY SANITARY ENGINEER FOR PIPE, FITTINGS, JOINTS, HYDRANTS, VALVES AND BOXES, TAPPING SADDLES, AND CORPORATION STOPS.
- 2. WATER SERVICE MATERIAL LARGER THAN 2" SHALL BE DUCTILE IRON IN CONFORMANCE WITH ANSI A21.51 (AWWA C151) DUCTILE IRON PIPE, CENTRIFUGALLY CAST IN METAL MOLDS OR SAND LINED MOLDS, FOR WATER OR OTHER LIQUIDS AND ANSI A21.50 (AWWA C150) THICKNESS DESIGN OF IRON PIPE. ALL SERVICE LINES 2" OR LESS SHALL BE COPPER TYPE K. SIZE TO BE AS NOTED IN PLAN VIEW. SERVICE CONNECTION TO HAVE MINIMUM COVER OF 60" COVER.
- 3. ALL FITTINGS SHALL BE DUCTILE IRON IN CONFORMANCE WITH AWWA C110 OR AWWA C153. ALL FITTINGS SHALL BE RATED FOR 350 PSI WORKING PRESSURE, HAVE MECHANICAL JOINTS AND BE COATED AND CEMENT MORTAR LINED IN ACCORDANCE WITH AWWA C104. ALL BOLTS AND NUTS SHALL BE COR-TEN.
- 4. A TEN FEET MINIMUM HORIZONTAL SEPARATION (OUT-TO-OUT, CLEAR) WILL BE MAINTAINED BETWEEN THE WATER LINE AND SANITARY SEWER.
- 5. AN 18-INCH MINIMUM VERTICAL SEPARATION (OUT-TO-OUT, CLEAR) WILL BE MAINTAINED BETWEEN THE WATER LINE AND SANITARY SEWER AT ALL CROSSINGS.
- 6. A TEN FEET MINIMUM HORIZONTAL SEPARATION (OUT-TO-OUT, CLEAR) WILL BE MAINTAINED BETWEEN THE WATER LINE AND STORM SEWER.
- 7. AN 18-INCH MINIMUM VERTICAL SEPARATION (OUT-TO-OUT, CLEAR) WILL BE MAINTAINED BETWEEN THE WATER LINE AND STORM SEWER AT ALL CROSSINGS.

SWPPP GENERAL NOTES

- 1. ALL EROSION AND SEDIMENTATION CONTROL SHALL BE PERFORMED ACCORDING TO: SWPPP AND DETAIL PLANS; ACCORDING TO THE LATEST EPA AUTHORIZATION FOR CONSTRUCTION ACTIVITY UNDER THE "NATIONAL POLLUTANT DISCHARGE ELIMINATION SYSTEM" (NPDES); ANY AND ALL REQUIRED PERMITS, REPORTS, AND RELATED DOCUMENTS. ALL CONTRACTORS AND SUBCONTRACTORS MUST BECOME FAMILIAR WITH ALL OF THE ABOVE.
- 2. CONTRACTOR SHALL IMPLEMENT BEST MANAGEMENT PRACTICES (BMPS) AS REQUIRED BY THE SWPPP. ADDITIONAL BEST MANAGEMENT PRACTICES SHALL BE IMPLEMENTED AS DICTATED BY CONDITIONS AND GRADE CHANGES TO THE SITE AT NO ADDITIONAL COST TO OWNER THROUGHOUT ALL PHASES OF CONSTRUCTION
- 3. CONTRACTOR SHALL MINIMIZE CLEARING AND DISTURBANCE TO THE ENVIRONMENT TO THE MAXIMUM EXTENT POSSIBLE OR AS REQUIRED BY THE GENERAL PERMIT
- 4. SEDIMENT STRUCTURE AND PERIMETER SEDIMENT BARRIERS SHALL BE IMPLEMENTED AS THE FIRST STEP OF GRADING WITHIN SEVEN (7) DAYS FROM THE START OF CLEARING AND GRUBBING, AND SHALL CONTINUE TO FUNCTION UNTIL THE SLOPE DEVELOPMENT AREA IS RE-STABILIZED.
- 5. PERMANENT SOIL STABILIZATION OF DISTURBED AREAS BY MEANS OF VEGETATION, LANDSCAPE TYPE MULCHING, MATTING, SOD, RIP RAP, AND OTHER APPROVED LANDSCAPING TECHNIQUES TO BE APPLIED AS FOLLOWS:
- WITHIN SEVEN (7) DAYS OF ANY AREA THAT WILL BE DORMANT FOR ONE (1) YEAR OR MORE.
- WITHIN SEVEN (7) DAYS OF ANY AREA WITHIN 50 FEET OF A STREAM AT FINAL GRADE.
- WITHIN SEVEN (7) DAYS FOR ANY OTHER AREA AT FINAL GRADE.
- 6. TEMPORARY SOIL STABILIZATION OF DISTURBED AREAS BY MEANS OF TEMPORARY VEGETATION, MULCHING, GEOTEXTILES, SOD, PRESERVATION OF EXISTING
 - VEGETATION, AND OTHER APPROVED TECHNIQUES TO BE APPLIED AS FOLLOWS:

 WITHIN TWO (2) DAYS OF ANY AREA WITHIN 50 FEET OF A STREAM NOT AT FINAL GRADE.
 - WITHIN SEVEN (7) DAYS OF ANY AREA THAT WILL BE DORMANT FOR MORE THAN TWENTY ONE (21) DAYS, BUT LESS THAN ONE (1) YEAR.
 - PRIOR TO THE ONSET OF WINTER WEATHER FOR AREAS THAT WILL BE IDLE OVER WINTER.
- 7. TEMPORARY SEEDING, MULCHING, AND FERTILIZER SPECIFICATIONS:
 - SEEDING: ANNUAL RYEGRASS AT 2.02 POUNDS PER 1,000 S.F.
 - MULCHING: STRAW MATERIAL SHALL BE UNROTTED SMALL GRAIN STRAW APPLIED AT A RATE OF TWO (2) TON/ACRE, OR 80-100 POUNDS PER 1,000 S.F. MULCH MATERIALS SHALL BE RELATIVELY FREE OF ALL KINDS OF WEEDS AND SHALL BE FREE OF PROHIBITIVE NOXIOUS WEEDS. MULCH SHALL BE SPREAD UNIFORMLY BY HAND OR MECHANICAL MEANS. FROM NOVEMBER 01 THRU MARCH 15 INCREASE THE RATE OF STRAW MULCH TO THREE (3) TON/ACRE.
 - <u>FERTILIZER:</u> APPLY FERTILIZER AT HALF THE RATE OF PERMANENT APPLICATION AND AS PER ODOT SPECIFICATIONS. IF PROJECT CONDITIONS PREVENT FERTILIZING THE SOIL. THEN THIS ITEM MAY BE WAIVED.
- 8. SLOPES SHALL BE LEFT IN A ROUGHENED CONDITION DURING THE GRADING PHASE TO REDUCE RUNOFF VELOCITIES AND EROSION. ALL SLOPES 3:1 OR GREATER THAN 3:1 SHALL BE FERTILIZED, SEEDED, AND CURLEX BLANKETS BY AMERICAN EXCELSIOR COMPANY, NORTH AMERICAN GREEN, INC. OR AN APPROVED EQUAL AS SPECIFIED IN THE PLANS SHALL BE INSTALLED ON THE SLOPES.
- 9. NO SOLID (OTHER THAN SEDIMENT) OR LIQUID WASTE, INCLUDING BUILDING MATERIALS, SHALL BE DISCHARGED IN STORM WATER RUNOFF. ALL NON-SEDIMENT POLLUTANTS MUST BE DISPOSED OF IN ACCORDANCE WITH LOCAL, STATE, AND FEDERAL GUIDELINES. WASH OUT OF CEMENT TRUCKS SHOULD OCCUR IN DESIGNATED PIT OR DIKED AREAS, WHERE WASHINGS CAN BE REMOVED AND PROPERLY DISPOSED OFF-SITE WHEN THEY HARDEN. STORAGE TANKS SHOULD ALSO BE LOCATED IN PIT OR DIKED AREAS. IN ADDITION, SUFFICIENT OIL AND GREASE ABSORBING MATERIALS AND FLOTATION BOOMS TO CLEAN AND CONTAIN FUEL AND CHEMICAL SPILLS MUST BE KEPT ON SITE.
- 10. IF THE ACTION OF VEHICLES TRAVELING OVER THE STABILIZED CONSTRUCTION EXIT DOES NOT SUFFICIENTLY REMOVE MOST OF THE DIRT AND MUD, THEN THE TIRES MUST BE WASHED BEFORE VEHICLES ENTER A PUBLIC ROAD. PROVISIONS MUST BE MADE TO INTERCEPT THE WATER AND TRAP THE SEDIMENT BEFORE IT IS CARRIED OFF THE SITE.
- 11. RUBBISH, TRASH, GARBAGE, LITTER, OR OTHER SUCH MATERIALS SHALL BE DISPOSED INTO SEALED CONTAINERS. MATERIALS SHALL BE PREVENTED FROM LEAVING THE SITE THROUGH THE ACTION OF WIND OR STORM WATER DISCHARGE INTO DRAINAGE DITCHES OR WATERS OF THE STATE.
- DUST CONTROL USING APPROVED MATERIALS MUST BE PERFORMED AT ALL TIMES. THE USE OF MOTOR OILS AND OTHER PETROLEUM BASED OR TOXIC LIQUIDS FOR DUST SUPPRESSION IS PROHIBITED.
 ON-SITE AND OFF-SITE STOCKPILE AND BORROW AREAS SHALL BE PROTECTED FROM EROSION AND SEDIMENTATION BY THE USE OF BEST MANAGEMENT
- 14. ALL MATERIALS SPILLED, DROPPED, WASHED, OR TRACKED ONTO THE ROADWAYS OR INTO THE STORM SEWERS MUST BE REMOVED IMMEDIATELY.

FENCE TO BE PLACED AT PERIMETER OF STOCKPILE AREA TO PREVENT SOIL FROM LEAVING THE STOCKPILE AREA.

- 15. ALL CONSTRUCTION SHALL BE STABILIZED AT THE END OF EACH DAY; THIS INCLUDES BACKFILLING OF TRENCHES FOR UTILITY CONSTRUCTION AND PLACEMENT OF GRAVEL OR ASPHALT FOR ROAD CONSTRUCTION.
- 16. THE LAST LAYER OF SOIL, INCLUDING TOP SOIL SHOULD BE COMPACTED TO 80% 85% OF THE MAXIMUM STANDARD PROCTOR DENSITY, IN AREAS OUTSIDE THE PARKING LOT THAT WILL RECEIVE VEGETATION. THIS IS PARTICULARLY IMPORTANT IN CUT SLOPE AND EMBANKMENT AREAS. IN PAVEMENT AND ISLAND AREAS, IT IS RECOMMENDED THAT THE SOIL BE COMPACTED TO 98% AND 95% OF THE MAXIMUM STANDARD PROCTOR DENSITY RESPECTIVELY; THE LAST COMPACTED LAYER MAY BE SCARIFIED TO IMPROVE THE SOIL GROWTH CHARACTERISTICS.

PRACTICES. THESE AREAS MUST BE SHOWN IN THE SITE MAP AND PERMITTED IN ACCORDANCE WITH GENERAL PERMIT REQUIREMENTS. AT A MINIMUM SILT

- 17. ALL DEWATERING ACTIVITIES SUCH AS PUMPING DOWN OF FLOODED FOUNDATION AND UTILITY TRENCHES MUST PASS THROUGH THE RETROFITTED DETENTION BASIN OR A SEDIMENT CONTROL PRACTICE PRIOR TO LEAVING THE SITE.
- 18. SILT FENCE AND OTHER PERIMETER EROSION CONTROL MEASURES SHOWN OFF LIMITS OF DISTURBANCE FOR CLARITY PURPOSES ONLY. CONTRACTOR TO ENSURE PERIMETER EROSION CONTROL MEASURES ARE PLACED AT THE LIMITS OF DISTURBANCE. ANY DISCREPANCIES SHOULD BE BROUGHT TO THE ENGINEER PRIOR TO PLACEMENT OF ANY EROSION CONTROL MEASURES.
- 19. CONTRACTOR TO OBTAIN A COMMERCIAL LOT EROSION & SEDIMENT CONTROL PERMIT FROM BUTLER COUNTY STORMWATER DISTRICT DURING BUILDING PERMIT REVIEW. PERMIT APPLICATION CAN BE DOWNLOADED FROM WWW.STORMWATERDISTRICT.ORG

SWPPP MAINTENANCE NOTES


- 1. ALL CONTROL MEASURES STATED IN THE SWPPP SHALL BE MAINTAINED IN FULLY FUNCTIONAL CONDITION UNTIL TEMPORARY OR PERMANENT STABILIZATION OF THE SITE IS ACHIEVED. ALL EROSION AND SEDIMENTATION CONTROL MEASURES SHALL BE INSPECTED BY A QUALIFIED PERSON IN ACCORDANCE TO THE CONTRACT DOCUMENTS OR THE APPLICABLE PERMIT, WHICHEVER IS MORE STRINGENT, AND REPAIRED ACCORDING TO THE FOLLOWING:
- 2. INLET PROTECTION DEVICES AND CONTROLS SHALL BE REPAIRED OR REPLACED WHEN THEY SHOW SIGNS OF UNDERMINING AND OR DETERIORATION. INLET PROTECTION DEVICES SHOULD BE ROUTINELY CLEANED AND MAINTAINED.
- 3. ALL SEEDED AREAS SHALL BE CHECKED REGULARLY TO ENSURE THAT A GOOD STANDING OF GRASS IS MAINTAINED. AREAS SHOULD BE FERTILIZED, WATERED, AND RESEEDED AS NEEDED.
- 4. MINIMIZE OFF-SITE SEDIMENT TRACKING OF VEHICLES BY THE USE OF STONE MATERIAL IN ALL CONSTRUCTION ENTRANCES, ALONG WITH REGULARLY SCHEDULED SWEEPING/GOOD HOUSEKEEPING. STABILIZED CONSTRUCTION ENTRANCES TO BE PROPERLY MAINTAINED BY GENERAL CONTRACTOR AND IN GOOD WORKING ORDER AT ALL TIMES; THIS MAY REQUIRE PERIODIC TOP DRESSING OF THE STONE AS CONDITIONS DEMAND.
- 5. THE TEMPORARY PARKING AND STORAGE AREA SHALL BE KEPT IN GOOD CONDITION (SUITABLE FOR PARKING AND STORAGE) BY GENERAL CONTRACTOR. THIS MAY REQUIRE PERIODIC TOP DRESSING OF THE TEMPORARY PARKING AS CONDITIONS DEMAND.
- 6. CONTRACTORS AND SUBCONTRACTORS WILL BE RESPONSIBLE FOR REMOVING ALL SEDIMENT FROM THE SITE, AND STORM SEWER SYSTEMS. SEDIMENT DEPOSITION DURING SITE STABILIZATION MUST ALSO BE REMOVED.
- 7. STONE CONSTRUCTION EXIT TO BE MAINTAINED BY GENERAL CONTRACTOR UNTIL SITE HAS BEEN PAVED OR IS NO LONGER REQUIRED.
- 8. ALL CATCH BASIN GRATES ARE TO BE PROTECTED WITH INLET BAGS AFTER THEY ARE INSTALLED. THEY SHOULD BE ROUTINELY CLEANED AND MAINTAINED
- 9. CONTAINERS SHALL BE AVAILABLE FOR DISPOSAL OF DEBRIS, TRASH, HAZARDOUS OR PETROLEUM WASTES. ALL CONTAINERS MUST BE COVERED AND LEAK-PROOF. ALL WASTE MATERIAL SHALL BE DISPOSED OF AT FACILITIES APPROVED FOR THE PERTINENT MATERIAL
- 10. BRICKS, HARDENING CONCRETE AND SOIL WASTE SHALL BE FREE FROM CONTAMINATION WHICH MAY LEACH CONSTITUENTS TO WATERS OF THE STATE
- 11. CLEAN CONSTRUCTION WASTES THAT WILL BE DISPOSED INTO THE PROPERTY SHALL BE SUBJECT TO ANY LOCAL PROHIBITIONS FROM THIS TYPE OF
- 12. ALL CONSTRUCTION AND DEMOLITION DEBRIS (C&DD) WASTE SHALL BE DISPOSED OF IN AN APPROVED C&DD LANDFILL. ALSO, MATERIALS WHICH CONTAIN ASBESTOS MUST COMPLY WITH AIR POLLUTION REGULATIONS.
- 13. AREA SHALL BE DESIGNATED BY CONTRACTOR AND SHOWN ON SWPPP MAP FOR MIXING OR STORAGE OF COMPOUNDS SUCH AS FERTILIZERS, LIME ASPHALT OR CONCRETE, THESE DESIGNATED AREAS SHALL BE LOCATED AWAY FROM WATERCOURSES, DRAINAGE DITCHES, FIELD DRAINS, OR OTHER STORMWATER
- 14. EQUIPMENT FUELING & MAINTENANCE SHALL BE IN DESIGNATED AREAS ONLY.
- 15. A SPILL PREVENTION CONTROL AND COUNTERMEASURE (SPCC) PLAN MUST BE DEVELOPED FOR SITES WITH ONE ABOVE-GROUND STORAGE TANK OF 660 GALLONS OR MORE, TOTAL ABOVE-GROUND STORAGE OF 1,330 GALLONS OR BELOW-GROUND STORAGE OF 4,200 GALLONS OF FUEL.
- 16. ALL DESIGNATED CONCRETE WASHOUT AREAS SHALL BE LOCATED AWAY FROM WATERCOURSES, DRAINAGE DITCHES, FIELD DRAINS OR OTHER STORMWATER DRAINAGE AREAS.
- 17. ALL CONTAMINATED SOIL MUST BE TREATED AND/OR DISPOSED IN AN OHIO EPA APPROVED SOLID WASTE MANAGEMENT FACILITY OR HAZARDOUS WASTE TREATMENT, STORAGE OR DISPOSAL FACILITIES.
- 18. THE CONTRACTOR SHALL CONTACT THE OHIO EPA, THE LOCAL FIRE DEPARTMENT AND THE LOCAL EMERGENCY PLANNING COMMITTEE IN THE EVENT OF A PETROLEUM SPILL (>25 GALLONS) OR THE PRESENCE OF SHEEN.
- 19. OPEN BURNING IS NOT PERMITTED ON THE SITE.
- 20. CONTRACTOR TO ENSURE STREETS SHALL BE CLEARED OF DEBRIS FROM SITE AND SWEPT CLEAN ON AN AS NEEDED BASIS.

QUANTITIES SUMMARY						
ITEM	QUANTITY	UNIT				
6" CONCRETE PAVEMENT, ON-SITE	33,538	SQ. FT.				
7" CONCRETE PAVEMENT, APPROACHES	2,156	SQ. FT.				
8" CONCRETE PAVEMENT, ON-SITE	1,705	SQ. FT.				
CONCRETE CURB, ON-SITE/APPROACHES	915	LIN. FT.				
SIDEWALK, NOT ADJACENT TO STORE	146	SQ. FT.				
DETENTION SYSTEM	N/A	CU. FT.				
WATER MAIN	338	LIN. FT.				
SEWER SERVICE - SDR 35 (DIRECT BURY)	97	LIN. FT.				
WATER SERVICE - TYPE K SOFT COPPER (DIRECT BURY)	338	LIN. FT.				
STORM PIPING - HDPE	414	LIN. FT.				
STORM DOWNSPOUT PIPING - PVC	411	LIN. FT.				
SANITARY SEWER CLEANOUT	4	EACH				
STORM SEWER CLEANOUT	6	EACH				
GREASE TRAP	1	EACH				
STORM STRUCTURES	5	EACH				
NYLOPLAST 30" MANHOLE	1	EACH				
WATER QUALITY DEVICE	N/A	EACH				
EARTHWORK CUT & HAUL	TBD	CU. YD.				
EARTHWORK CUT & RESPREAD	TBD	CU. YD.				
EARTHWORK IMPORT & PLACE	TBD	CU. YD.				
6' TALL CHAIN LINK FENCE	N/A	LIN. FT.				
SOD AREA	22,096	SQ. FT.				
SEED AREA	N/A	SQ. FT.				
ASPHALT PAVEMENT DEMOLITION, ON-SITE	N/A	SQ. FT.				
CONCRETE PAVEMENT DEMOLITION, ON-SITE	N/A	SQ. FT.				
GRAVEL DEMOLITION, ON-SITE	N/A	SQ. FT.				
BUILDING DEMOLITION - FRAME GARAGE	N/A	SQ. FT.				
BUILDING DEMOLITION - ONE AND ONE-HALF STORY HOME	N/A	SQ. FT.				
BUILDING DEMOLITION - ONE-STORY FRAME COMMERCIAL	N/A	SQ. FT.				
BUILDING DEMOLITION - TWO-STORY FRAME COMMERCIAL	N/A	SQ. FT.				
*CONTRACTOR TO PROVIDE A COMPLETE QUANTITIES TABLE QUANTITIES PROVIDED AS PART OF THIS SUMMARY ARE FOR						

*CONTRACTOR TO PROVIDE A COMPLETE QUANTITIES TABLE PER THE CONSTRUCTION DOCUMENTS, QUANTITIES PROVIDED AS PART OF THIS SUMMARY ARE FOR REFERENCE PURPOSES ONLY AND ARE NOT A BASIS FOR CHANGE ORDER IF ADDITIONAL QUANTITY IS INSTALLED AS PART OF THE ORIGINAL RID DOCUMENTS.





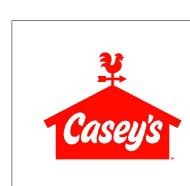

FERAL STORES

HAMILTON

GENERAL NOTES

SENERAL NOTE

CIVIL PERMIT SET

 05.19.2021

 JOB NO.:
 756995


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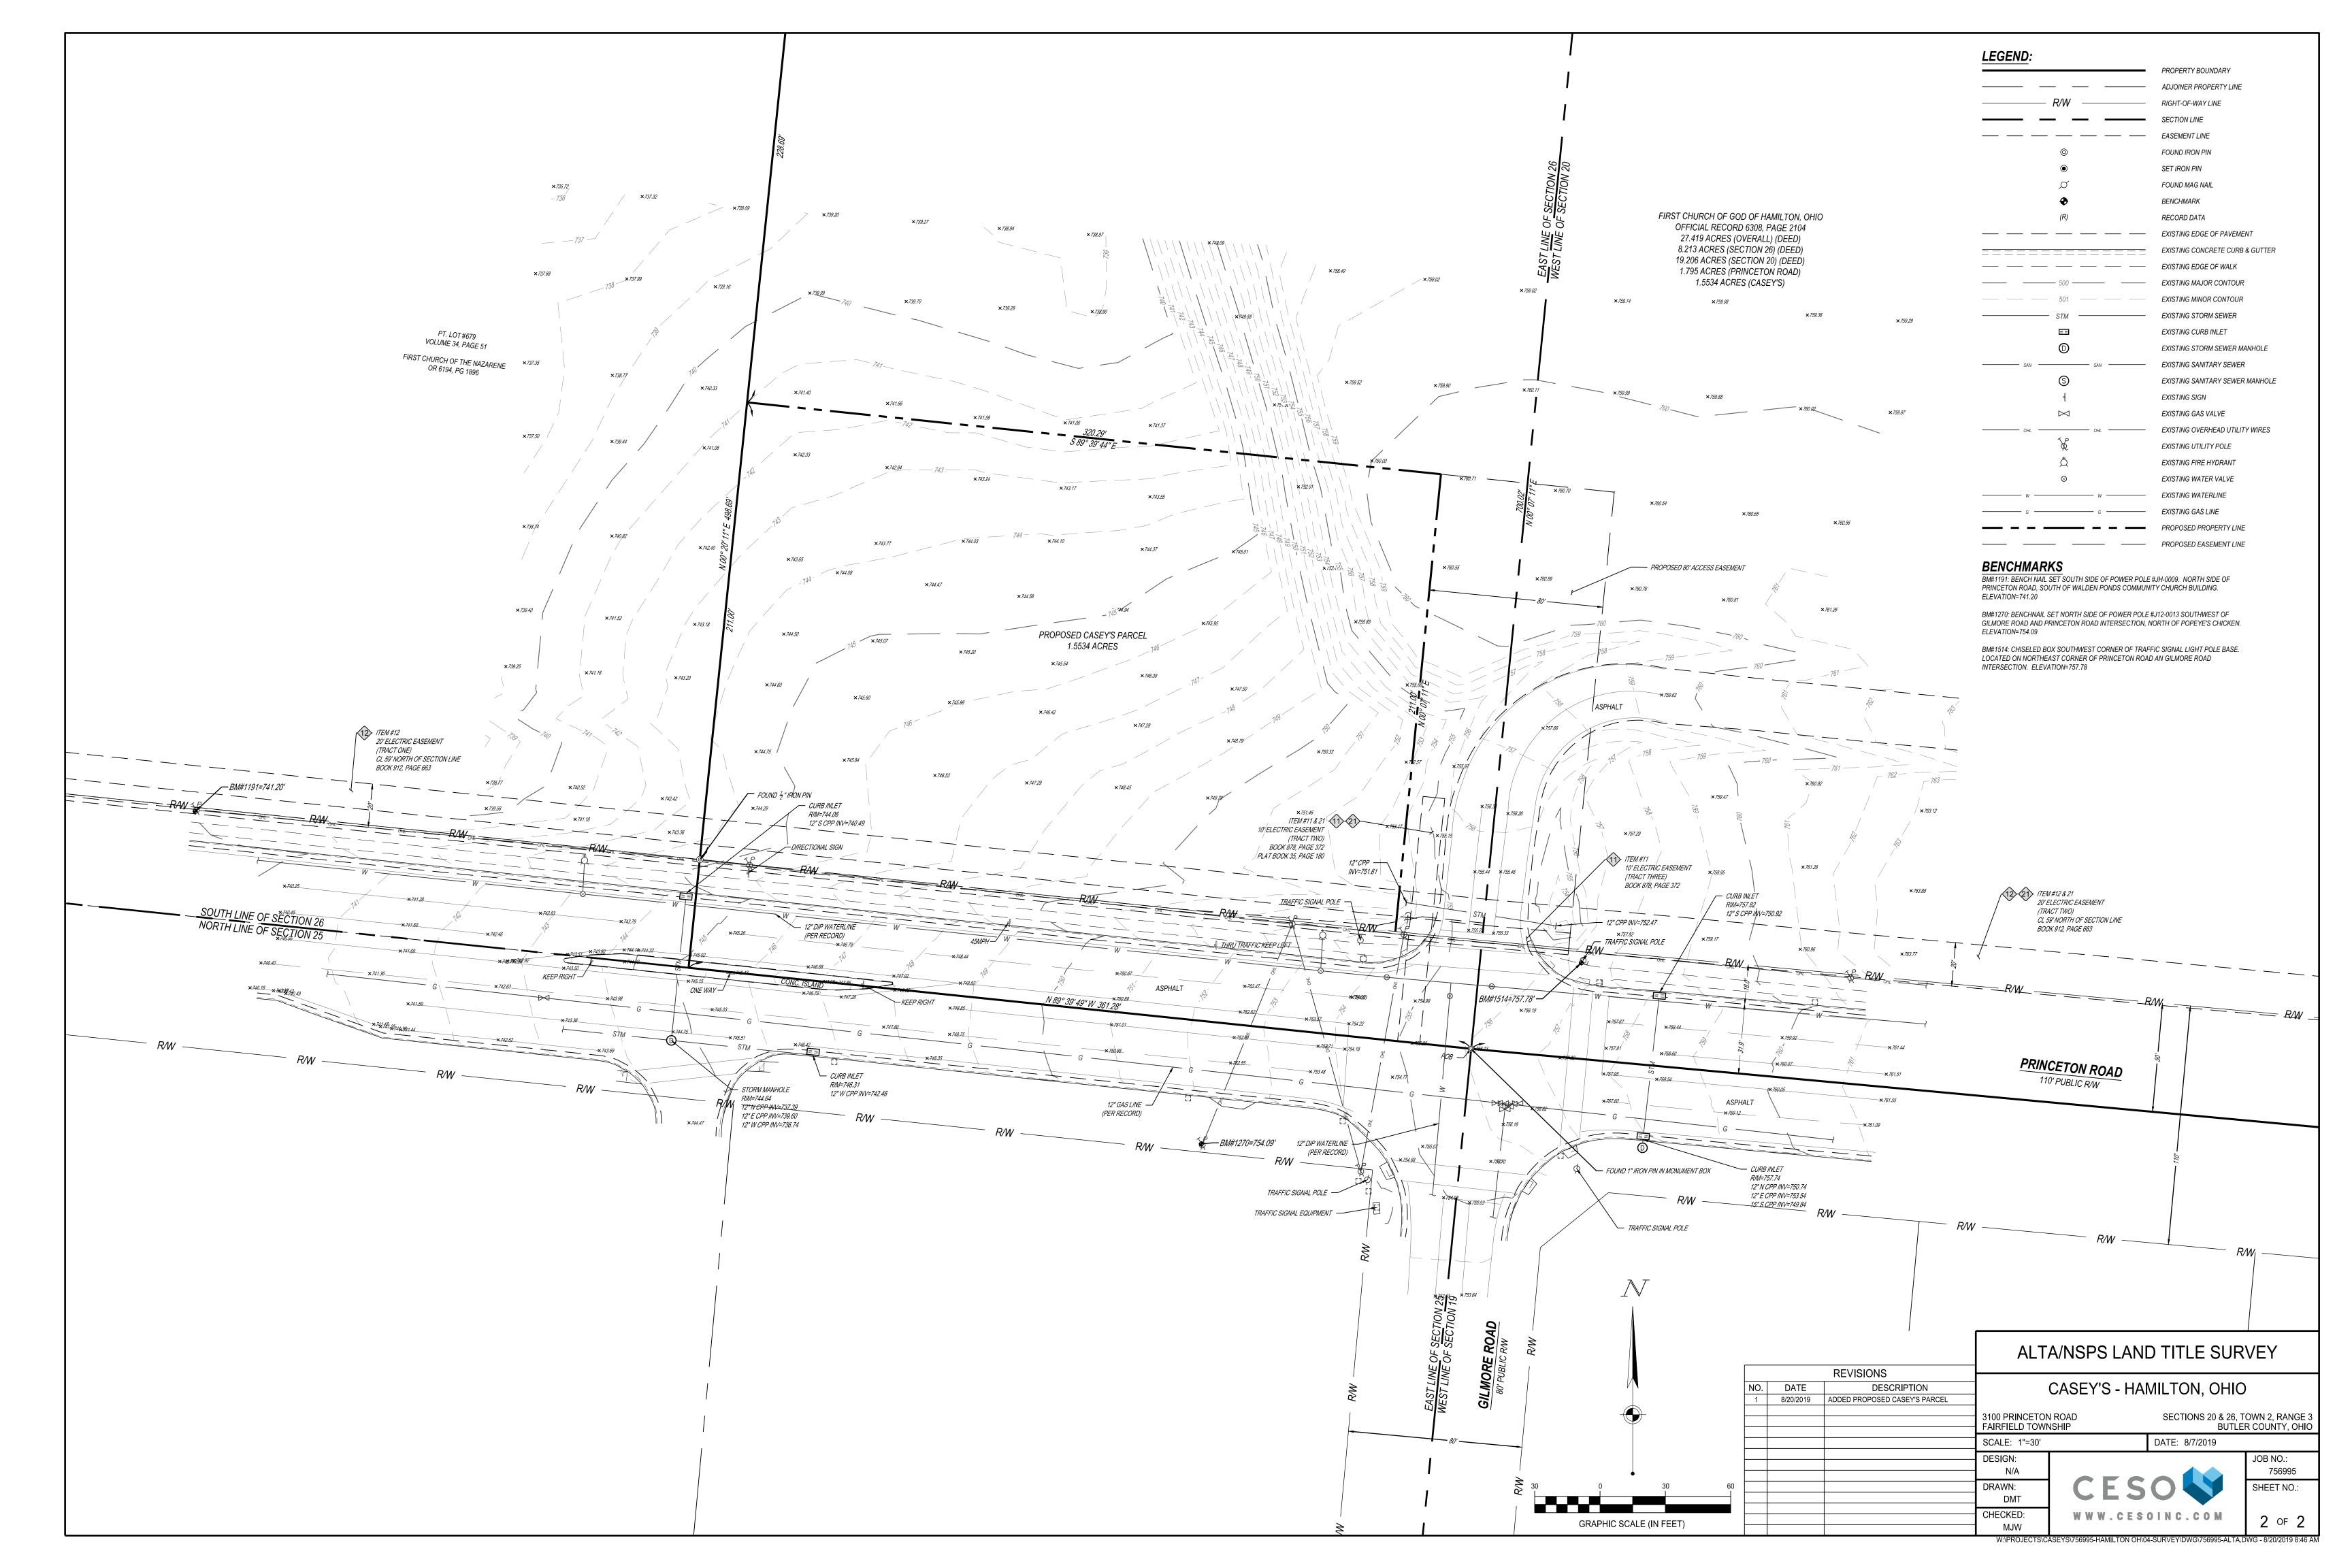
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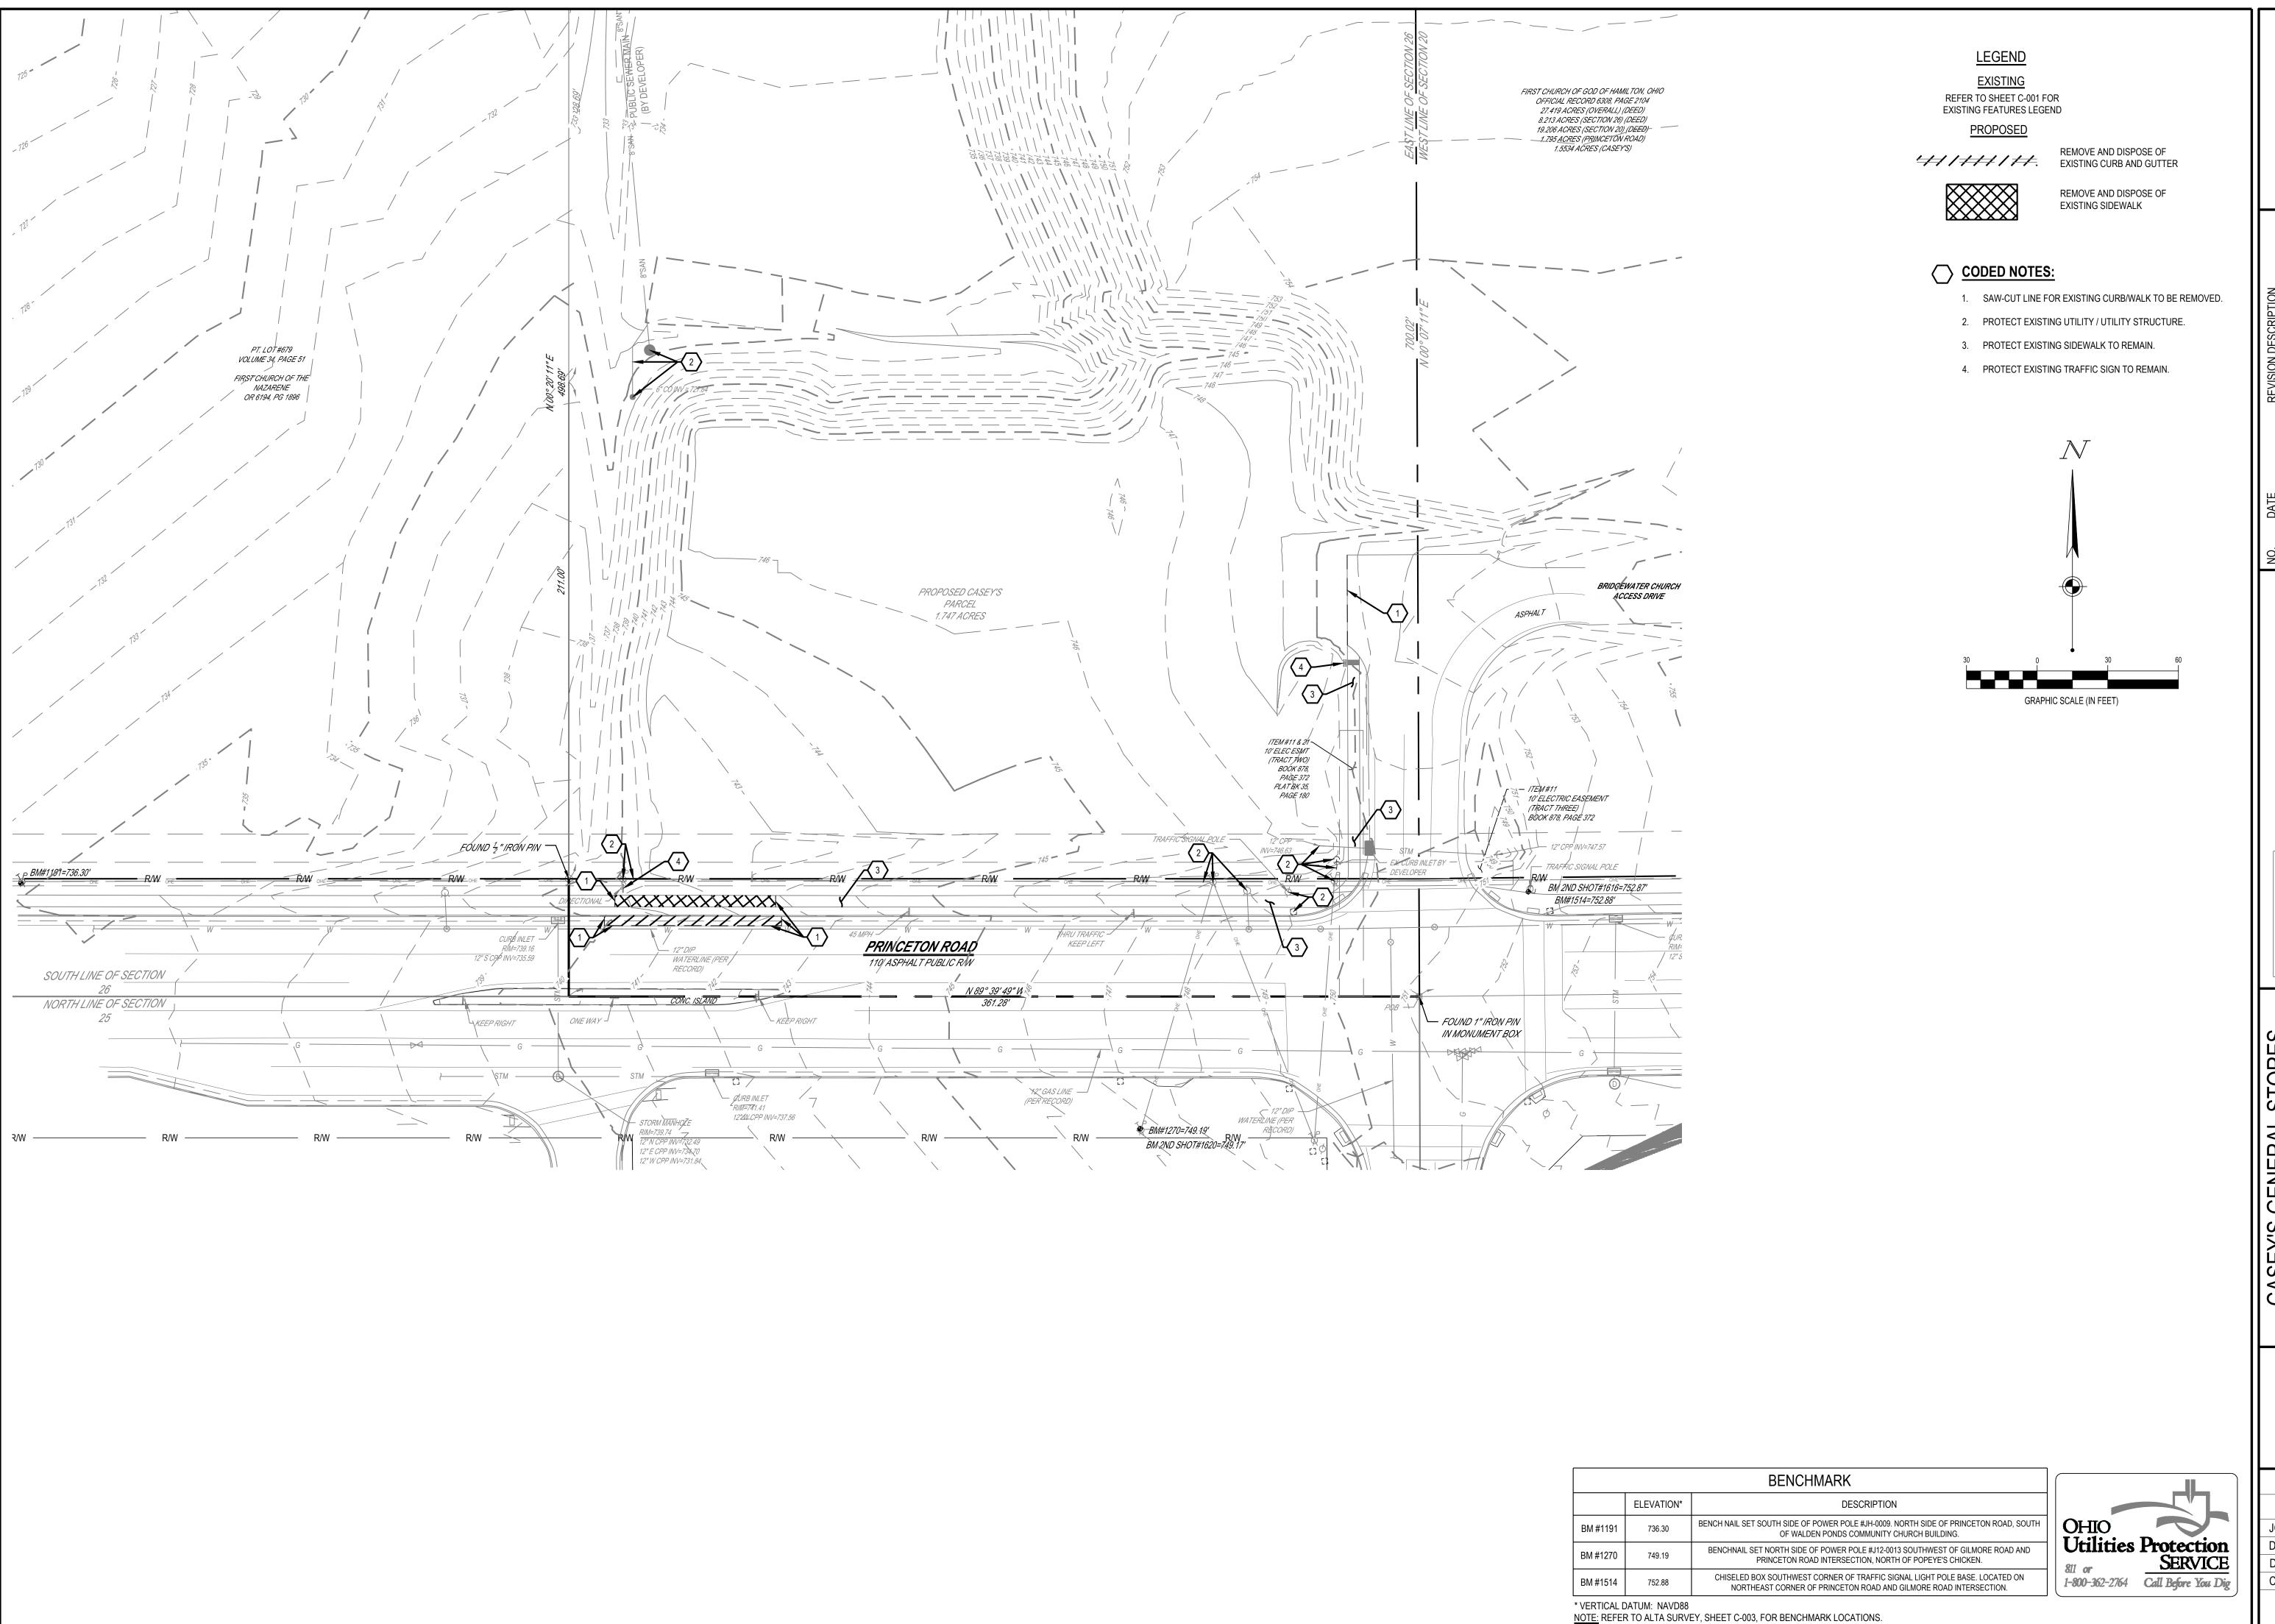
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 SHEET NO.

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REVISION DESCRIPTION







EY'S GENERAL STORES
HAMILTON, OH

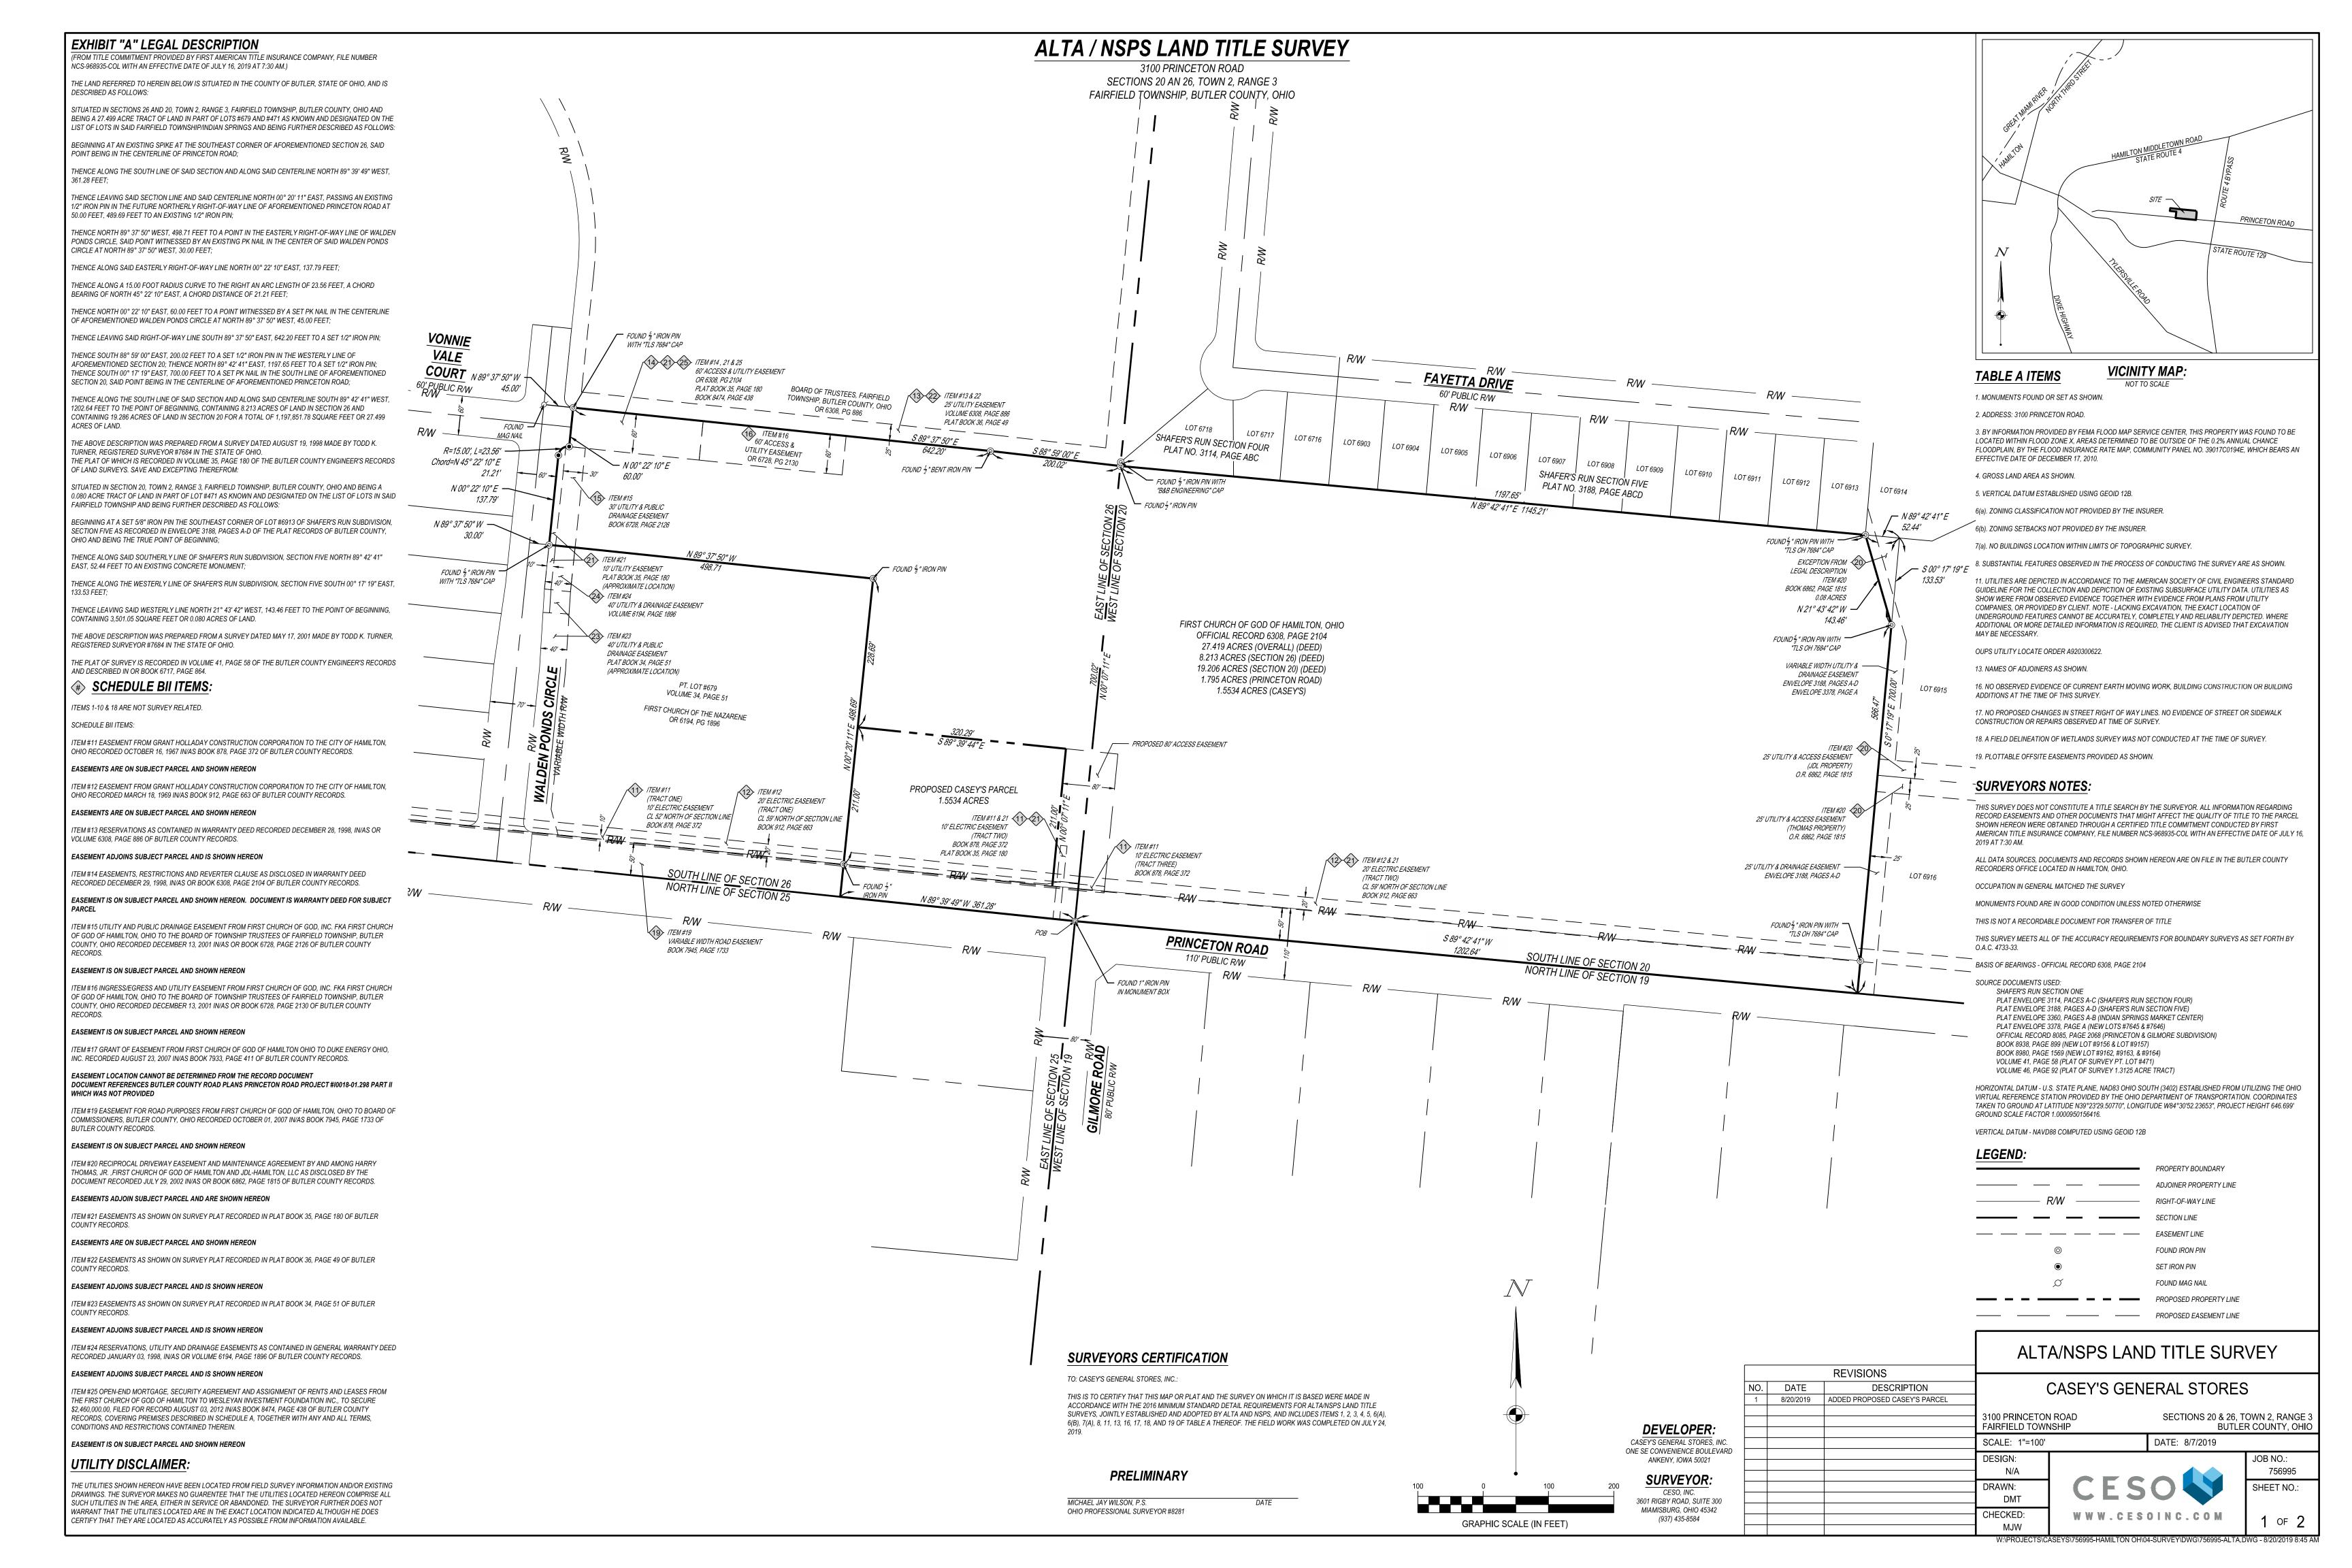
DEMOLITION PLAN

		UE: RMIT SET						
	DATE: 05.19.2021							
`	JOB NO.:	756995						
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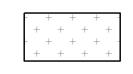
///////, CANOPY CONCRETE CURB --- PAVEMENT/WALK — — — — — — — — — PAVEMENT DELINEATION ——— EASEMENT LINE

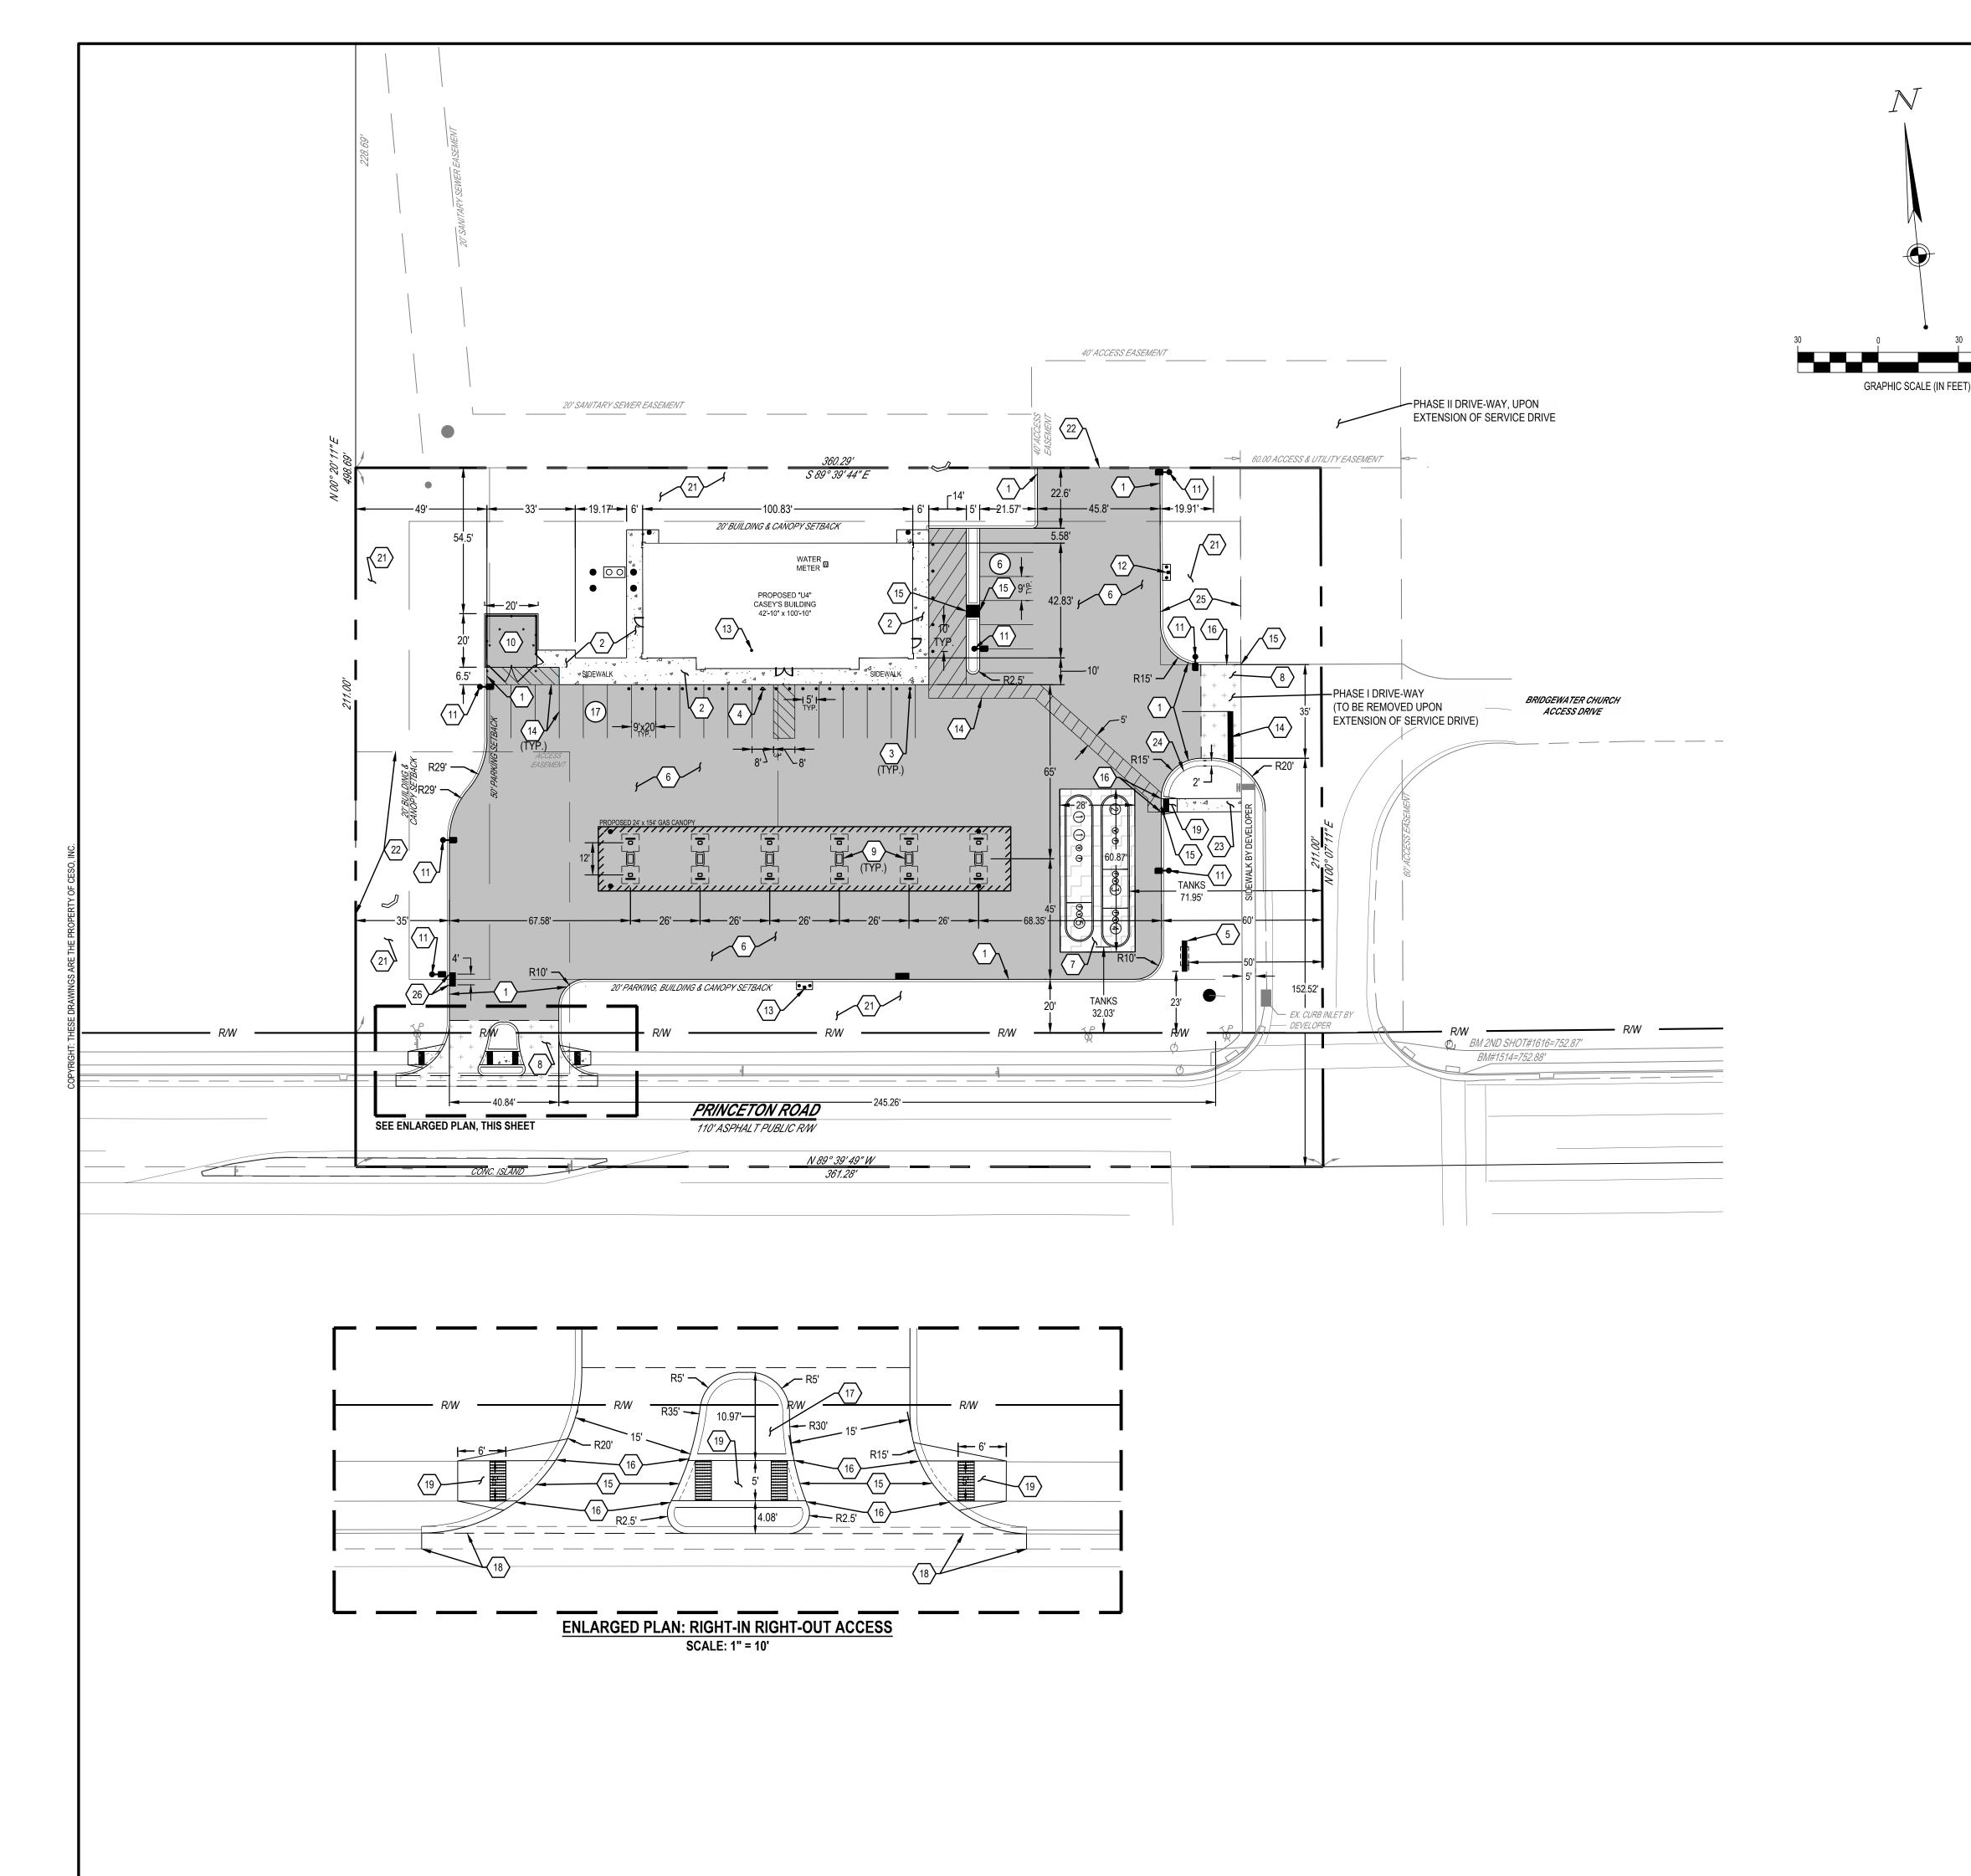

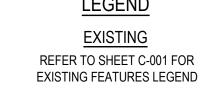STANDARD CONCRETE PAVEMENT (SIDEWALK)

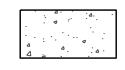


STANDARD CONCRETE PAVEMENT (PARKING)




APPROACH CONCRETE PAVEMENT

UGST AREA HEAVY-DUTY CONCRETE

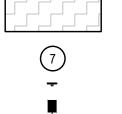

PARKING SPACE COUNT



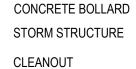

PAVEMENT

CODED NOTES:

- 1. PROPOSED 6" INTEGRAL CURB. SEE DETAIL 2 ON SHEET C-601.
- 2. PROPOSED SIDEWALK. SEE DETAIL 1 ON SHEET C-601.
- 3. CASEY'S TYPICAL BOLLARD. SEE DETAIL 1 ON SHEET C-601.
- 4. CONTRACTOR TO INSTALL HANDICAPPED SIGN PER DETAIL 12 ON SHEET C-601 AND ACCORDING TO ALL LOCAL, STATE AND FEDERAL REGULATIONS.
- 5. CASEY'S MONUMENT SIGN, PER SIGNAGE PLAN.
- 6. PROPOSED STANDARD CONCRETE PARKING PAVEMENT. SEE DETAIL 2
- 7. PROPOSED UGST AREA HEAVY DUTY CONCRETE PAVEMENT. SEE DETAIL 2 ON SHEET C-601.
- 8. PROPOSED APPROACH CONCRETE PAVEMENT. SEE DETAIL 2 ON SHEET C-601.
- 9. PROPOSED GAS TAPERED FUEL ISLAND. SEE DETAIL 1 ON SHEET
- 10. PROPOSED 20' X 20' DUMPSTER AND PAD. SEE ARCHITECTURAL PLANS
- 11. PROPOSED SITE LIGHT POLE. SEE PHOTOMETRIC PLAN FOR DETAILS
- AND DETAIL ON SHEET C-603. 12. AIR COMPRESSOR BOX, MOUNTED TO STEEL POLE, INSTALLED ON CONCRETE PAD 16" FROM BACK OF CURB. 110 VOLT-60HZ-5.5 AMP. 8
- GAUGE MIN. RECOMMENDED. 13. EMERGENCY SHUTOFF FOR GASOLINE DISPENSERS. ALL DISPENSERS FALL WITHIN A 100 FOOT RADIUS OF SHUTOFF.
- 14. PROPOSED PAVEMENT MARKINGS.
- 15. FLUSH CURB.

FOR DETAILS.

- 16. TRANSITION CURB FROM FLUSH TO FULL HEIGHT IN 12".
- 17. PROPOSED DRIVEWAY CURB ISLAND. SEE DETAIL 5 ON SHEET C-601.
- 18. PROPOSED 1" DROP CURB AND GUTTER PER ODOT STD DWG BP-4.1.
- 19. PROPOSED CURB RAMP WITH DETECTABLE WARNING SURFACE PER ODOT STD DWG BP-7.1
- 20. PROPOSED 5' SIDEWALK WITH DETECTABLE WARNING SURFACE WITHIN RIGHT-OF-WAY PER ODOT STD DWG BP-7.1
- 21. PROPOSED GREENSPACE FOR B-PUD OPEN SPACE REQUIREMENT.
- 22. PROPOSED CROSS-ACCESS EASEMENT FOR FUTURE DEVELOPMENT.
- 23. PROPOSED CONCRETE SIDEWALK PER BUTLER COUNTY STANDARDS.
- 24. PROPOSED LANDSCAPE PROTECTOR. SEE DETAIL 4 ON SHEET C-601. 25. PROPOSED 30' TEMPORARY GRADING EASEMENT FOR WORK BY

C-201 FOR FURTHER DETAIL.

DEVELOPER. 26. PROPOSED 3" INTEGRAL CURB FOR EMERGENCY SPILLWAY. REFER TO

C	DATA	SITE
(1.747 AC (76,099 SF)	TOTAL SITE AREA
81	1.018 AC (44,364 SF, 58%)	PROPOSED IMPERVIOUS AREA

0.729 AC (31,735 SF, 42%)

PROPOSED OPEN SPACE AREA





REVISION DESCRIPTION													
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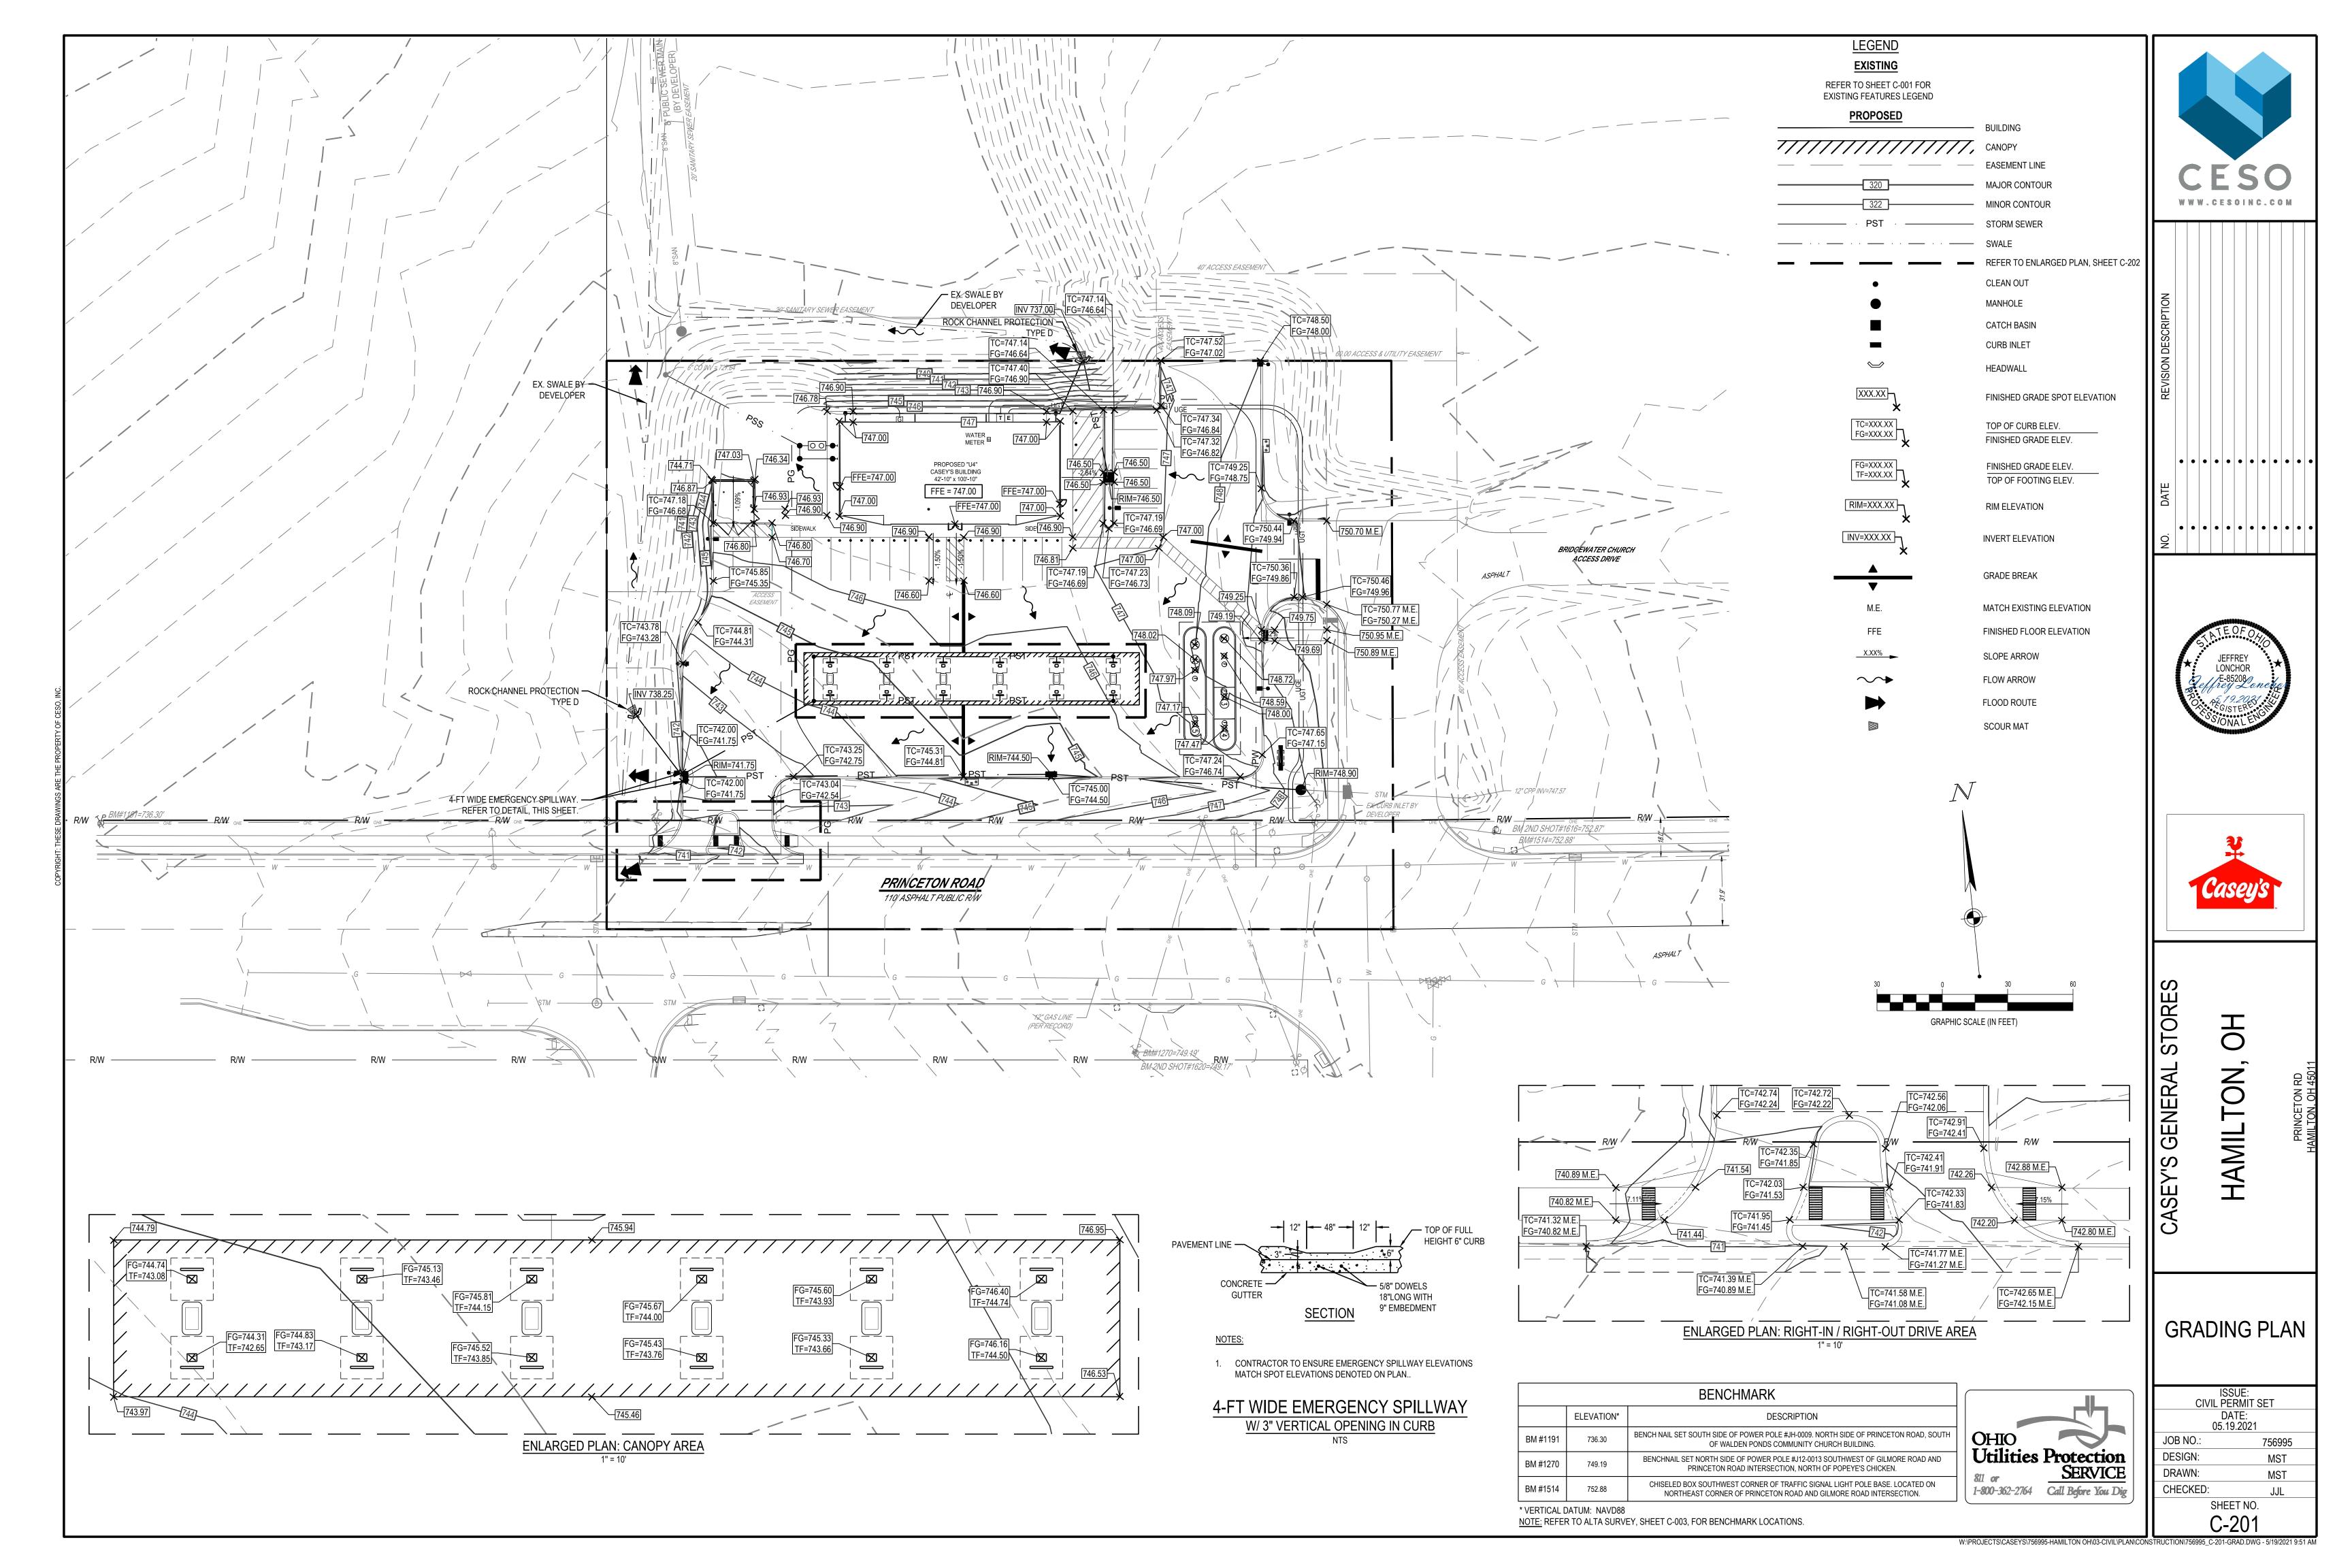





TON, HAMIL

SITE PLAN

ISSUE: CIVIL PERMIT SET 05.19.2021 JOB NO.: DESIGN: DRAWN: MST CHECKED: SHEET NO.



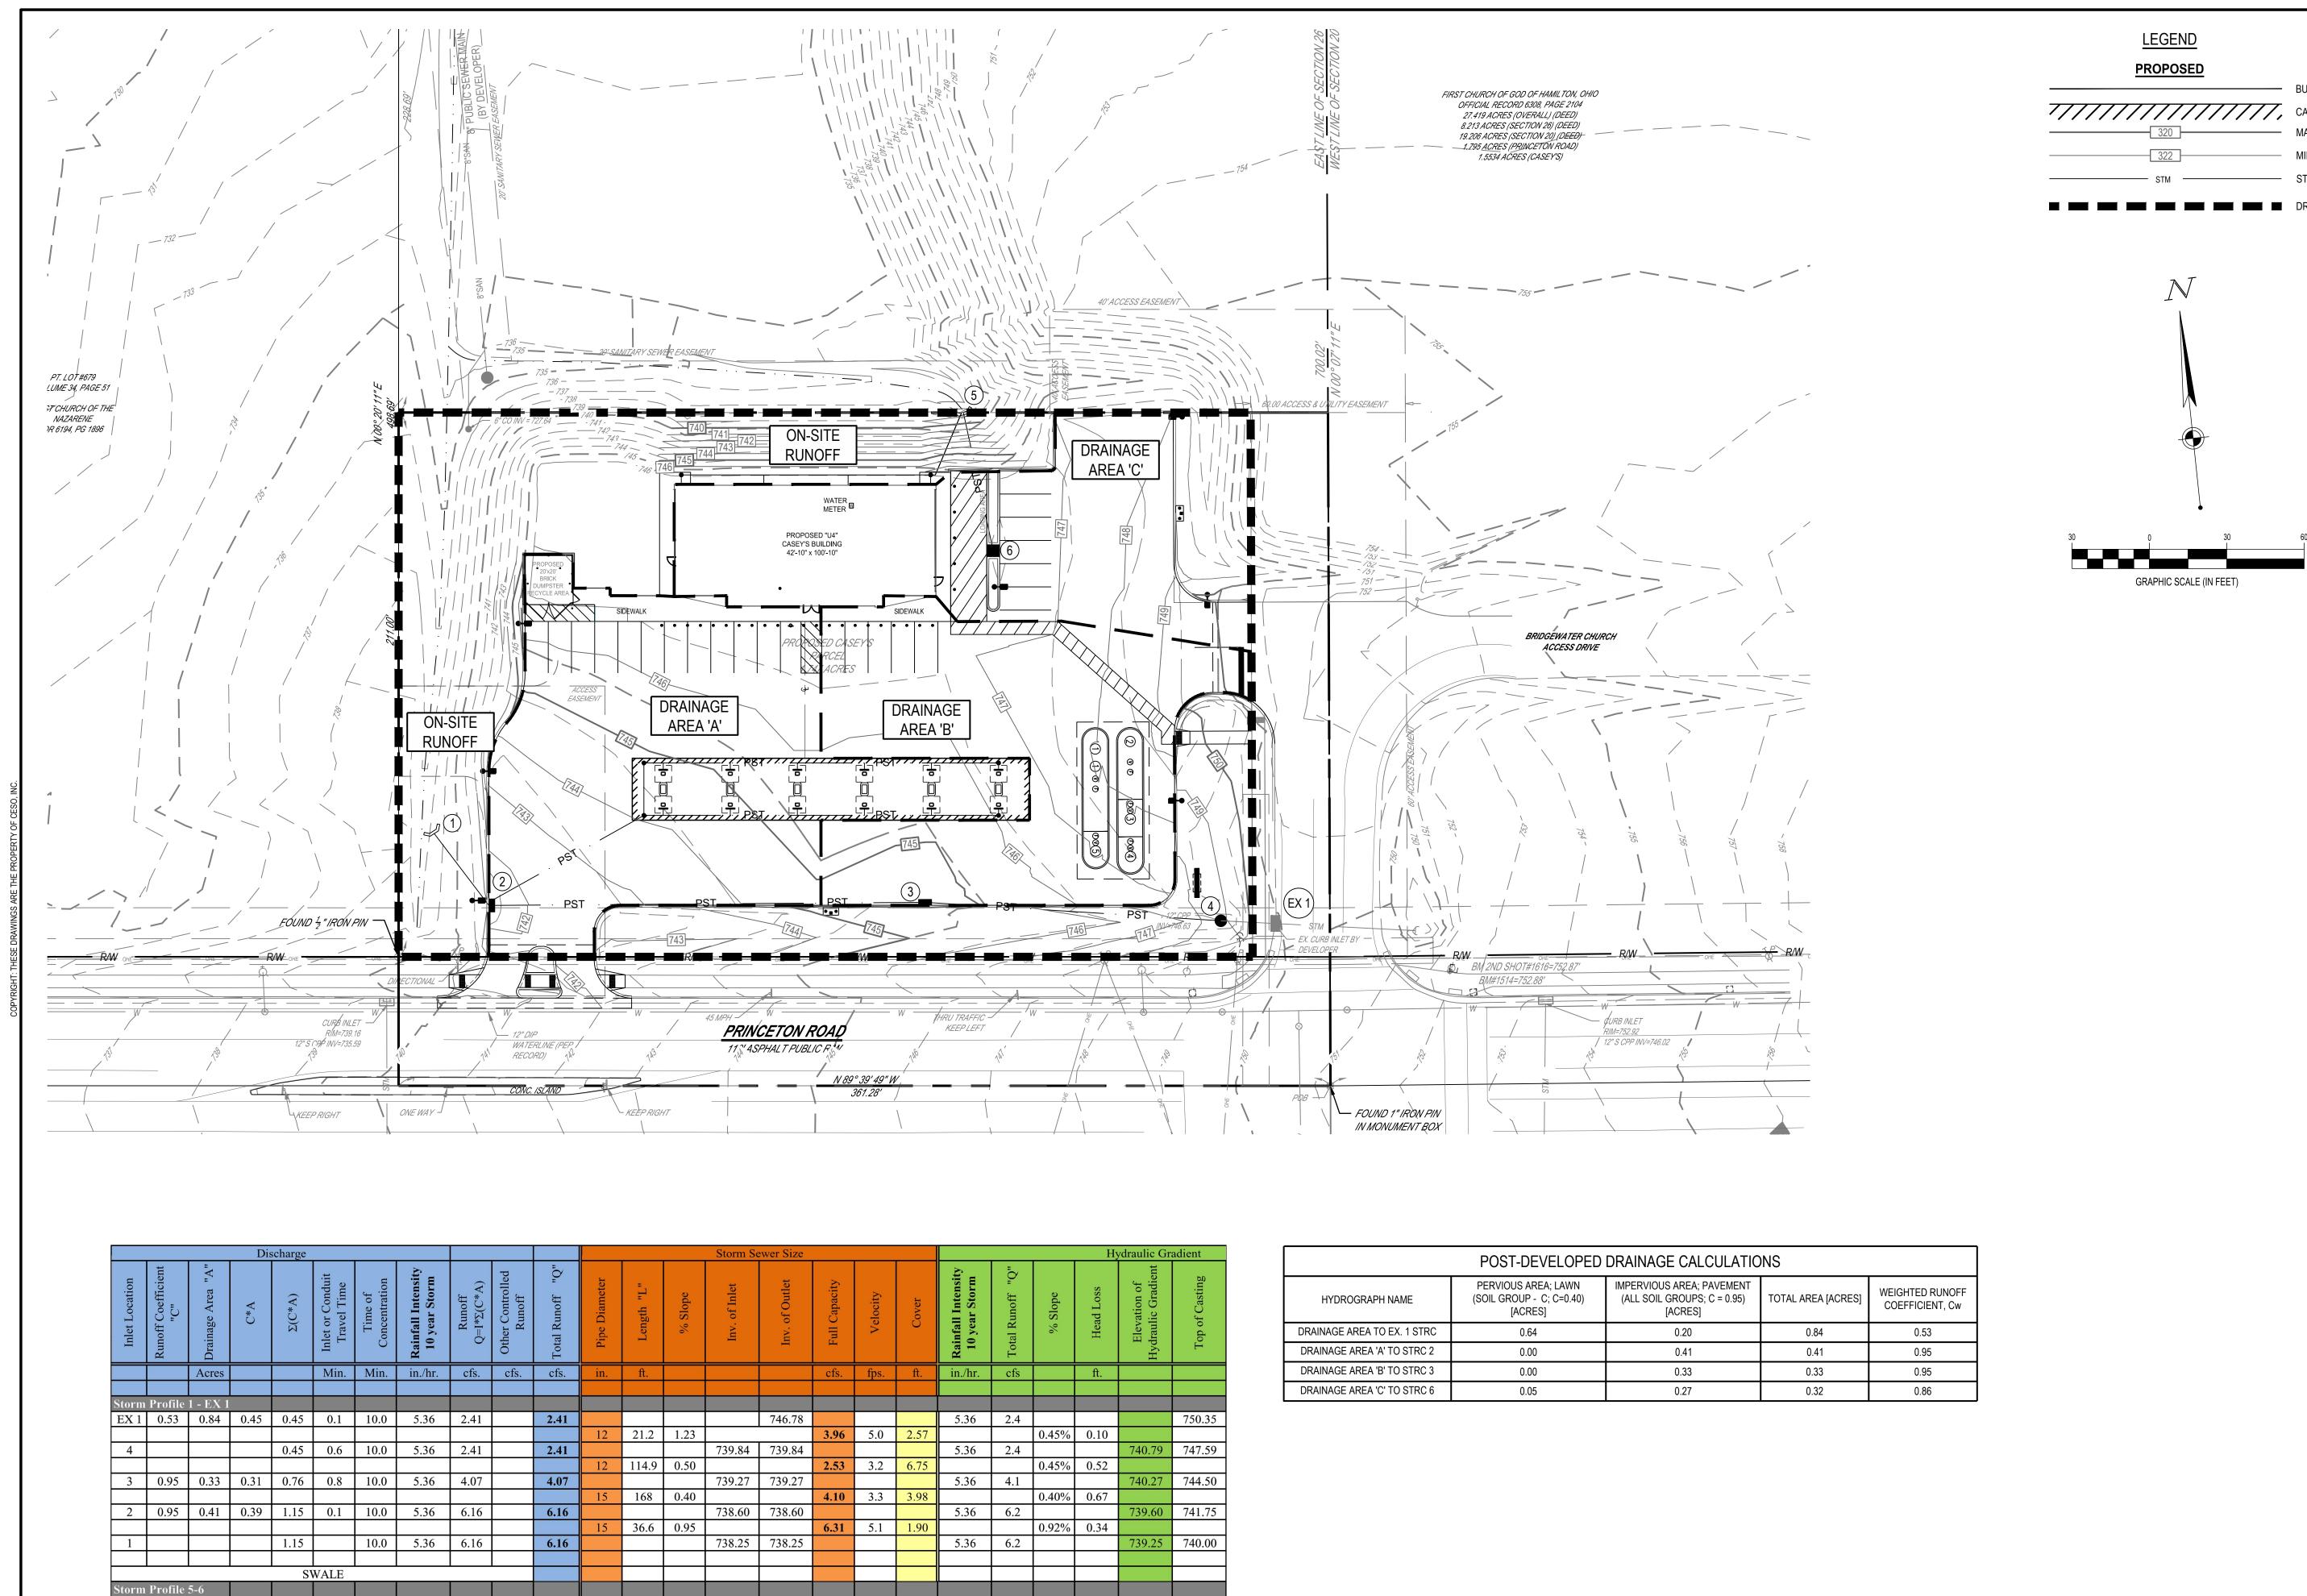

739.36 746.50

739.26 740.00

0.18% 0.10

5.36 1.5

6 | 0.86 | 0.32 | 0.28 | 0.28 | 0.3 | 10.0 | 5.36 | 1.50

0.28

SWALE

10.0 5.36 1.50

1.50


1.50


55.5 0.50

738.74

738.46 738.46

2.53 3.2 6.76

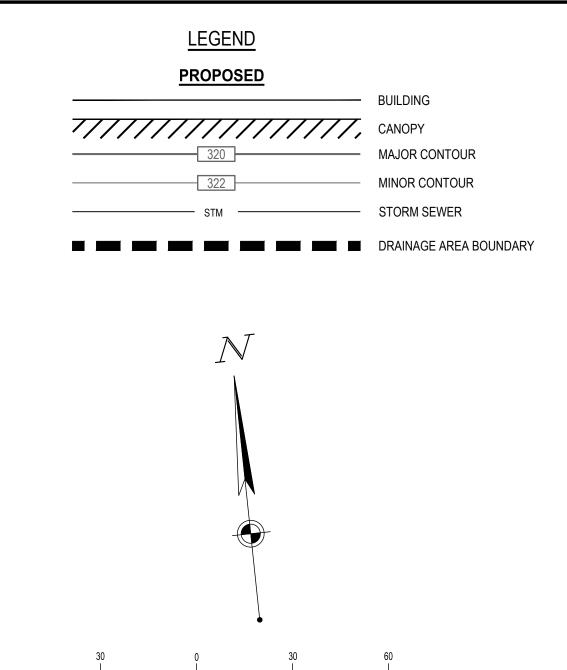

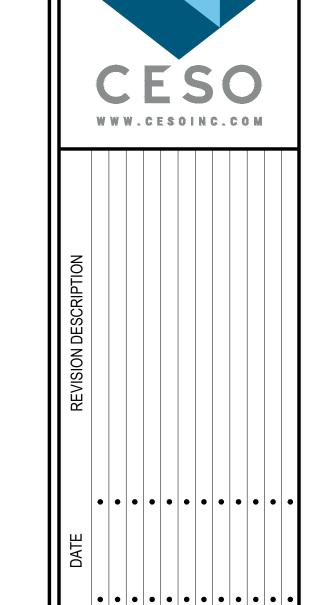






HAMILTON

TRIBUTARY AREA

	UE: RMIT SET
DA 05.19	TE: .2021
JOB NO.:	756995
DESIGN:	MST
DRAWN:	MST
CHECKED:	JJL
SHEE	T NO.

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REFER TO SHEET C-001 FOR EXISTING FEATURES LEGEND PROPOSED

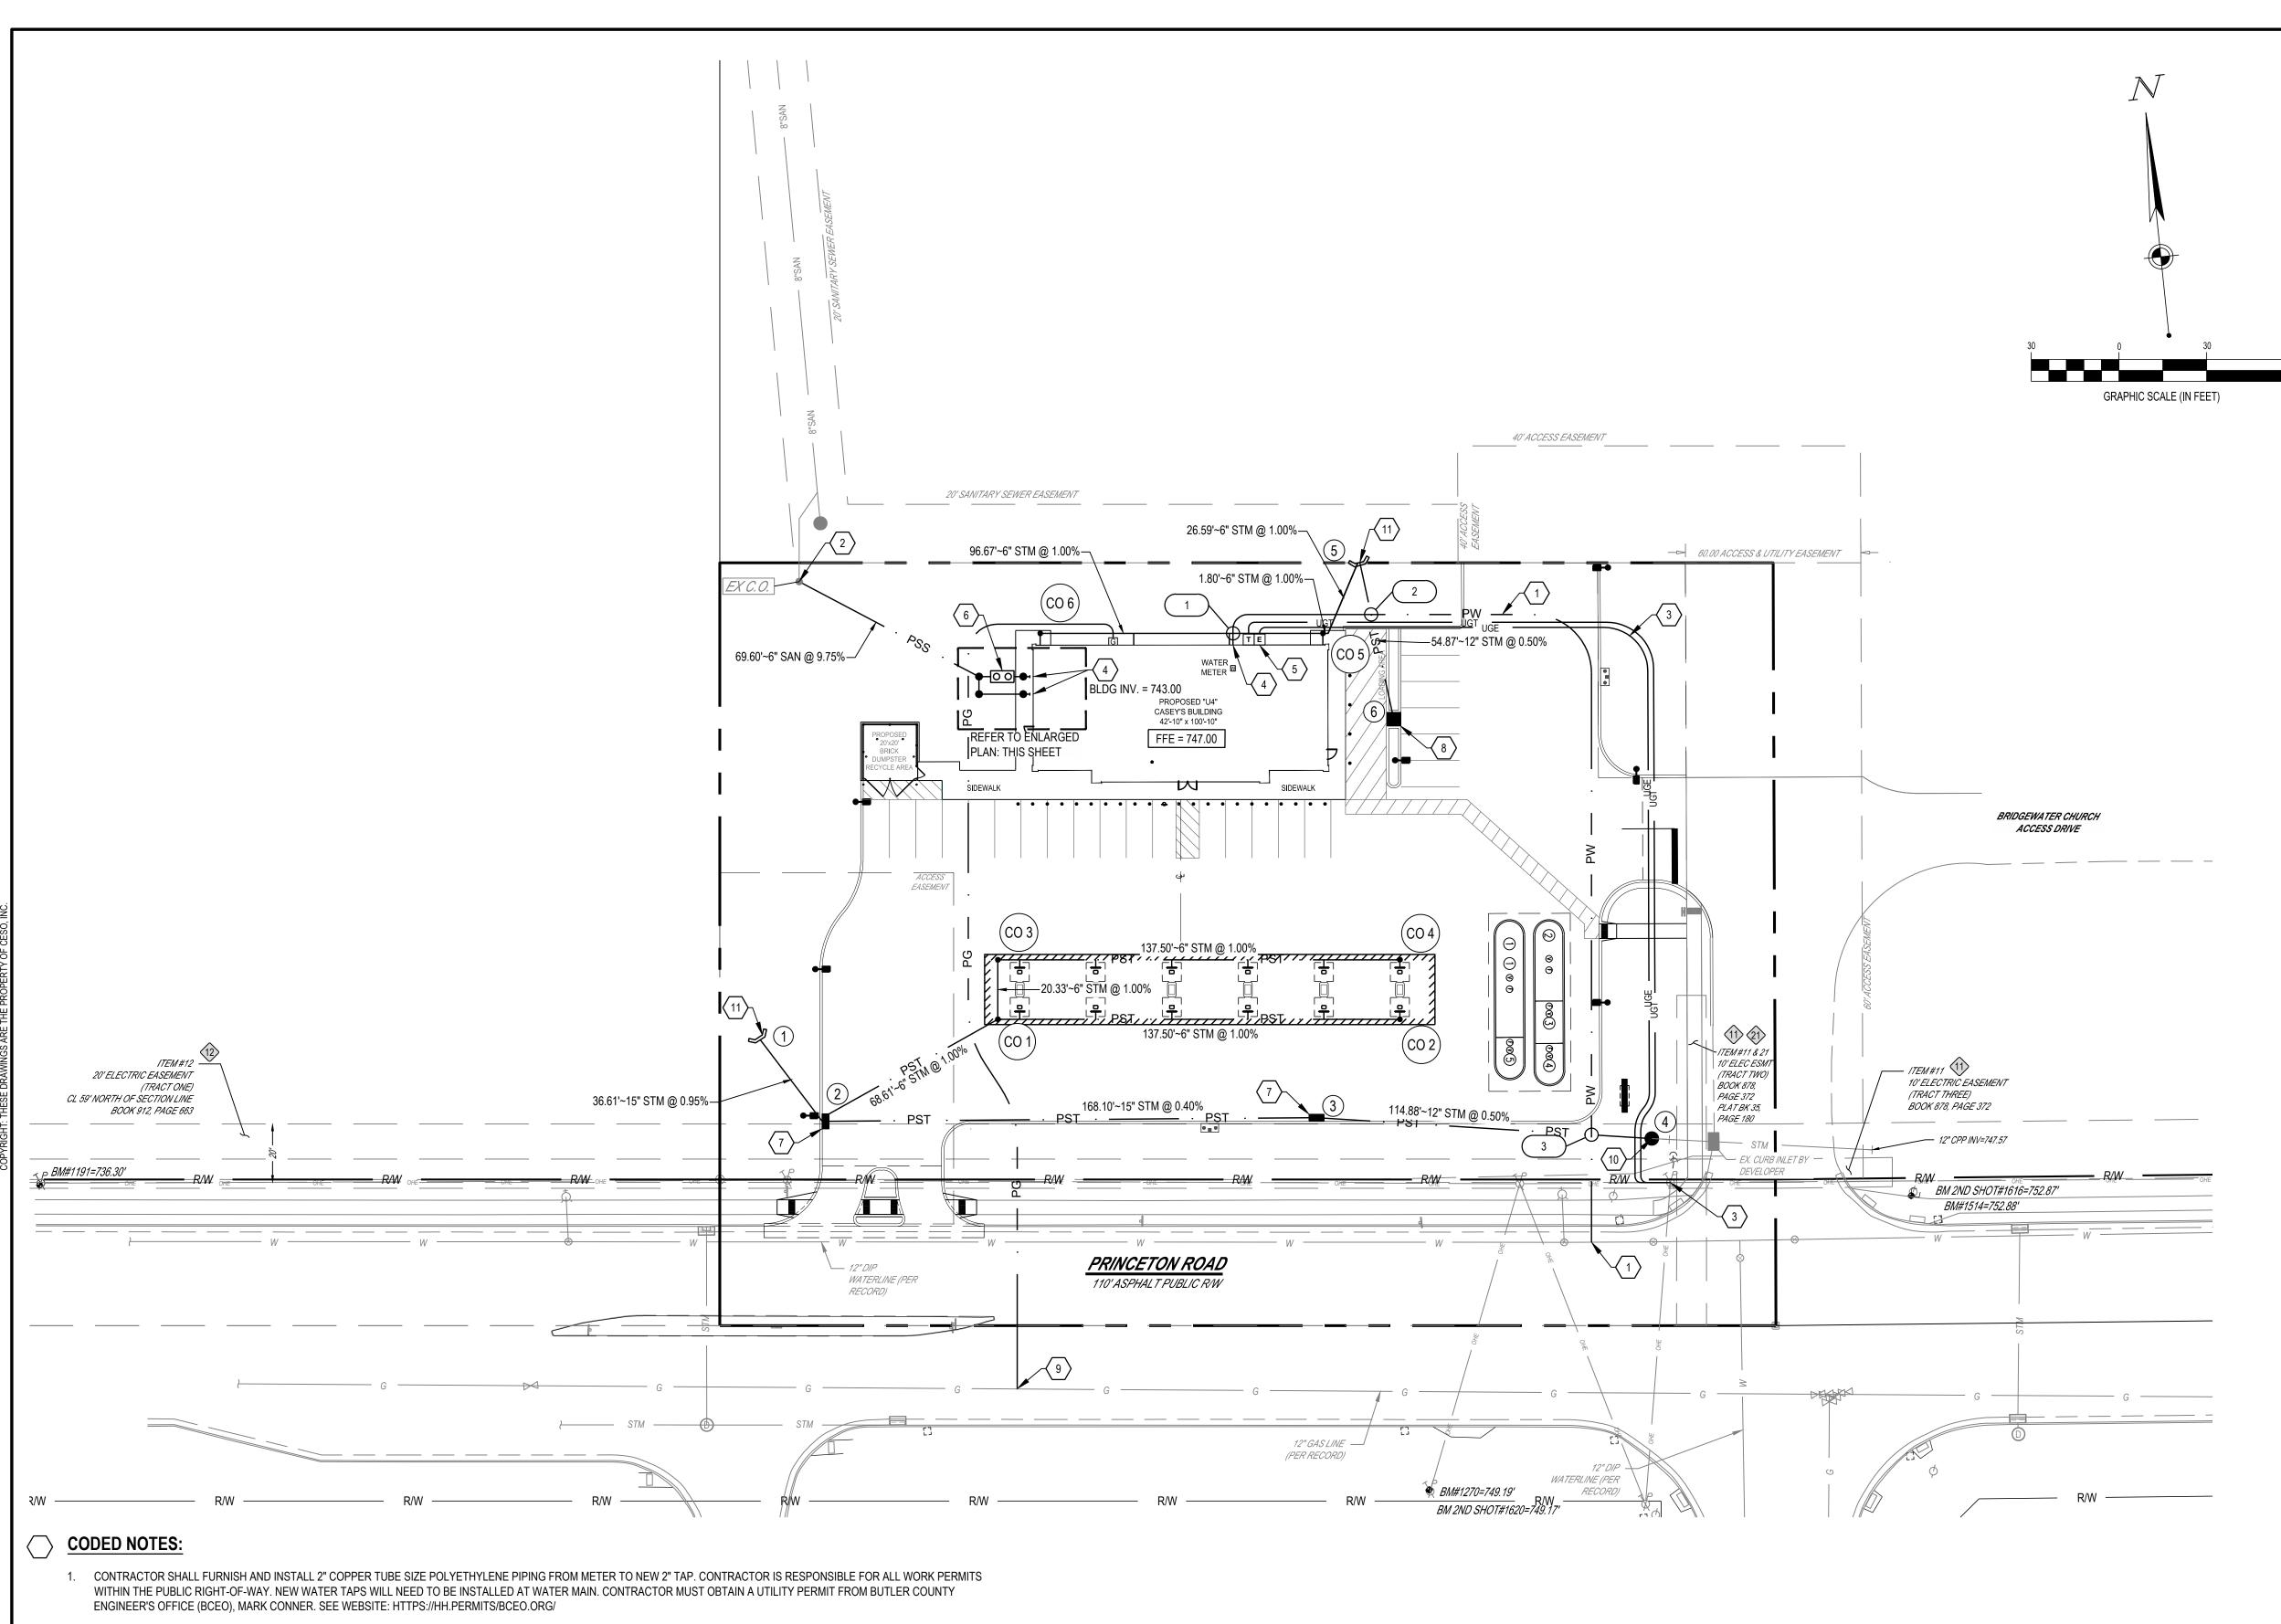LEGEND

	BUILDING
7//////////////////////////////////////	CANOPY
· PST ·	STORM SEWER
· PSS ·	SANITARY SEWER
· PW ·	DOMESTIC WATER SERVICE
—— PG — · —	GAS SERVICE
UGE	UNDERGROUND ELEC. LINE
UGT	UNDERGROUND TEL. LINE
•	CLEAN OUT
G	GAS METER
oxdots	WATER METER
TE	ELECTRICAL SERVICE ENTRANCE
00	GREASE INTERCEPTOR
	MANHOLE
	CURB INLET
	CATCH BASIN

HEADWALL

SA	NITARY SEWER STRUCTURE	SCHE	DULE
NO.	STRUCTURE	RIM	INVERT
EX C.O.	6" CO	741.15	738.58 (6") SE 729.94 (6") NW
А	6" CO	746.26	742.54 (6") E 742.51 (6") S 738.29 (6") NW
В	GREASE INTERCEPTOR	746.31	742.87 (6") E 742.62 (6") W
С	6" CO	746.91	742.93 (6") E 742.93 (6") W
D	6" CO	746.42	742.63 (6") E 742.63 (6") N
E	6" CO	746.93	742.93 (6") E 742.93 (6") W

STORMS	SEWER STRUCT	TURE SC	HEDULE
NO.	STRUCTURE	GRATE	INVERT
CO 1	6" CLEAN OUT	739.86	739.28(6") E 739.28 (6") N 739.28 (6") SW
CO 2	6" CLEAN OUT	741.22	740.66 (6") W
CO 3	6" CLEAN OUT	740.06	739.49 (6") E 739.49 (6") S
CO 4	6" CLEAN OUT	741.43	740.86 (6") W
CO 5	6" CLEAN OUT	739.38	738.74 (6") W 738.74 (6") E
CO 6	6" CLEAN OUT	740.28	739.71 (6") E
1	ODOT HW 2.1	N/A	738.25 (15") SE
2	ODOT CB 3A	741.75	738.60 (15") E 738.60 (6") NE 738.60 (15") NW
3	ODOT CB 3A	744.50	739.27 (12") E 739.27 (15") W
4	ODOT MH 1.1	750.51	746.63 (12") E 739.84 (12") W
5	ODOT HW 2.1	N/A	738.46 (12") S
6	ODOT CB 2-2B	746.50	738.73 (12") N

- 2. CONNECT 6" SDR-35 PVC SANITARY SERVICE TO EXISTING SANITARY SEWER CLEANOUT PER BUTLER COUNTY STANDARDS. CONTRACTOR TO FIELD LOCATE AND VERIFY EXISTING SANITARY SEWER LINE. CONTRACTOR TO PROVIDE ALL NECESSARY FITTINGS FOR FINAL CONNECTION. CONTRACTOR SHALL VERIFY LOCATION AND DEPTH OF EXISTING UTILITIES.
- 3. CONTRACTOR SHALL COORDINATE WITH ELECTRICAL CONTRACTOR AND THE LOCAL UTILITY COMPANY TO INSTALL PRIMARY RISER AS REQUIRED TO PROVIDE ELECTRICAL SERVICE TO THE PROPOSED BUILDING. CONTRACTOR TO COORDINATE WITH ELECTRICAL CONTRACTOR AND THE LOCAL UTILITY COMPANY TO INSTALL NEW POLE MOUNTED TRANSFORMER.
- 4. COORDINATE UTILITIES WITH PLUMBING CONTRACTOR, CAP AND MARK FOR FUTURE CONNECTION. FINAL CONNECTION BY PLUMBING CONTRACTOR.
- 5. ELECTRICAL SERVICE ENTRANCE. ELECTRIC 3-PHASE 800 AMP, ¹²⁰/₂₀₈ VOLTS, 4-WIRE. 20 PAIR, 8 LINES. COORDINATE WITH ELECTRICAL CONTRACTOR FOR CONNECTION LOCATION OF ELECTRICAL SERVICE.
- 6. SUPPLY AND INSTALL (1) 1000 GAL. BELOW GRADE GREASE INTERCEPTOR. SEE DETAILS ON SHEET C-604.
- 7. SUPPLY AND INSTALL (2) ODOT 3A STANDARD CATCH BASIN.
- 8. SUPPLY AND INSTALL (1) ODOT 2-2B STANDARD CATCH BASIN.
- 9. CONNECTION TO GAS MAIN. DUKE ENERGY SHALL FURNISH AND INSTALL GAS LINE FROM METER TO NEW TAP. THE CONTRACTOR SHALL INSTALL THE GAS LINE FROM THE METER TO THE BUILDING SERVICE PER THE BUILDING DRAWINGS. CONTRACTOR MUST OBTAIN A UTILITY PERMIT FROM BUTLER COUNTY ENGINEER'S OFFICE (BCEO), MARK CONNER. SEE WEBSITE: HTTPS://HH.PERMITS/BCEO.ORG/
- 10. SUPPLY AND INSTALL (1) ODOT 1.1 STANDARD MANHOLE. CONTRACTOR TO CONNECT EXISTING CULVERT EXTENSION PIPE TO PROPOSED MANHOLE FOR TIE-IN.
- 11. SUPPLY AND INSTALL (2) ODOT 2.1 STANDARD HALF-HEIGHT HEADWALL.

	X UTILITY CRC	SSING SCHEDULE	
NO.	UTILITY	ELEVATIONS	DIFF.
1	2" WTR	B/PIPE = 741.05	1.5'
6" STM T	T/PIPE = 739.55	1.5	
2	2" WTR	B/PIPE = 741.05	4.51
2	12" STM	T/PIPE = 739.55	1.5'
2	2" WTR	B/PIPE = 741.24	4.51
3	12" STM	T/PIPE = 739.74	1.5'

_4.00'~6" SAN @ 2.00%
3.41'~6" SAN @ 2.00%
6.00'~6" SAN @ 2.00%
PSS · E
—15.14'~6" SAN @ 2.00%
ENLARGED PLAN: SANITARY SEWER SERVICE
SCALE: 1" = 10'


		BENCHMARK
	ELEVATION*	DESCRIPTION
BM #1191	736.30	BENCH NAIL SET SOUTH SIDE OF POWER POLE #JH-0009. NORTH SIDE OF PRINCETON ROAD, SOUTH OF WALDEN PONDS COMMUNITY CHURCH BUILDING.
BM #1270	749.19	BENCHNAIL SET NORTH SIDE OF POWER POLE #J12-0013 SOUTHWEST OF GILMORE ROAD AND PRINCETON ROAD INTERSECTION, NORTH OF POPEYE'S CHICKEN.
BM #1514	752.88	CHISELED BOX SOUTHWEST CORNER OF TRAFFIC SIGNAL LIGHT POLE BASE. LOCATED ON NORTHEAST CORNER OF PRINCETON ROAD AND GILMORE ROAD INTERSECTION.

NOTE: REFER TO ALTA SURVEY, SHEET C-003, FOR BENCHMARK LOCATIONS.


* VERTICAL DATUM: NAVD88



CESO WWW.CESOINC.COM

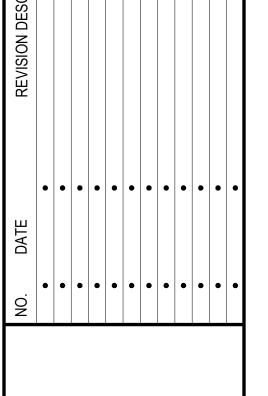



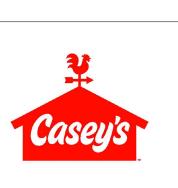

HAMILTON, OH

UTILITY PLAN

ISSUE:
CIVIL PERMIT SET

DATE:
05.19.2021


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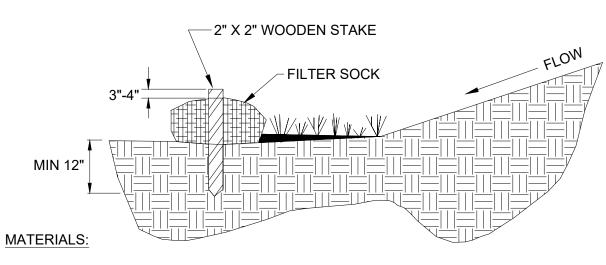
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NOTE: REFER TO ALTA SURVEY, SHEET C-003, FOR BENCHMARK LOCATIONS.

TEMPORARY SILT FENCE DETAILS

NOT TO SCALE



- 1. COMPOST USED FOR FILTER SOCKS SHALL BE WEED, PATHOGEN AND INSECT FREE AND FREE OF ANY REFUSE, CONTAMINANTS OR OTHER MATERIALS TOXIC TO PLANT GROWTH. THEY SHALL BE DERIVED FROM A WELL-DECOMPOSED SOURCE OF ORGANIC MATTER AND CONSIST OF A PARTICLES RANGING FROM 3/8" TO 2".
- 2. FILTER SOCKS SHALL BE 3 OR 5 MIL CONTINUOUS, TUBULAR, HDPE 3/8" KNITTED MESH NETTING MATERIAL, FILLED WITH COMPOST PASSING THE ABOVE SPECIFICATIONS FOR COMPOST PRODUCTS.

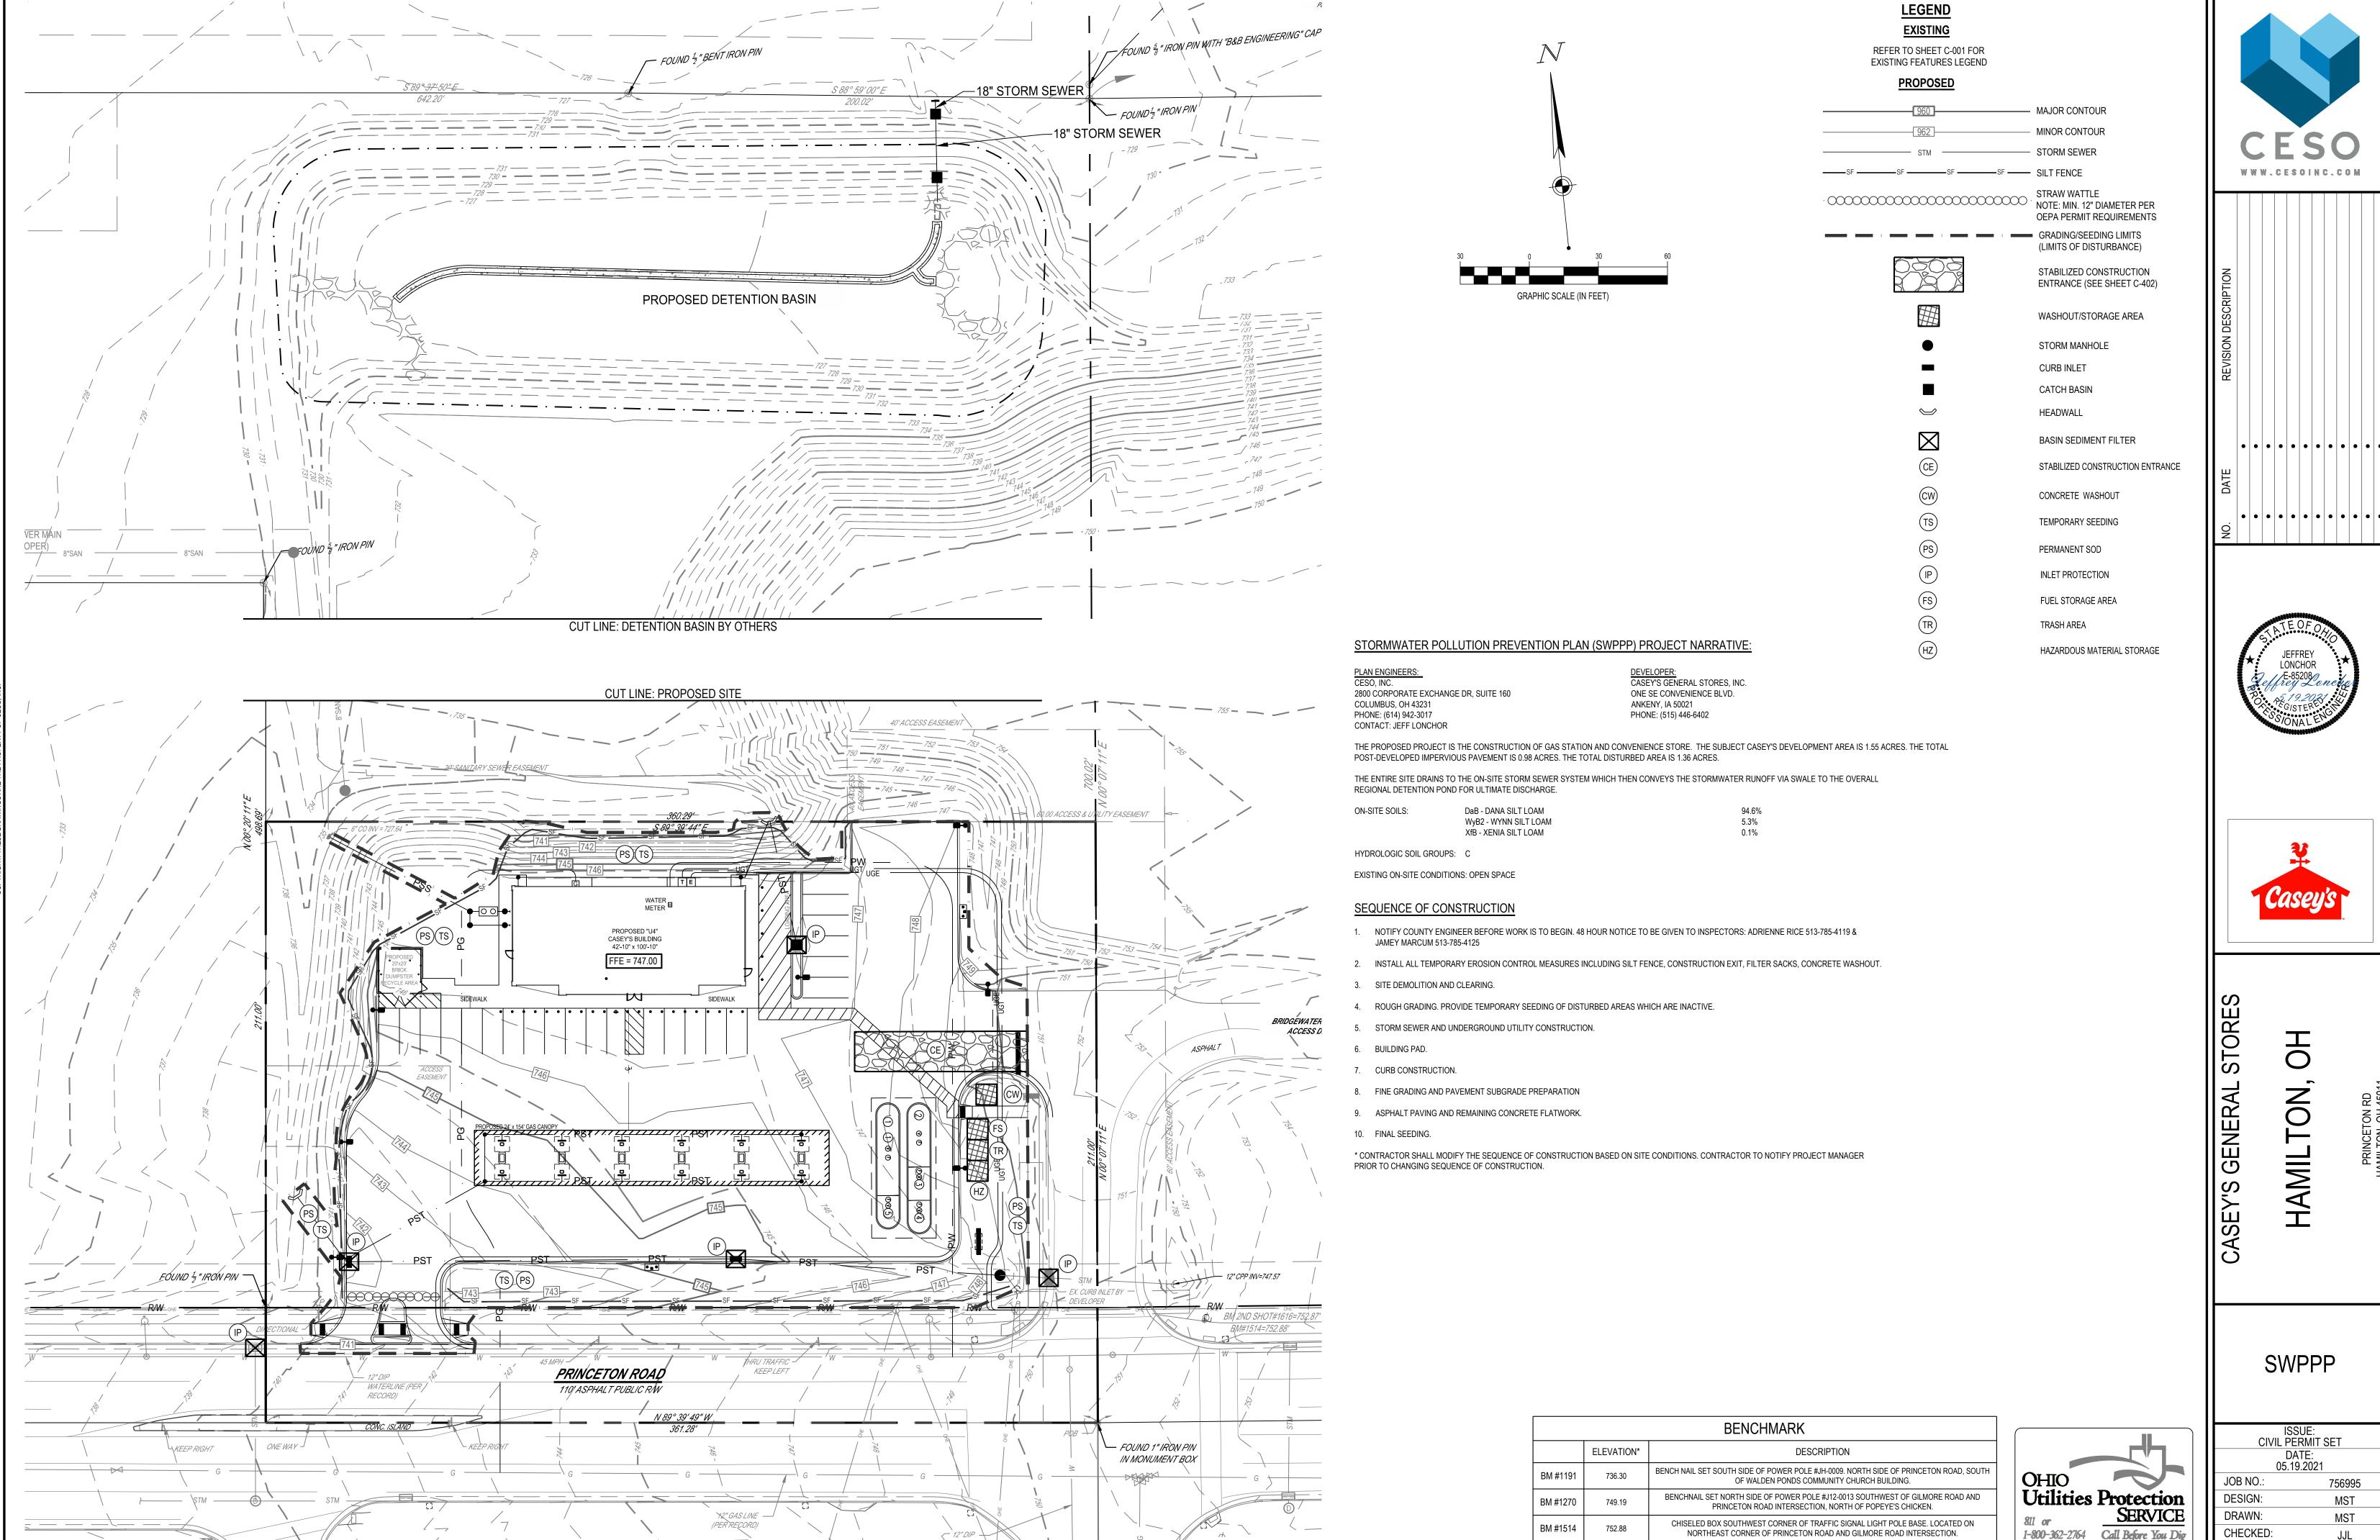INSTALLATION:

- 1. FILTER SOCKS WILL BE PLACED ON A LEVEL LINE ACROSS SLOPES, GENERALLY PARALLEL TO THE BASE OF THE SLOPE OR OTHER AFFECTED AREA. ON SLOPES APPROACHING 2:1, ADDITIONAL SOCKS SHALL BE PROVIDED AT THE TOP AND AS NEEDED MIDSLOPE.
- 2. FILTER SOCKS INTENDED TO BE LEFT AS A PERMANENT FILTER OR PART OF THE NATURAL LANDSCAPE, SHALL BE SEEDED AT THE TIME OF INSTALLATION FOR ESTABLISHMENT OF PERMANENT VEGETATION.
- 3. FILTER SOCKS ARE NOT TO BE USED IN CONCENTRATED FLOW SITUATIONS OR IN RUNOFF CHANNELS.

- 1. ROUTINELY INSPECT FILTER SOCKS AFTER EACH SIGNIFICANT RAIN, MAINTAINING FILTER SOCKS IN A FUNCTIONAL CONDITION AT ALL TIMES.
- 2. REMOVE SEDIMENTS COLLECTED AT THE BASE OF THE FILTER SOCKS WHEN THEY REACH 1/3 OF THE EXPOSED HEIGHT OF THE PRACTICE.
- 3. WHERE THE FILTER SOCK DETERIORATES OR FAILS, IT WILL BE REPAIRED OR REPLACED WITH A MORE EFFECTIVE ALTERNATIVE.
- 4. REMOVAL FILTER SOCKS WILL BE DISPERSED ON SITE WHEN NO LONGER REQUIRED IN
- SUCH AS WAY AS TO FACILITATE AND NOT OBSTRUCT SEEDINGS.

FILTER SOCK DETAIL

SILT FENCE NOTES:


- FILTER FABRIC SHALL BE A MINIMUM OF 32" IN WIDTH AND SHALL HAVE A MINIMUM OF 6 LINE WIRES WITH 12" STAY SPACING.
- FILTER FABRIC SHALL BE MIRAFI 140 FABRIC OR EQUIVALENT. BURLAP CANNOT BE USED WHERE SILT FENCE IS TO REMAIN FOR A PERIOD OF MORE THAN 30 DAYS.

STEEL POST SHALL BE 5'-0" IN HEIGHT AND BE OF THE SELF-FASTENER ANGLE STEEL

WOOD POSTS SHALL BE 6'-0" TO 7'-0" IN HEIGHT AND 2" IN DIAMETER. WIRE FABRIC SHALL BE FASTENED TO WOODEN POST WITH NOT LESS THAN #9 WIRE STAPLES 1-1/2" LONG.

MAINTENANCE NOTES:


- FILTER BARRIERS SHALL BE INSPECTED IMMEDIATELY AFTER EACH RAINFALL AND AT LEAST DAILY DURING PROLONGED RAINFALL. ANY REQUIRED REPAIRS SHALL BE MADE IMMEDIATELY.
- IF THE FABRIC DECOMPOSES OR BECOMES INEFFECTIVE PRIOR TO THE END OF THE EXPECTED USABLE LIFE, AND THE BARRIER IS STILL REQUIRED, THE FABRIC SHALL BE REPLACED PROMPTLY.
- SEDIMENT DEPOSITS SHOULD BE REMOVED AFTER EACH STORM EVENT. THEY MUST BE REMOVED WHEN DEPOSITS REACH APPROXIMATELY HALF THE HEIGHT OF THE BARRIER.
- ANY SEDIMENT DEPOSITS REMAINING IN PLACE AFTER THE SILT FENCE OR FILTER BARRIER IS NO LONGER REQUIRED SHALL BE DRESSED TO CONFORM WITH THE EXISTING GRADE, PREPARED, AND SEEDED.

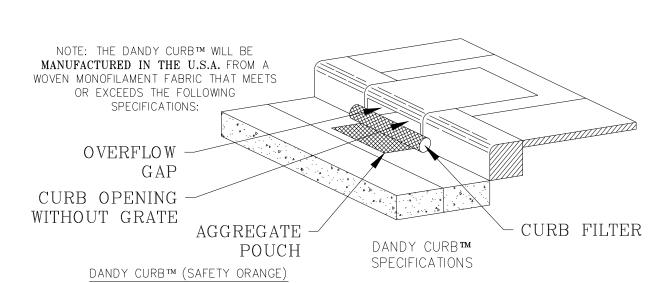

Mechanical Properties	Test Method	Units	MARV
Grab Tensile Strength	ASTM D 4632	kN (lbs)	1.62 (365) X 0.89 (200)
Grab Tensile Elongation	ASTM D 4632	%	24 X 10
Puncture Strength	ASTM D 4833	kN (lbs)	0.40 (90)
Mullen Burst Strength	ASTM D 3786	kPa (psi)	3097 (450)
Trapezoid Tear Strength	ASTM D 4533	kN (lbs)	0.51 (115) X 0.33 (75)
UV Resistence	ASTM D 4355	%	90
Apparent Opening Size	ASTM D 4751	Mm (US Std Sieve)	0.425 (40)
Flow Rate	ASTM D 4491	1/min/m² (gal/min/ft²)	5907 (145)
Permittivity	ASTM D 4491	Sec ⁻¹	2.1

*Note: All Dandy Curbs™ can be ordered with our optional oil absorbents

DANDY CURB DETAIL

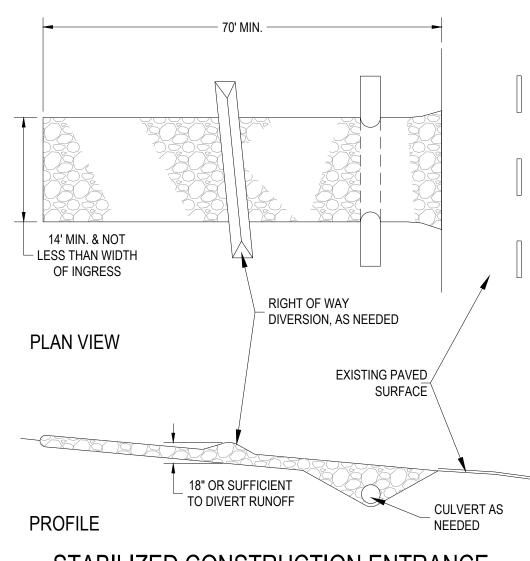

STABILIZED CONSTRUCTION ENTRANCE

- 1. AGGREGATE SIZE ODOT COARSE AGGREGATE GRADATIONS: CA-1, CA-2. CA-2 IS PREFERRED BY BUTLER COUNTY.
- 2. LENGTH THE CONSTRUCTION ENTRANCE SHALL BE AS LONG AS REQUIRED TO STABILIZE HIGH TRAFFIC AREAS BUT NOT LESS THAN 70 FT. (EXCEPTION: APPLY 30 FT. MINIMUM TO SINGLE RESIDENCE LOTS.
- 3. THICKNESS THE STONE LAYER SHALL BE AT LEAST 6 INCHES.
- 4. WIDTH THE ENTRANCE SHALL BE AT LEAST 14 FEET WIDE, BUT NOT LESS THAN THE FULL WIDTH AT POINTS WHERE INGRESS OR EGRESS OCCURS.
- 5. FILTER FABRIC FILTER FABRIC SHALL BE USED UNDER THE AGGREGATE TO MINIMIZE THE MIGRATION OF STONE INTO THE UNDERLYING SOIL BY HEAVY VEHICLE LOADS. THE FILTER FABRIC SHALL MEET THE REQUIREMENTS OF MATERIALS SPECIFICATION 592 GEOTEXTILE TABLE 1 OR 2, CLASS I, II, OR IV.
- 6. TIMING THE CONSTRUCTION ENTRANCE SHALL BE INSTALLED AS SOON AS IS PRACTICAL BEFORE MAJOR GRADING ACTIVITIES.
- 7. SURFACE WATER ALL SURFACE WATER FLOWING OR DIVERTED TOWARD CONSTRUCTION ENTRANCES SHALL BE PIPED ACROSS THE ENTRANCE. IF PIPING IS IMPRACTICAL, A MOUNTABLE BERM WITH 5:1 SLOPES WILL BE

── WOOD FRAME SECURELY FASTENED AROUND ENTIRE

"ABOVE GRADE" w/

WOOD PLANKS

PERMITTED.

- 8. WASHING IF CONDITIONS ON THE SITE ARE SUCH THAT THE VEHICLES TRAVELING OVER THE GRAVEL DO NOT REMOVE THE MAJORITY OF THE MUD, THEN THE TIRES OF THE VEHICLES MUST BE WASHED BEFORE ENTERING A PUBLIC ROAD. WASH WATER MUST BE CARRIED AWAY FROM THE ENTRANCE TO A SEDIMENT TRAPPING FACILITY SUCH AS PRACTICE STANDARDS "IMPOUNDMENT STRUCTURE-ROUTED 842 OR TEMPORARY SEDIMENT TRAP 960". ALL SEDIMENT SHALL BE PREVENTED FROM ENTERING STORM DRAINS, DITCHES, WATERCOURSES, OR SURFACE WATERS INCLUDING WETLANDS. A WASH RACK MAY BE USED TO MAKE WASHING MORE CONVENIENT AND EFFECTIVE.
- 9. LOCATION THE WASHING STATION SHOULD BE LOCATED TO PROVIDE FOR MAXIMUM UTILITY BY ALL CONSTRUCTION VEHICLES.
- 10. TIMING THE GRAVELED ACCESS SHALL BE INSTALLED AS SOON AS PRACTICAL AFTER THE START OF SITE DISTURBANCE.
- 11. REMOVAL THE ENTRANCE SHALL REMAIN IN PLACE AND BE MAINTAINED UNTIL THE DISTURBED AREA IS STABILIZED BY PERMANENT BEST MANAGEMENT PRACTICES.
- 12. MAINTENANCE THE ENTRANCE SHALL BE MAINTAINED IN A CONDITION THAT WILL PREVENT TRACKING OF SEDIMENT ONTO PUBLIC RIGHT-OF-WAYS OR STREETS. THIS MAY REQUIRE PERIODIC TOP DRESSING WITH ADDITIONAL AGGREGATE. ALL SEDIMENT SPILLED, DROPPED, OR WASHED ONTO PUBLIC RIGHT-OF-WAYS MUST BE REMOVED IMMEDIATELY. PERIODIC INSPECTION AND NEEDED MAINTENANCE SHALL BE PROVIDED AFTER EACH RAIN.





LONCHOR

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SWPPP DETAILS

CIVIL PERMIT SET 05.19.2021 JOB NO. DESIGN: DRAWN: MST CHECKED: SHEET NO.

PERIMETER WITH TWO WOOD BINDING WIRE (2 PER BALE) 10 mil PLASTIC LINING — (OPTIONAL) STRAW BALE (TYP.) WOOD OR METAL -PLASTIC LINING STAKES (2 PER BALE) PLYWOOD PAINTI - 10 mil PLASTIC LINING WHITE (1200mm x SECTION "A-A" SECTION "A-A" SECTION "A-A" BLACK LETTERS CONCRETE (150mm HEIGHT) WASHOUT -LAG SCREWS LATH AND -(12.5mm) FLAGGING ON 3 SIDES (89mm x 89mm x **CONCRETE WASHOUT** SIGN DETAIL **VARIES** 10 mil PLASTIC LINING VARIES PLASTIC LINING PLASTIC LINING 3.05mm DIA. - STAKE (TYP.) STAPLE DETAIL - TWO STACKED 2x12 ROUGH WOOD STRAW BALE (TYP.) SANDBAG (TYP.) -FRAME

1. ACTUAL LAYOUT DETERMINED IN THE FIELD.

FACILITY.

2. THE CONCRETE WASHOUT SIGN SHALL BE INSTALLED

WITHIN 10 m OF THE TEMPORARY CONCRETE WASHOUT

PLAN VIEW

1. INLET PROTECTION SHALL BE CONSTRUCTED EITHER BEFORE UPSLOPE LAND DISTURBANCE BEGINS OR BEFORE THE INLET BECOMES FUNCTIONAL.

2. THE EARTH AROUND THE INLET SHALL BE EXCAVATED COMPLETELY TO A DEPTH AT LEAST 18 INCHES. 3. THE WOODEN FRAME SHALL BE CONSTRUCTED OF 2-INCH BY 4-INCH CONSTRUCTION GRADE LUMBER. THE 2-INCH BY 4-INCH POSTS SHALL BE DRIVEN 18" INTO THE GROUND AT FOUR CORNERS OF THE INLET AND THE TOP PORTION OF

SECTION

NOTES:

2"x4" LUMBER -

- 2-INCH BY 4-INCH FRAME ASSEMBLED USING THE OVERLAP JOINT SHOWN. THE TOP OF THE FRAME SHALL BE AT LEAST 6 INCHES BELOW ADJACENT ROADS IF PONDED WATER WILL POSE A SAFETY HAZARD TO TRAFFIC. 4. WIRE MESH SHALL BE OF SUFFICIENT STRENGTH TO SUPPORT FABRIC WITH WATER FULLY IMPOUNDED AGAINST IT. IT SHALL BE STRETCHED TIGHTLY AROUND THE FRAME AND FASTENED SECURELY TO THE FRAME 5. GEOTEXTILE MATERIAL SHALL HAVE AN EQUIVALENT OPENING SIZE OF 20-40 SIEVE AND BE RESISTANT TO SUNLIGHT. IT
- THE FRAME TO 18 INCHES BELOW THE INLET NOTCH ELEVATION. THE GEOTEXTILE SHALL OVERLAP ACROSS ONE SIDE OF THE INLET SO THE ENDS OF THE CLOTH ARE NOT FASTENED TO THE SAME POST. 6. BACKFILL SHALL BE PLACED AROUND THE INLET IN COMPACTED 6 INCH LAYERS UNTIL THE EARTH IS EVEN WITH NOTCH

SHALL BE STRETCHED TIGHTLY AROUND THE FRAME AND FASTENED SECURELY. IT SHALL EXTEND FROM THE TOP OF

ELEVATION ON ENDS AND TOP ELEVATION ON SIDES. 7. A COMPACTED EARTH DIKE OR CHECK DAM SHALL BE CONSTRUCTED IN THE DITCH LINE BELOW THE INLET IF THE INLET IS NOT IN A DEPRESSION. THE TOP OF THE DIKE SHALL BE AT LEAST 6 INCHES HIGHER THAN THE TOP OF THE FRAME.

(P) AREA INLET PROTECTION

GEOTEXTILE OVER

COMPACT BACKFILL

AROUND INLET

WIRE MESH BACKING

"BELOW GRADE"

WITHIN 10m OF THE TEMPORARY CONCRETE WASHOUT

2. THE CONCRETE WASHOUT SIGN SHALL BE INSTALLED

1. ACTUAL LAYOUT DETERMINED IN THE FIELD.

NOTE:

CONCRETE WASHOUT DETAIL

W:\PROJECTS\CASEYS\756995-HAMILTON OH\03-CIVIL\PLAN\CONSTRUCTION\756995_C-401-SWPPP.DWG - 5/19/2021 12:15 F

LUM NO.	LABEL	MTG. HT.
1	A4	17
2	A4	17
3	A4	17
4	A4	17
5	A4	17
6	A4	17
7	A4	17
8	С	16.5
9	С	16.5
10	С	16.5
11	С	16.5
12	С	16.5
13	С	16.5
14	С	16.5
15	С	16.5
16	С	16.5
17	С	16.5
18	С	16.5
19	С	16.5
20	С	16.5
21	С	16.5
22	С	16.5
23	С	16.5
24	С	16.5
25	С	16.5
	С	16.5
26	С	
27	С	16.5
28	С	16.5
29	-	16.5
30	С	16.5
31	C	16.5
32	SE	10
33	SE	10
34	SE	10
35	SE	10
36	SE	10
37	W	10
38	W	10
39	W	10
40	W	10
41	W	10
42	W	10
43	W	10
44	W	10
45	W	10
46	W	10
47	W	10
48	W	10
49	W	10

LUMINAIRE LOCATION SUMMARY

FOOTCANDLE LEVELS CALCULATED AT GRADE USING INITIAL LUMEN VALUES										
LABEL	AVG	MAX	MIN	AVG/MIN	MAX/MIN					
PAVED AREA	4.86	21.4	0.7	6.94	30.57					
UNDEFINED AREA	0.90	23.6	0.0	N.A.	N.A.					
UNDER CANOPY	46.10	65	27	1.71	2.41					

NOTE: ALL AREA LIGHTS ON NEW 15 FT. POLES MOUNTED ON 2 FT. CONCRETE BASES

SYMBOL QTY LABEL ARRANGEMENT LUMENS LLF BUG RATING WATTS/LUMINAIRE TOTAL WATTS MANUFACTURER CATALOG LOGIC 7 A4 SINGLE 11259 1.040 B2-U0-G2 134 938 Cree Inc. ARE-EDG-4M-DA-06-E-UL-BZ-700 24 C SINGLE 13251 1.040 B3-U0-G1 134 3216 CREE, INC. CAN-304-SL-RS-06-E-UL-WH-700	LUMINAIRE	SCHEDULE									
24 C SINGLE 13251 1.040 B3-U0-G1 134 3216 CREE, INC. CAN-304-SL-RS-06-E-UL-WH-700	SYMBOL	QTY	LABEL	ARRANGEMENT	LUMENS	LLF	BUG RATING	WATTS/LUMINAIRE	TOTAL WATTS	MANUFACTURER	CATALOG LOGIC
	-	7	A4	SINGLE	11259	1.040	B2-U0-G2	134	938	Cree Inc.	ARE-EDG-4M-DA-06-E-UL-BZ-700
5 05 0NOL5 0000 4.040 PO 110 00 04 070 OPES INO OPES INO OPES INO OPES INO		24	С	SINGLE	13251	1.040	B3-U0-G1	134	3216	CREE, INC.	CAN-304-SL-RS-06-E-UL-WH-700
5 SE SINGLE 3902 1.040 B2-00-G0 34 170 CREE, INC. SF1-228-PS-RM-03-E-0L-BZ-350-IC		5	SE	SINGLE	3902	1.040	B2-U0-G0	34	170	CREE, INC.	SFT-228-PS-RM-03-E-UL-BZ-350-IC
14 W SINGLE 8739 1.040 B2-U0-G2 100 1400 CREE, INC. SEC-EDG-3M-WM-06-E-UL-BZ-525	þ.	14	W	SINGLE	8739	1.040	B2-U0-G2	100	1400	CREE, INC.	SEC-EDG-3M-WM-06-E-UL-BZ-525

R2 LMP 1/14/21 R3 BJM 3/12/21 1340 Kemper Meadow Dr, Forest Park, OH 45240 513-574-9500 | redleonard.com

DESCRIPTION REVISED LAYOUT PER NEW SITE PLAN REVISED PER UPDATED SITE PLAN REVISED LAYOUT PER NEW SITE PLAN

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DISCLAIMER

SCALE: LAYOUT BY: 1" = 30' BJM DWG SIZE: DATE: D 12/19/19

PROJECT NAME: CASEY'S HAMILTON, OH DRAWING NUMBER: RL-6515-S1-R3



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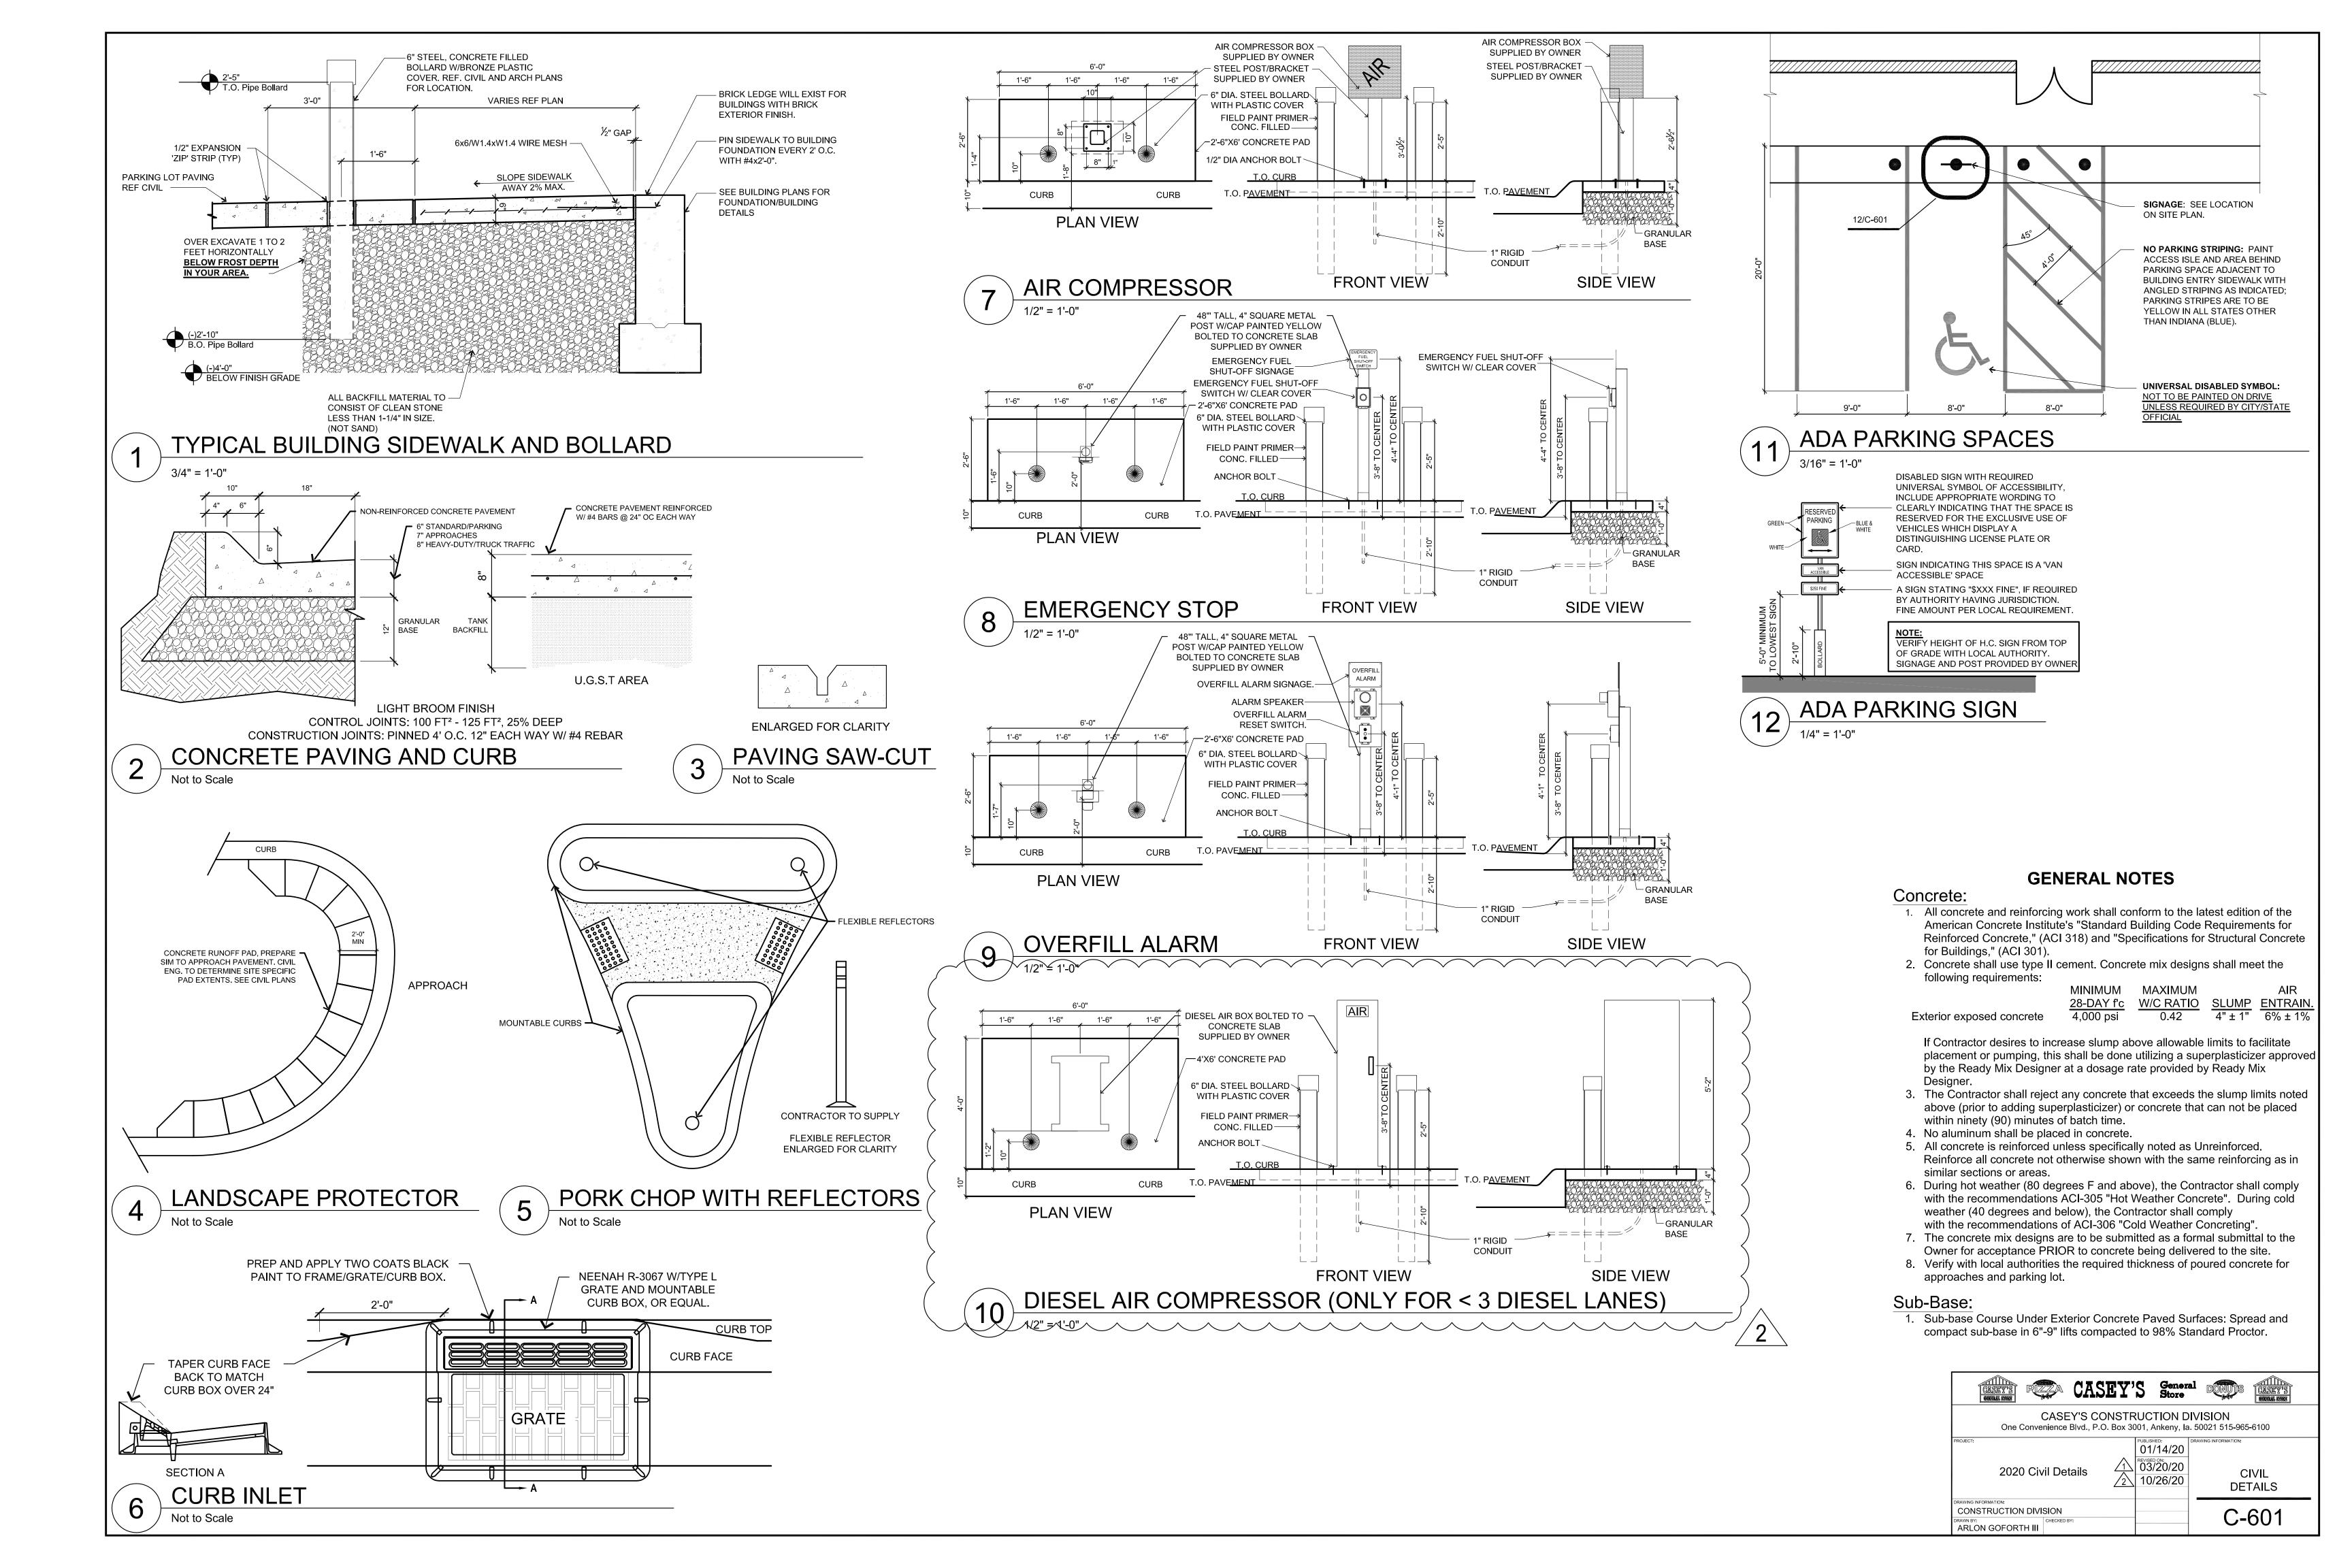






HAMILTON


PHOTOMETRIC


CIVIL PERMIT SET 05.19.2021 JOB NO.: DESIGN: DRAWN: MST CHECKED: SHEET NO.



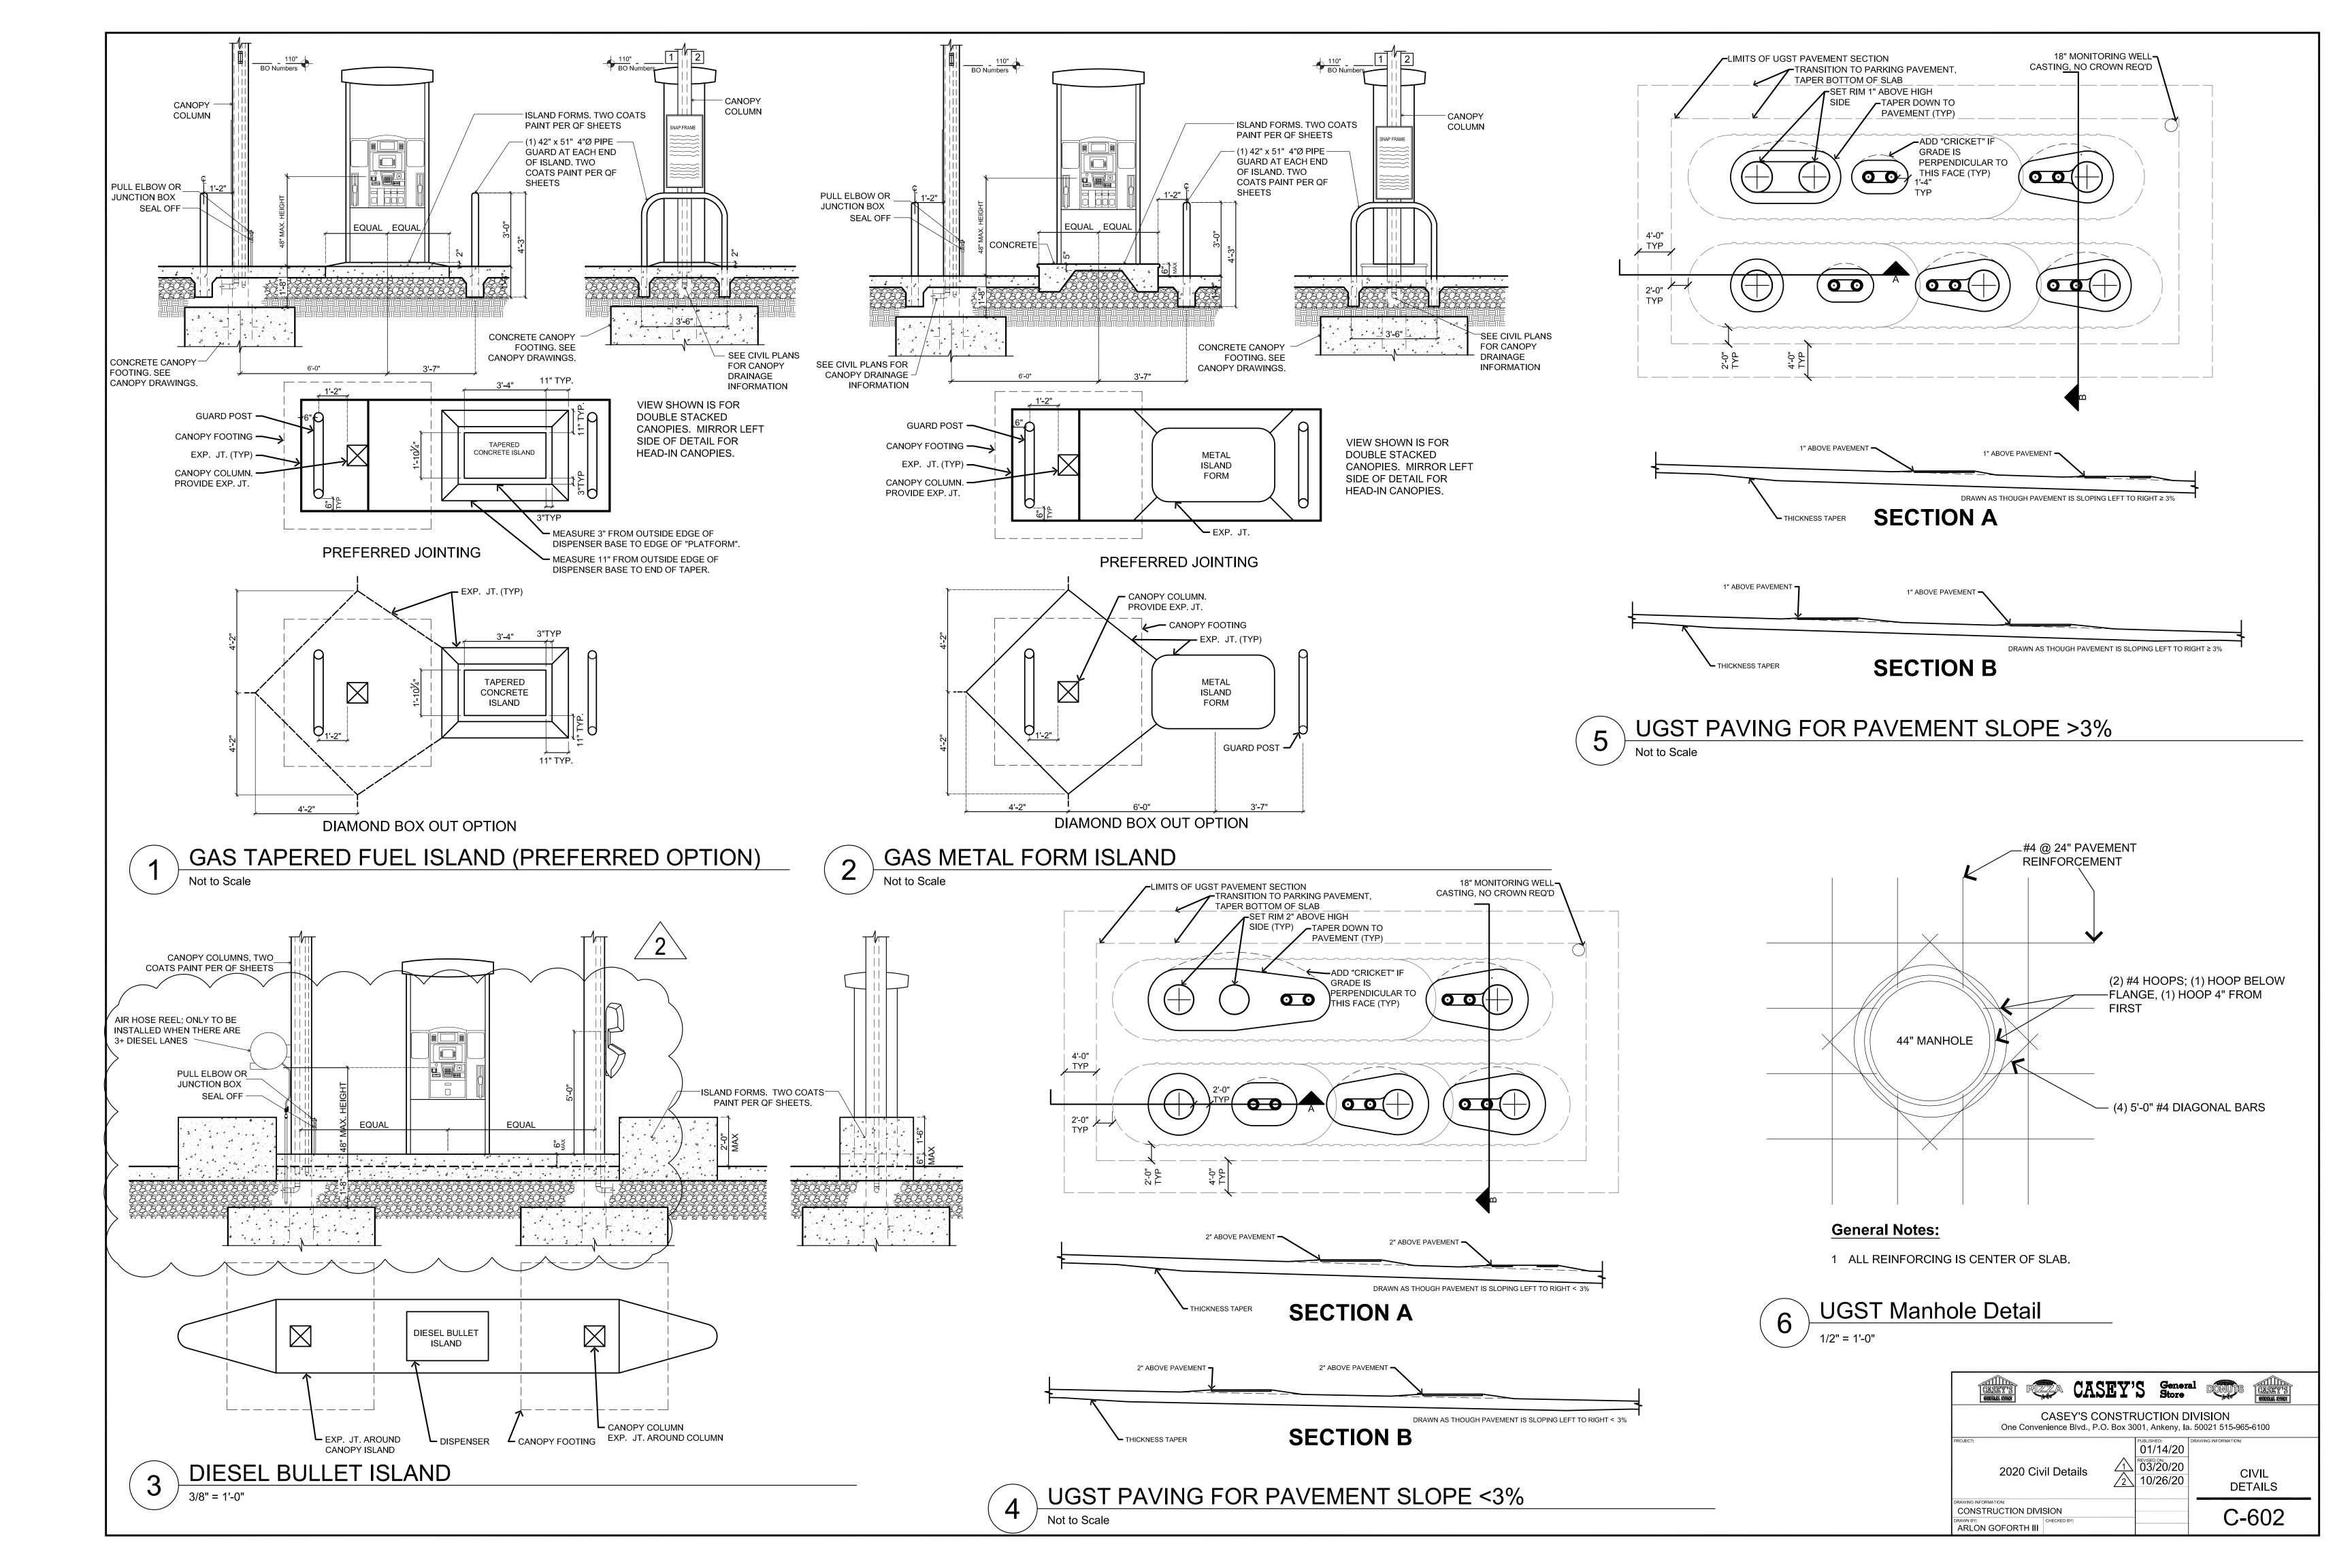

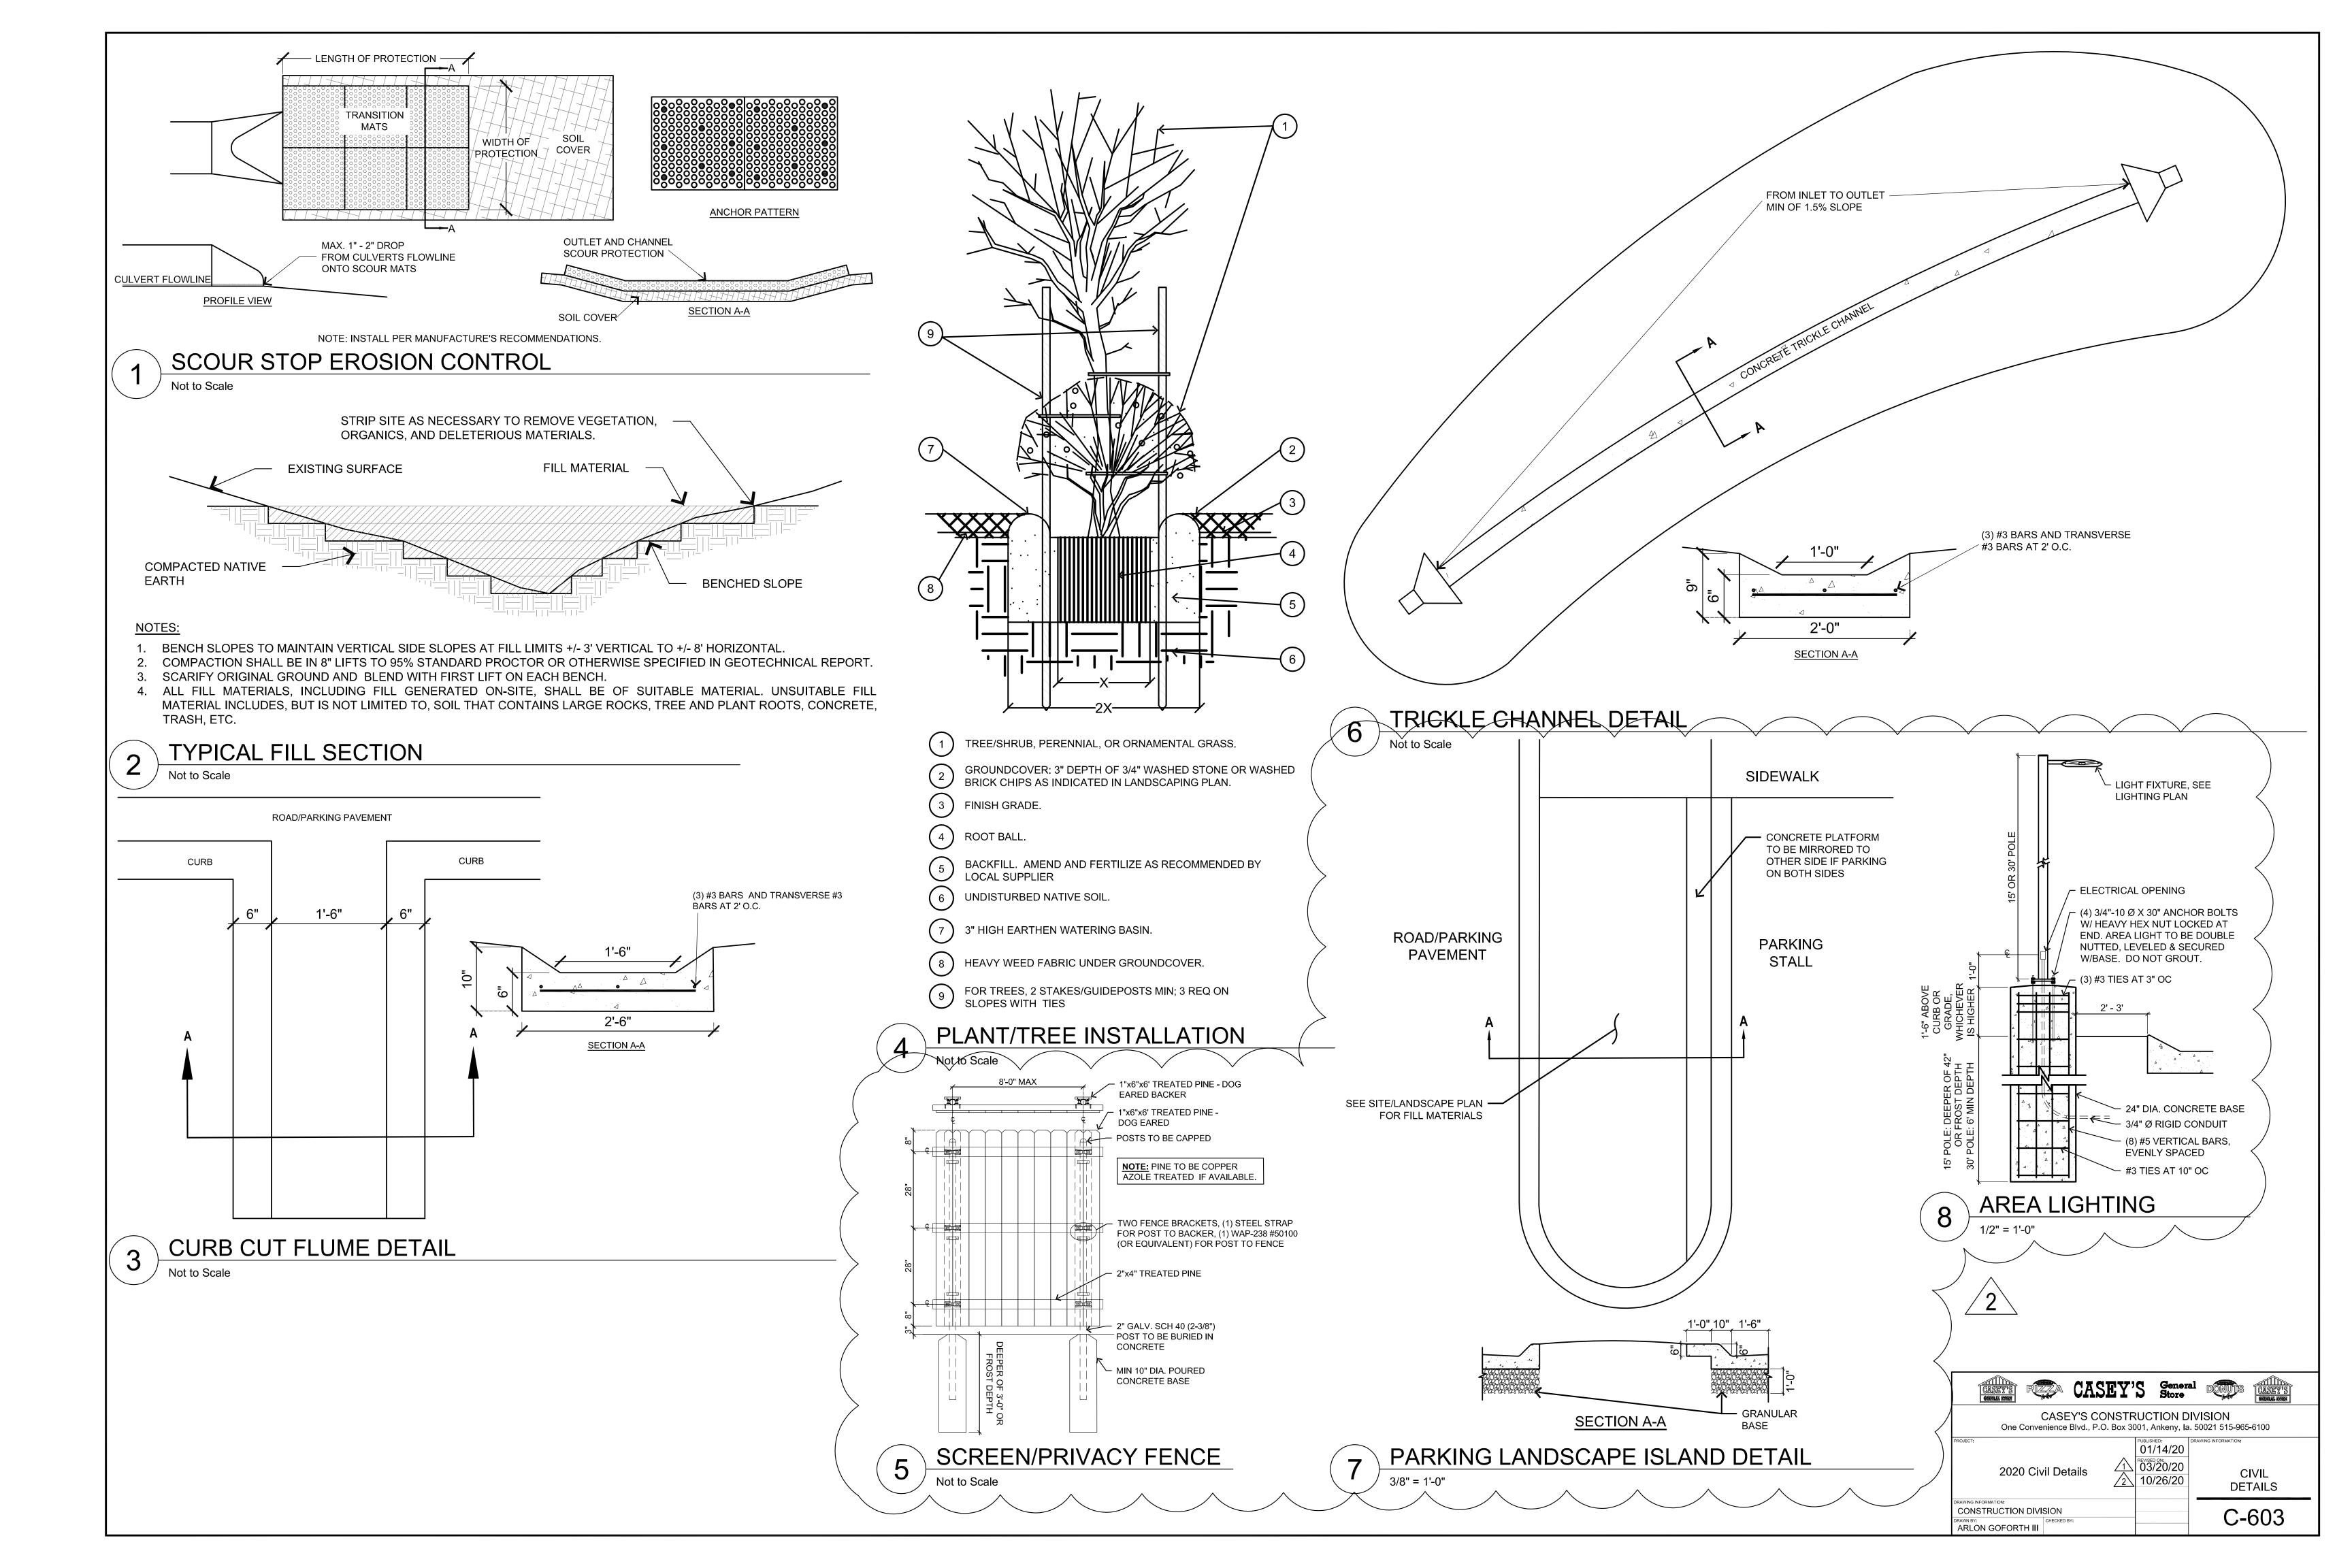

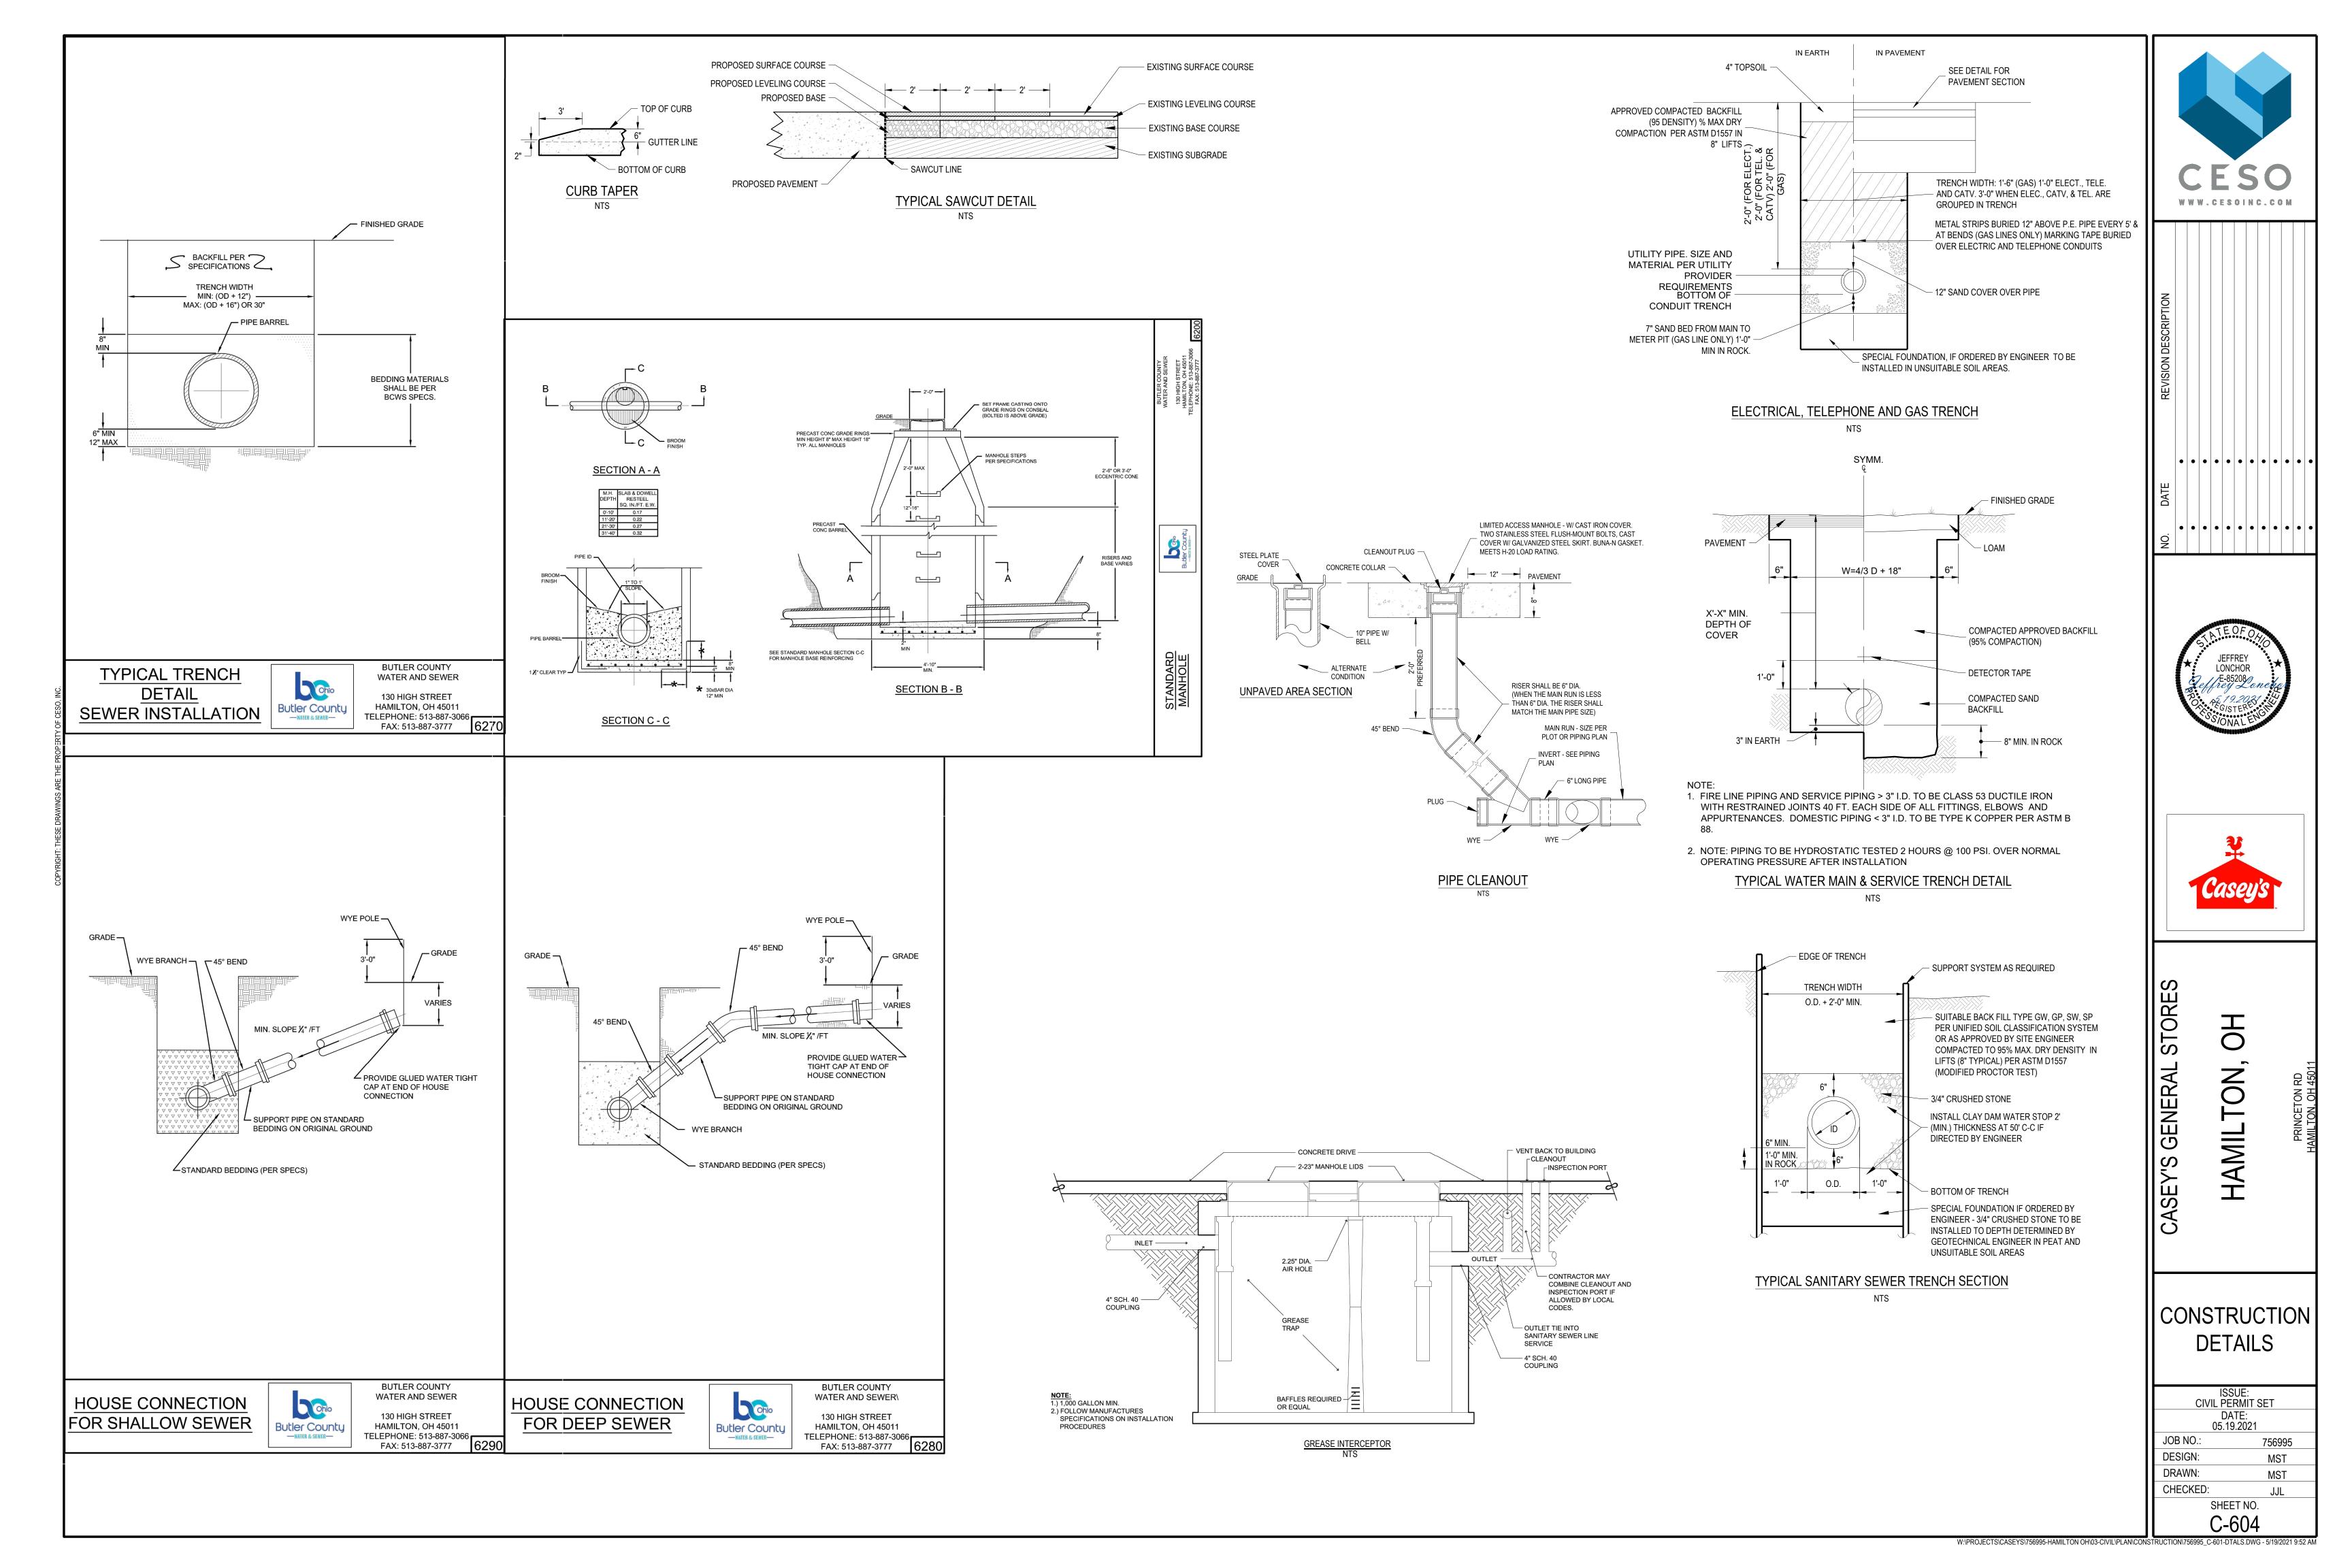

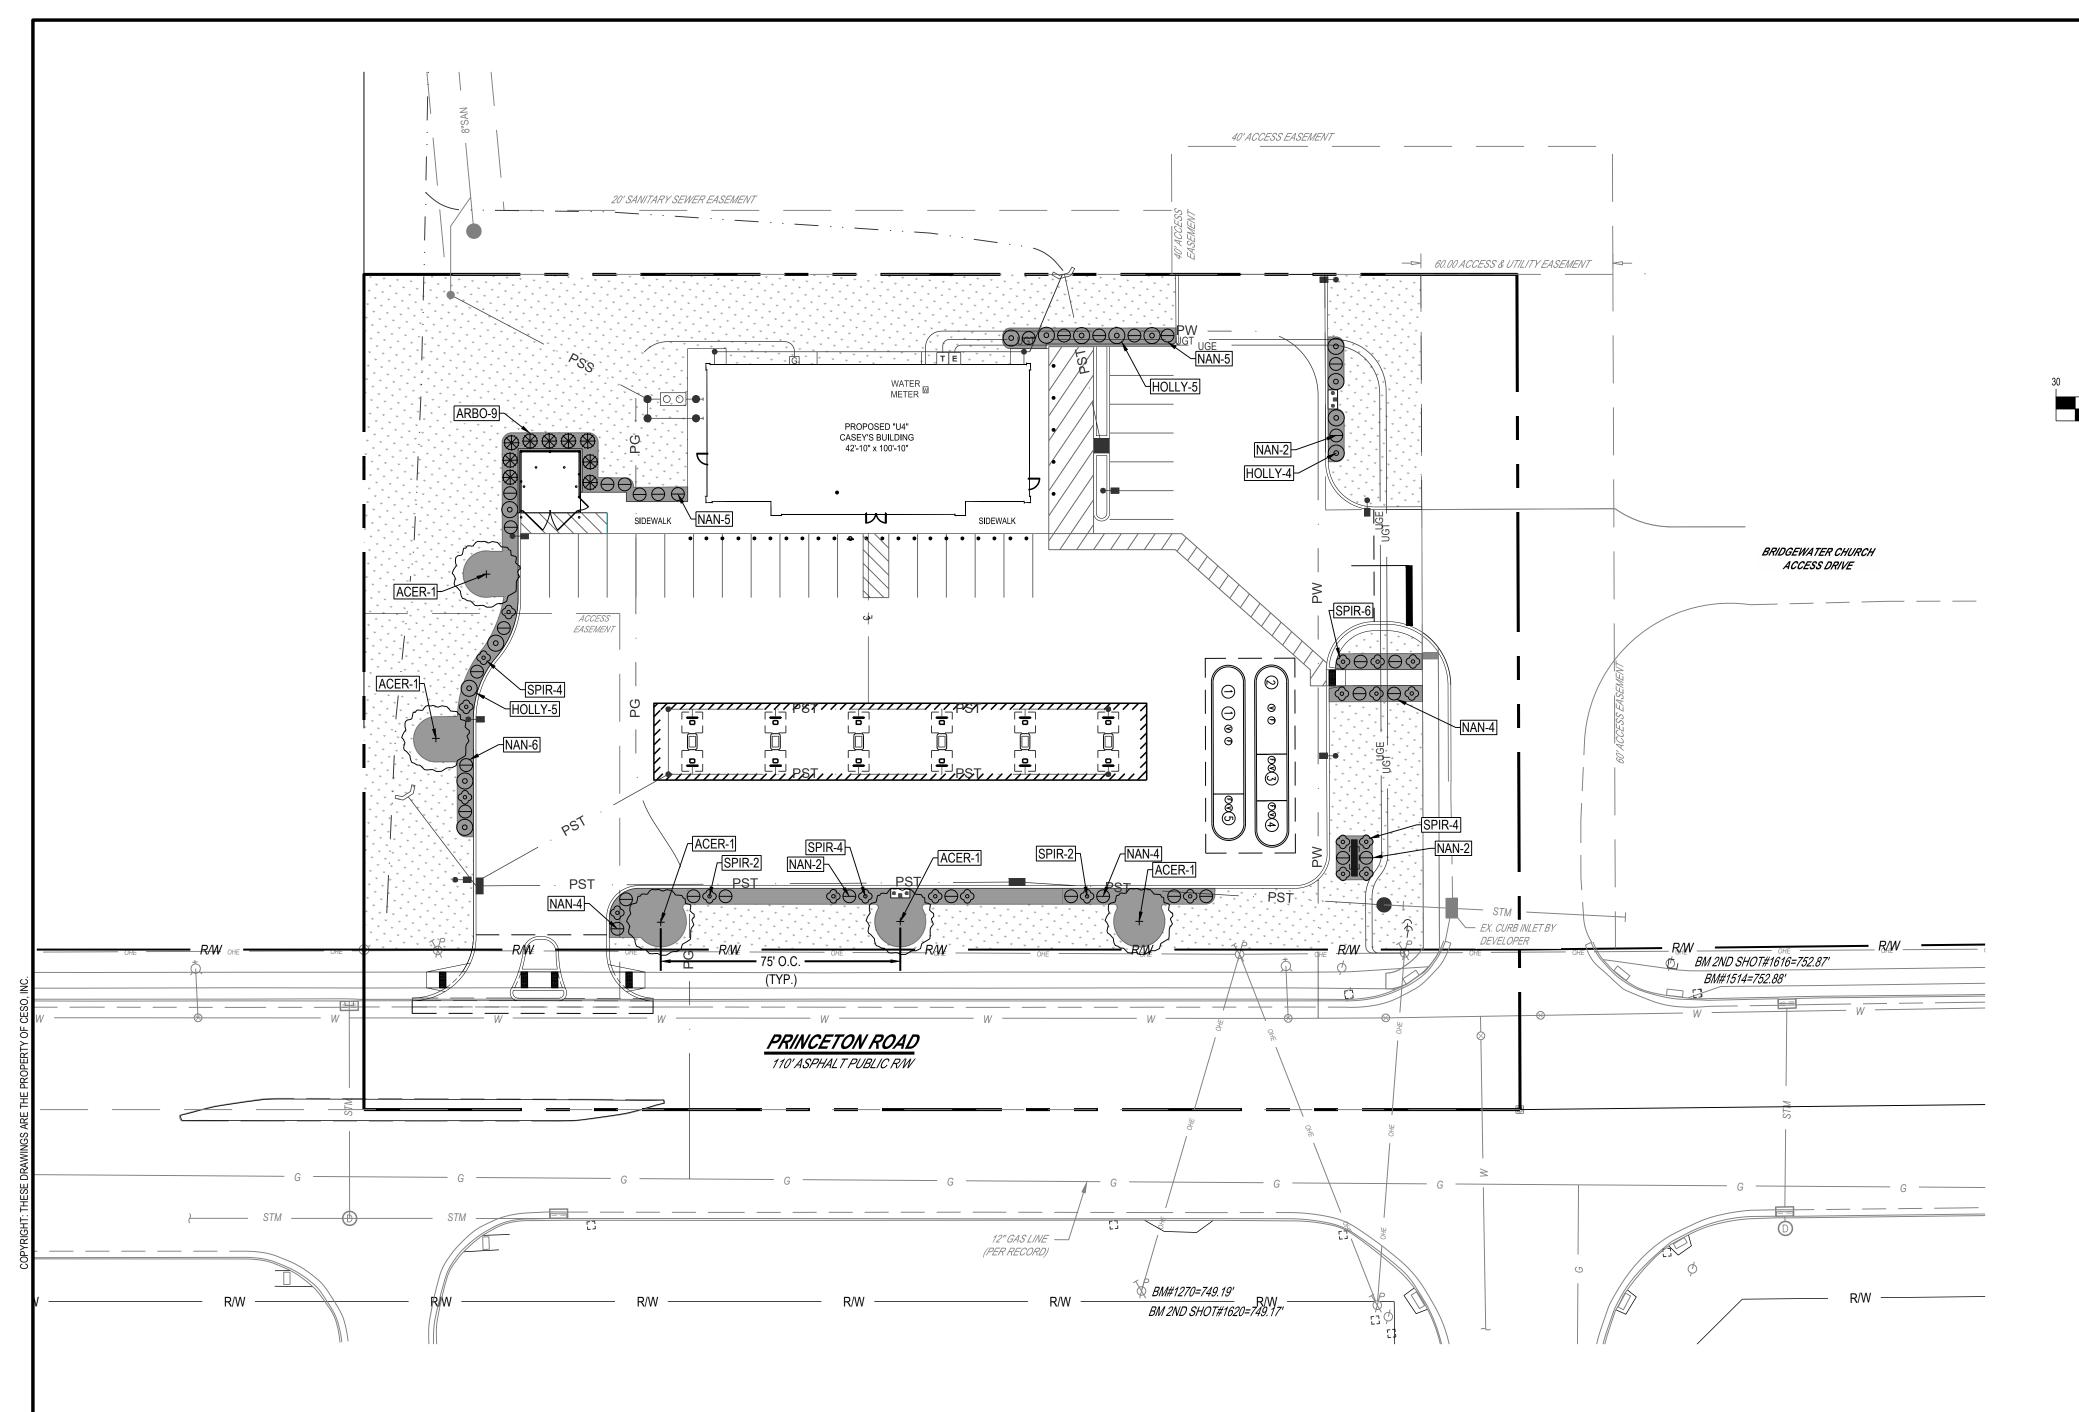


LANDSCAPING REQUIREMENTS:


1. MINIMUM GREEN SPACE: REQUIRED: 0.20 x 1.747 ACRES = 0.349 ACRES (20%) PROPOSED: 0.578 ACRES (33%)


SCREENING:

REQUIRED: SCREENING AT REAR AND SIDE LOT LINES AS APPROVED BY THE BOARD OF FAIRFIELD TOWNSHIP TRUSTEES. PROPOSED: SHRUBS AS SHOWN ON THIS SHEET. SEE PLANT MATERIAL LIST ON THIS SHEET FOR SHRUB MATURE HEIGHT AND WIDTH.


PLANT MATERIAL LIST										
SYM.	QTY.	PLANT NAME	NICKNAME	MATURE HT/SPD	SPACING	PLANTING SIZE				
SHRUBS										
\odot	14	'COMPACTA' JAPANESE HOLLY	HOLLY	6' / 6'	AS SHOWN	3 GAL.				
\bigcirc	34	'FIREPOWER' DWARF NANDINA	NAN	2.5' / 2.5'	AS SHOWN	1 GAL.				
\bigcirc	22	'GOLDFLAME' SPIREA	SPIR	3' / 4'	AS SHOWN	1 GAL.				
EVERGREEN TREES										
	9	'EMERALD GREEN' ARBORVITAE	ARBO	8' / 4'	AS SHOWN	4' TALL				
	TREES									
+	5	'TRIDENT MAPLE' ACER BUERGERIANUM	ACER	25' / 25'	AS SHOWN	2.5" CALIPER				

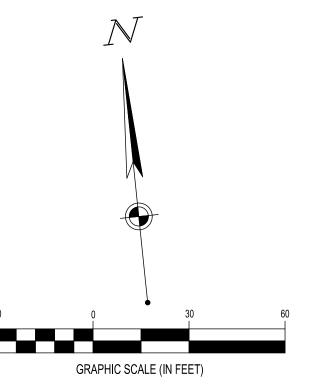

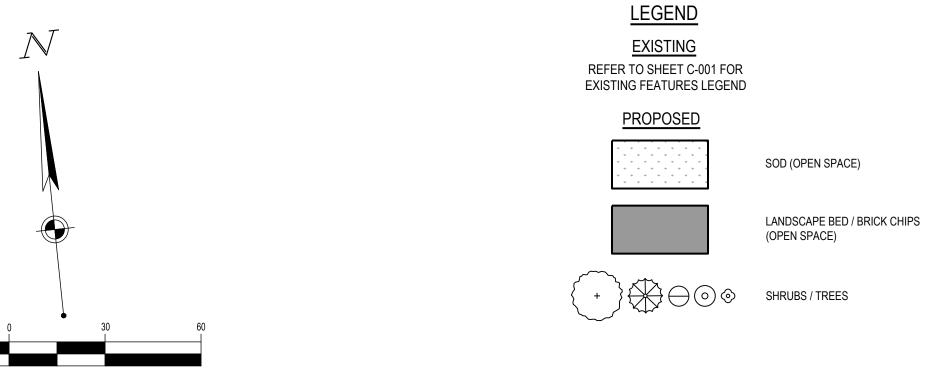

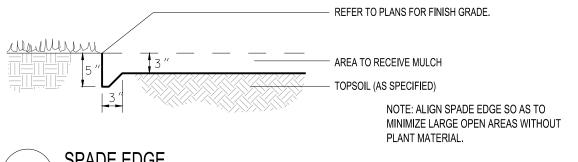



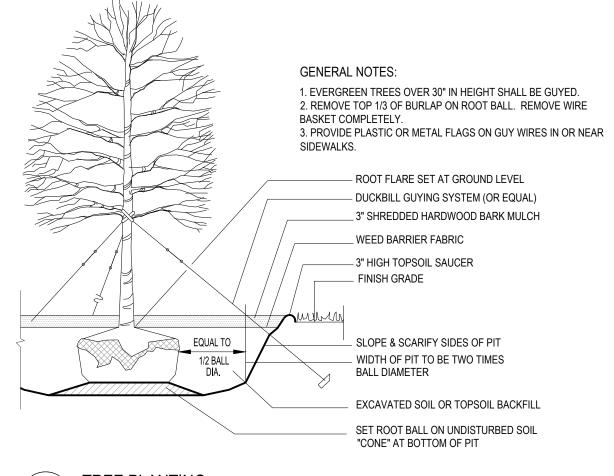

TREE PLANTING

NOTE: SEE SHRUB INSTALLATION DETAIL 8 ON SHEET C-601.



REVISION DESCRIPTION												
	•	•	•	•	•	•	•	•	•	•	•	•
DATE												
NO.	•	•	•	•	•	•	•	•	•	•	•	•





CASEY'S GENERAL

HAMILTON

LANDSCAPE PLAN

ISSUE: CIVIL PERMIT SET DATE: 05.19.2021 JOB NO.: DESIGN: DRAWN: MST CHECKED: SHEET NO.

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